

DPW 21239 ISU: PULLING COURTS SIDING AND WINDOW REPLACEMENT

756 S. 10TH AVE POCATELLO, IDAHO 83201

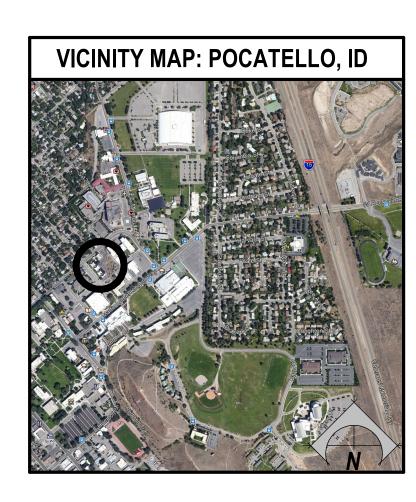


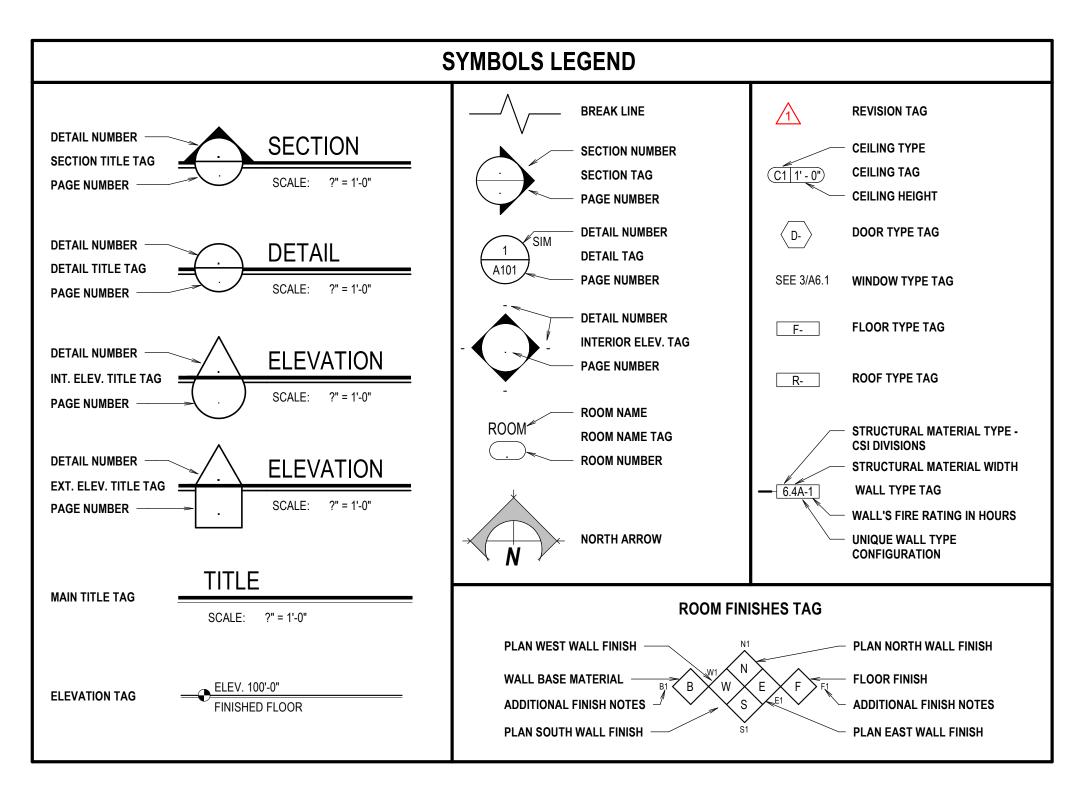

	ABBREVIATIONS
#	- NUMBER OR POUND
&	- AND
A.F.F.	- ABOVE FINISH FLOOR
AL	- ALUMINUM
ALUM.	- ALUMINUM
B.O.	- BOTTOM OF - CONCRETE MASONRY UNIT
	- CONCRETE
	- CONTINUOUS
DEMO.	- DEMOLITION OR DEMOLISH
DIA. DN	- DIAMETER - DOWN
	- FACH
	- EXTERIOR INSULATION & FINISHING SYSTEM
	- ELECTRICAL
	- ELEVATION
	- EQUAL
EQUIP.	- EQUIPMENT
EXT.	- EXTERIOR
F.F.	- FINISH FLOOR
FRP	- FIBERGLASS REINFORCED PLASTIC
GA.	- GAUGE
GYP.	- GYPSUM
H.M.	- HOLLOW METAL
HR HVAC	- HOUR - HEATING, VENTILATING, & AIR CONDITION
I.D.	- INSIDE DIAMETER
I.M.P.	- INSULATED METAL PANEL
INSUL.	- INSULATION
INT.	- INTERIOR
MAX.	- MAXIMUM
	- MECHANICAL
MFR	- MANUFACTURER
	- MINIMUM
	- NOT IN CONTRACT
NO.	- NUMBER
O.C. O.D.	- ON CENTER - OUTSIDE DIAMETER
PLY	- PLYWOOD
PLUM.	- PLUMBING
PVC	- POLYVINYL CHLORIDE
RCP	- REFLECTED CEILING PLAN
REQ'D	- REQUIRED
SIM.	- SIMILAR
SPM	- SINGLE PLY MEMBRANE
	- STORAGE
	- STRUCTURAL
T.O.	- TOP OF
TYP.	- TYPICAL
U.N.O. W/	- UNLESS NOTED OTHERWISE - WITH
W.C.	- WITH - WATER CLOSET
WD.C.	- WOOD

DRAWING INDEX			
GENERAL			
G1.0	GENERAL INFORMATION		
ARCHITECTU	JRAL		
A1.1	DEMOLITION PLANS BUILDINGS A & H		
A1.2	DEMOLITION PLANS BUILDINGS B,C,D,E,F,G,I,J		
A1.3	DEMOLITION ELEVATIONS		
A2.1	FLOOR PLANS BUILDINGS A & H		
A2.2	FLOOR PLANS BUILDINGS B,C,D,E,F,G,I,J		
A3.1	BUILDING ELEVATIONS		
A4.1	BUILDING SECTIONS		
A5.1	DETAILS		
A5.2	DETAILS		
A6.1	WINDOW DETAILS		


BUILDING CODE: IBC 2018

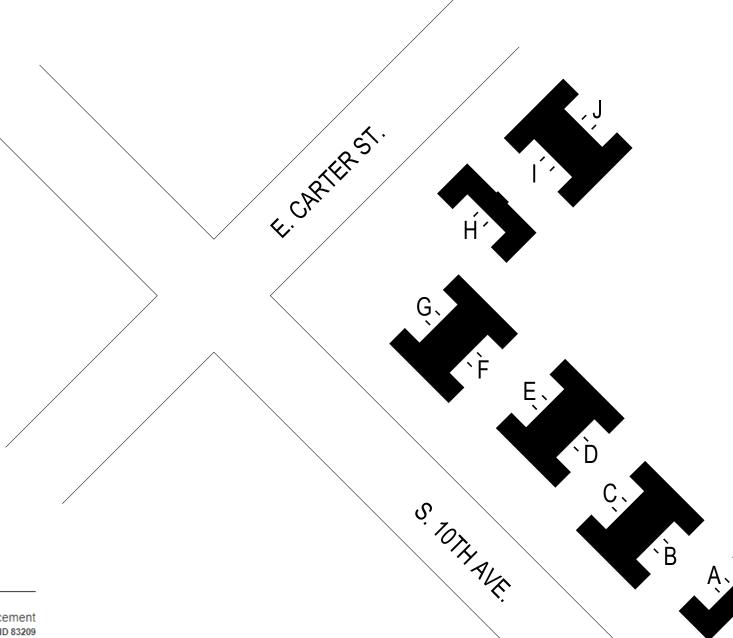

Agency Construction Approval No. 1 for project 2021239 ISU: Pulling Courts Housing Siding & Window Replacement

Created by: Martin Santoyo on 25-Aug-2021 Last Modified by: Martin Santoyo on 25-Aug-2021

2021239 ISU: Pulling Courts Housing Siding & Window Replacement

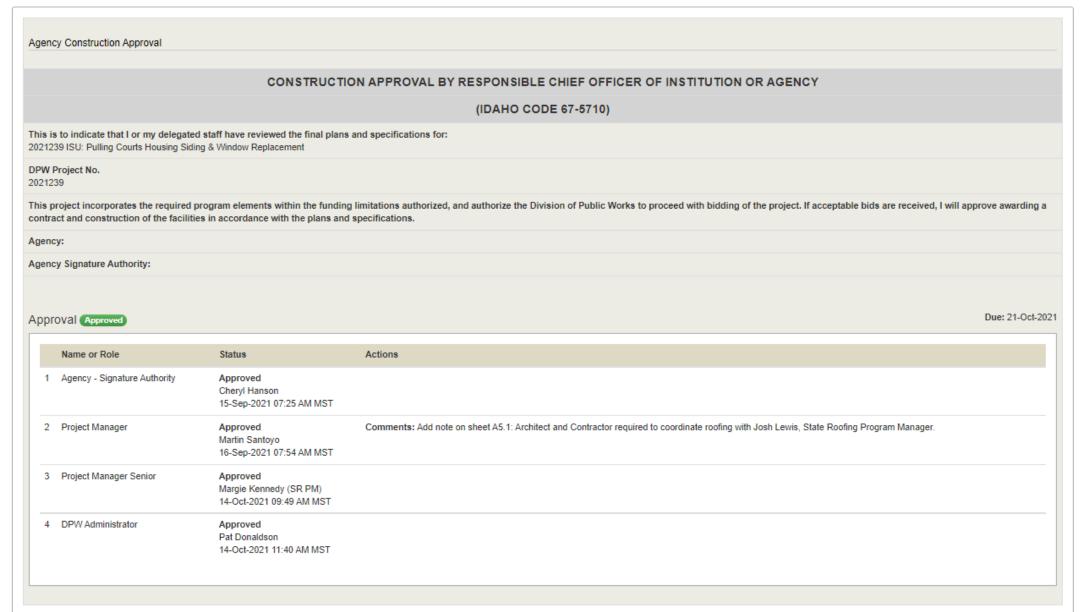

NT.	SITE REFERENCE PLAN	
* 1	SCALE: 1" = 60'-0"	

21239 ISU:


REVISIONS


PROJECT NO.

AUGUST 2021

DRAWN BY:

CHECKED BY:

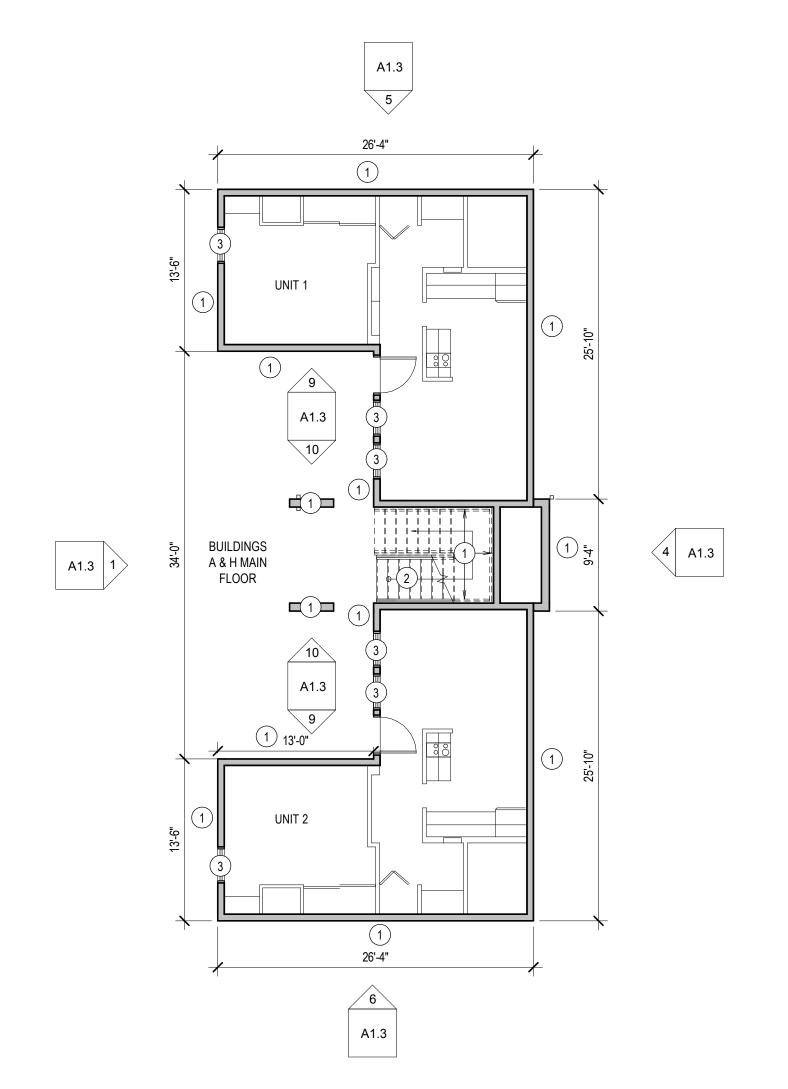

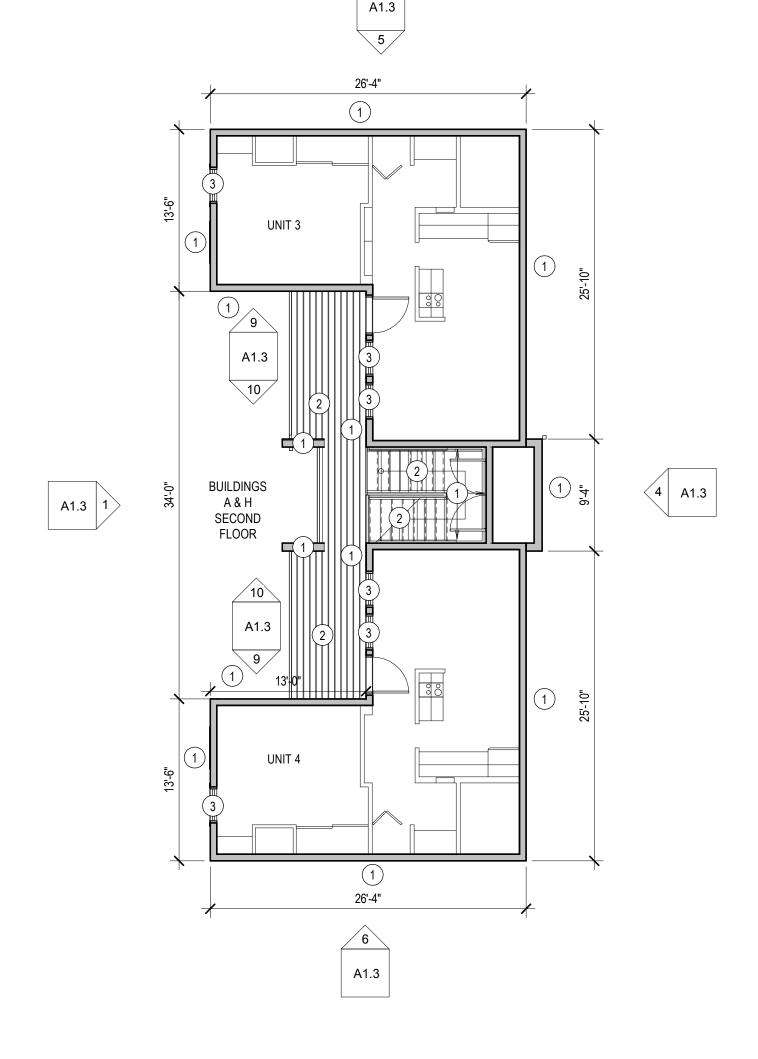

MAIN LEVEL DEMOLITION PLAN

SCALE: 1/8" = 1'-0"

SECOND LEVEL DEMOLITION PLAN

SCALE: 1/8" = 1'-0"

DEMOLITION GENERAL NOTES

- CONTRACTOR SHALL RESOLVE ALL DIMENSIONAL OR OTHER DISCREPANCIES, DURING LAYOUT WITH ARCHITECT, PRIOR TO BEGINNING CONSTRUCTION.
- WORK TO BE IN ACCORDANCE WITH CODES & ACCESSIBILITY REQUIREMENTS.
- CONTRACTOR TO REMOVE ITEMS THAT ARE ATTACHED TO, OR IMPEDE THE REMOVAL OF, THE EXISTING WOOD SIDING, TRIM AND WEATHER BARRIER, WITH THE EXCEPTION OF THE STAIRS, DECK, HANDRAILS AND SOFFIT. THESE INCLUDE, BUT ARE NOT LIMITED TO; CONDUIT, VENTS, GUTTERS, DOWNSPOUTS, PIPING, HOSE BIBBS, AIR CONDITIONERS, LIGHTS, HOSE HANGERS, BUILDING SIGNAGE, MECHANICAL UNITS, ROOF CAP/DRIP EDGE, DOOR/WINDOW TRIM, SCUPPERS, CHAIN LINK FENCE POSTS, AND WIRES.
- THE AGENCY HAD A SERVICE CONTRACTOR REVIEW THE CONDITION OF THE THE EXISTING WOOD SIDING. IT WAS NOTED THAT BEHIND THE EXISTING WOOD SIDING IS BUILDING PAPER AND WOOD SHEATHING. THEREFORE IT IS ANTICIPATED THAT EXISTING BUILDING PAPER AND WOOD SHEATHING WILL BE FOUND BEHIND THE EXISTING WOOD SIDING.
- 5. USE ISOLATION TAPE BETWEEN DIS-SIMILAR METALS.
- DISCONNECT AND REMOVE ITEMS THAT PENETRATE THE EXISTING SIDING, SO NEW SIDING CAN BE INSTALLED WITHOUT COMPLICATION. THIS INCLUDES, BUT IS NOT LIMITED TO; CONDUIT, WIRING, PIPING, VENTS, HOSE
- . PENETRATIONS TO BE SEALED AND WATERPROOFED.
- REPLACE ANY EXISTING WALL SHEATHING THAT IS DAMAGED, DETERIORATED OR DESTROYED.

DEMOLITION KEYNOTES

- REMOVE WOOD SIDING, TRIM AND WEATHER BARRIER. CAREFULLY REMOVE ANYTHING ATTACHED TO THE SIDING THAT IMPEDES ITS REMOVAL, WITH THE EXCEPTION OF THE STAIRS AND RAILING AND DECK.
- REMOVE WINDOW AND TRIM. REMOVE WOOD SILL ON THE INTERIOR OF WINDOW. CUT BACK AND MODIFY GYPSUM SURROUND AS NEEDED TO

RETAIN AND PROTECT EXTERIOR DECK, RAILING AND STAIRS.

- INSTALL NEW WINDOW. SEE SHEET A6.1 FOR DETAILS
- RETAIN AND PROTECT METAL RAILING AND WALL MOUNTED BRACKETS AT
- (5) REMOVE GUTTERS, DOWNSPOUTS AND SCUPPERS
- (6) REMOVE PARAPET CAPS.
- EXISTING MEMBRANE ROOFING TO BE CUT BACK AT THESE LOCATIONS TO ALLOW NEW SIDING TO BE INSTALLED. NEW MEMBRANE ROOFING TO OVERLAP EXISTING MEMBRANE ROOFING, SEE DETAILS ON SHEET A6.1
- (8) REMOVE EXISTING EXHAUST VENT CAP
- 9 REMOVE EXISTING WALL LOUVER

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RECHITECTURE /

990 JOHN RDRMS PARKWAY / P.D.


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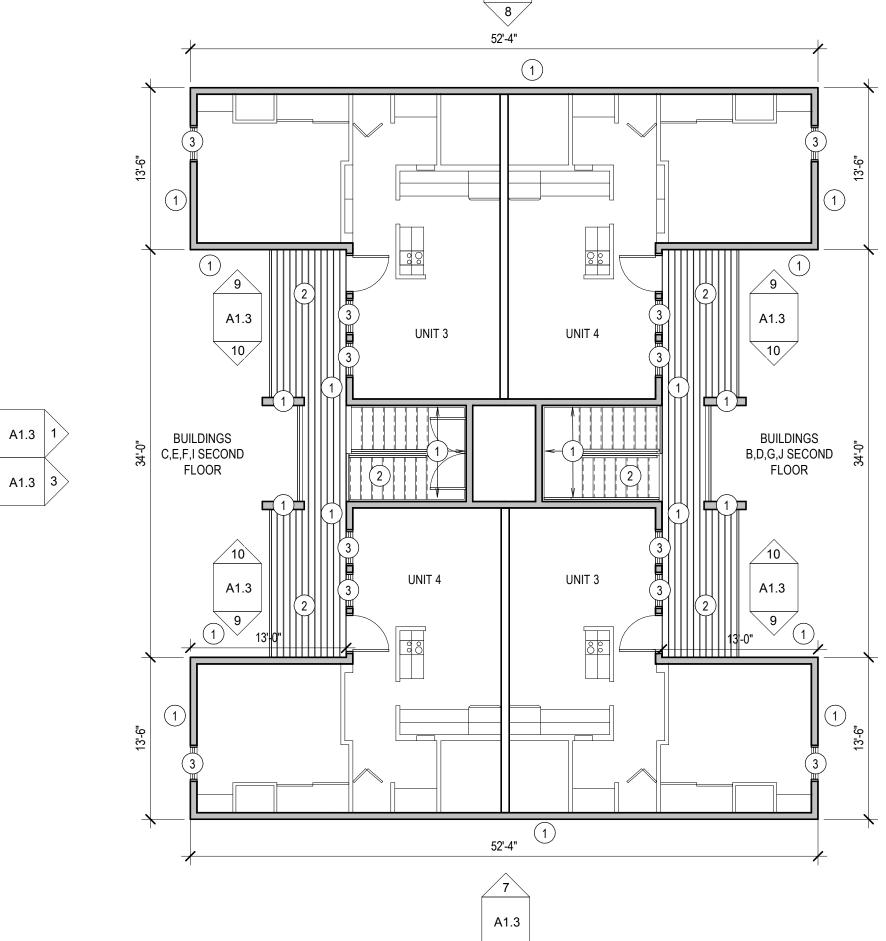
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1 AVE 4HO 83201 J: PULLING COURTS SIDING 756 S. 10TH A POCATELLO, IDAN

DPW 21239 ISU:

21001 AUGUST 2021 DRAWN BY: CHECKED BY: NBW



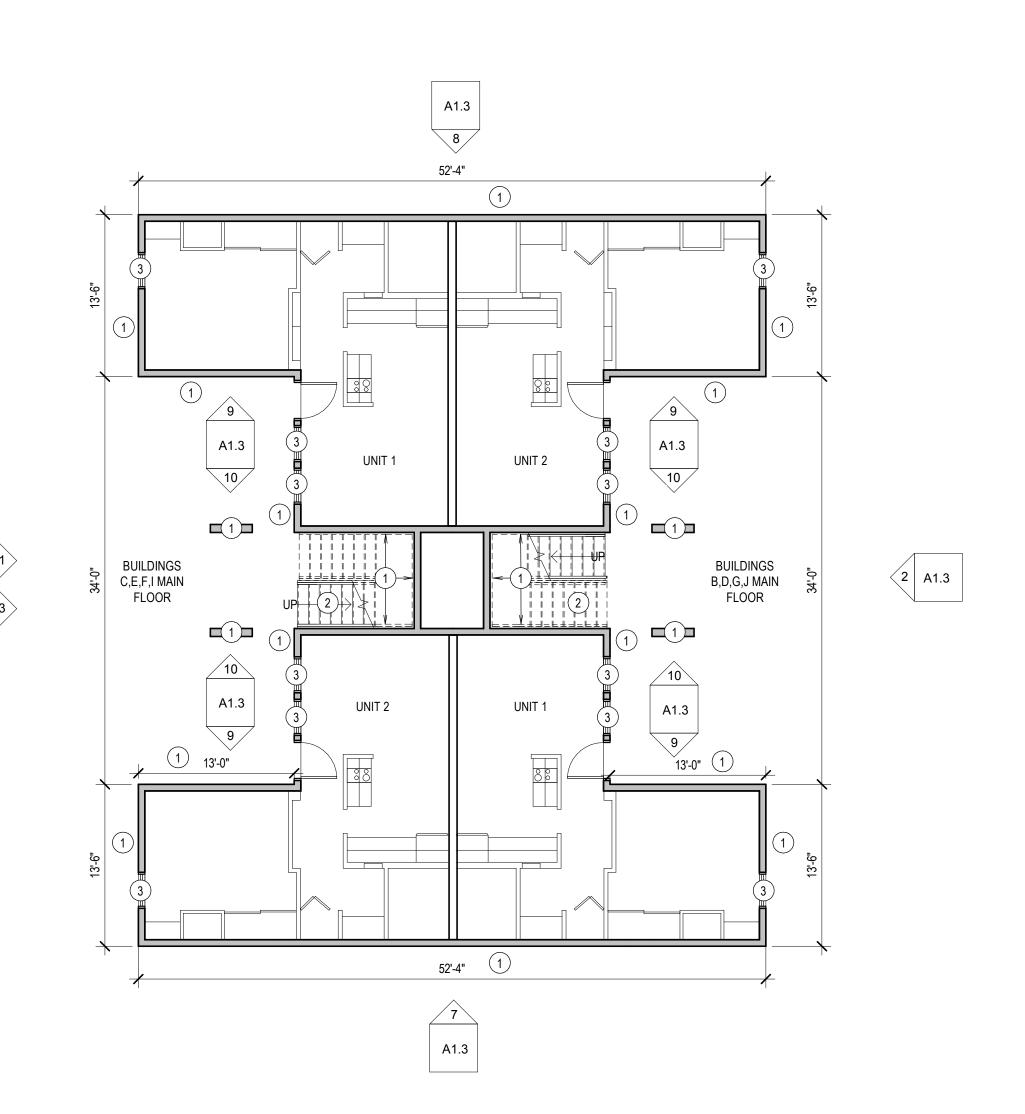

SECOND LEVEL DEMOLITION PLAN

SCALE: 1/8" = 1'-0"

DEMOLITION GENERAL NOTES

- CONTRACTOR SHALL RESOLVE ALL DIMENSIONAL OR OTHER DISCREPANCIES, DURING LAYOUT WITH ARCHITECT, PRIOR TO BEGINNING CONSTRUCTION.
- WORK TO BE IN ACCORDANCE WITH CODES & ACCESSIBILITY REQUIREMENTS.
- CONTRACTOR TO REMOVE ITEMS THAT ARE ATTACHED TO, OR IMPEDE THE REMOVAL OF, THE EXISTING WOOD SIDING, TRIM AND WEATHER BARRIER, WITH THE EXCEPTION OF THE STAIRS, DECK, HANDRAILS AND SOFFIT. THESE INCLUDE, BUT ARE NOT LIMITED TO; CONDUIT, VENTS, GUTTERS, DOWNSPOUTS, PIPING, HOSE BIBBS, AIR CONDITIONERS, LIGHTS, HOSE HANGERS, BUILDING SIGNAGE, MECHANICAL UNITS, ROOF CAP/DRIP EDGE, DOOR/WINDOW TRIM, SCUPPERS, CHAIN LINK FENCE POSTS, AND WIRES.
- THE AGENCY HAD A SERVICE CONTRACTOR REVIEW THE CONDITION OF THE THE EXISTING WOOD SIDING. IT WAS NOTED THAT BEHIND THE EXISTING WOOD SIDING IS BUILDING PAPER AND WOOD SHEATHING. THEREFORE IT IS ANTICIPATED THAT EXISTING BUILDING PAPER AND WOOD SHEATHING WILL BE FOUND BEHIND THE EXISTING WOOD SIDING.
- 5. USE ISOLATION TAPE BETWEEN DIS-SIMILAR METALS.
- DISCONNECT AND REMOVE ITEMS THAT PENETRATE THE EXISTING SIDING, SO NEW SIDING CAN BE INSTALLED WITHOUT COMPLICATION. THIS INCLUDES, BUT IS NOT LIMITED TO; CONDUIT, WIRING, PIPING, VENTS, HOSE

PENETRATION FINANCIES

- REPLACE WYSEXISTING WALL SHEATHING LEW BARRIEM CAREFULLY PREMOVE ANYTHING ATTACHED TO THE SIDING THAT IMPEDES ITS
- RETAIN AND PROTECT EXTERIOR DECK, RAILING AND STAIRS.
- REMOVE WINDOW AND TRIM. REMOVE WOOD SILL ON THE INTERIOR OF WINDOW. CUT BACK AND MODIFY GYPSUM SURROUND AS NEEDED TO INSTALL NEW WINDOW. SEE SHEET A6.1 FOR DETAILS
- RETAIN AND PROTECT METAL RAILING AND WALL MOUNTED BRACKETS AT
- (5) REMOVE GUTTERS, DOWNSPOUTS AND SCUPPERS
- (6) REMOVE PARAPET CAPS.
- EXISTING MEMBRANE ROOFING TO BE CUT BACK AT THESE LOCATIONS TO ALLOW NEW SIDING TO BE INSTALLED. NEW MEMBRANE ROOFING TO OVERLAP EXISTING MEMBRANE ROOFING, SEE DETAILS ON SHEET A6.1
- (8) REMOVE EXISTING EXHAUST VENT CAP
- 9 REMOVE EXISTING WALL LOUVER

AND WINDOW

A B C H I T E C T U R E / P L A N H I P O JOHN ADAMS PARKWAY / P.O. BOX 2212 / 101 (P) 208.522.8779 (F) 208.522.8785 (

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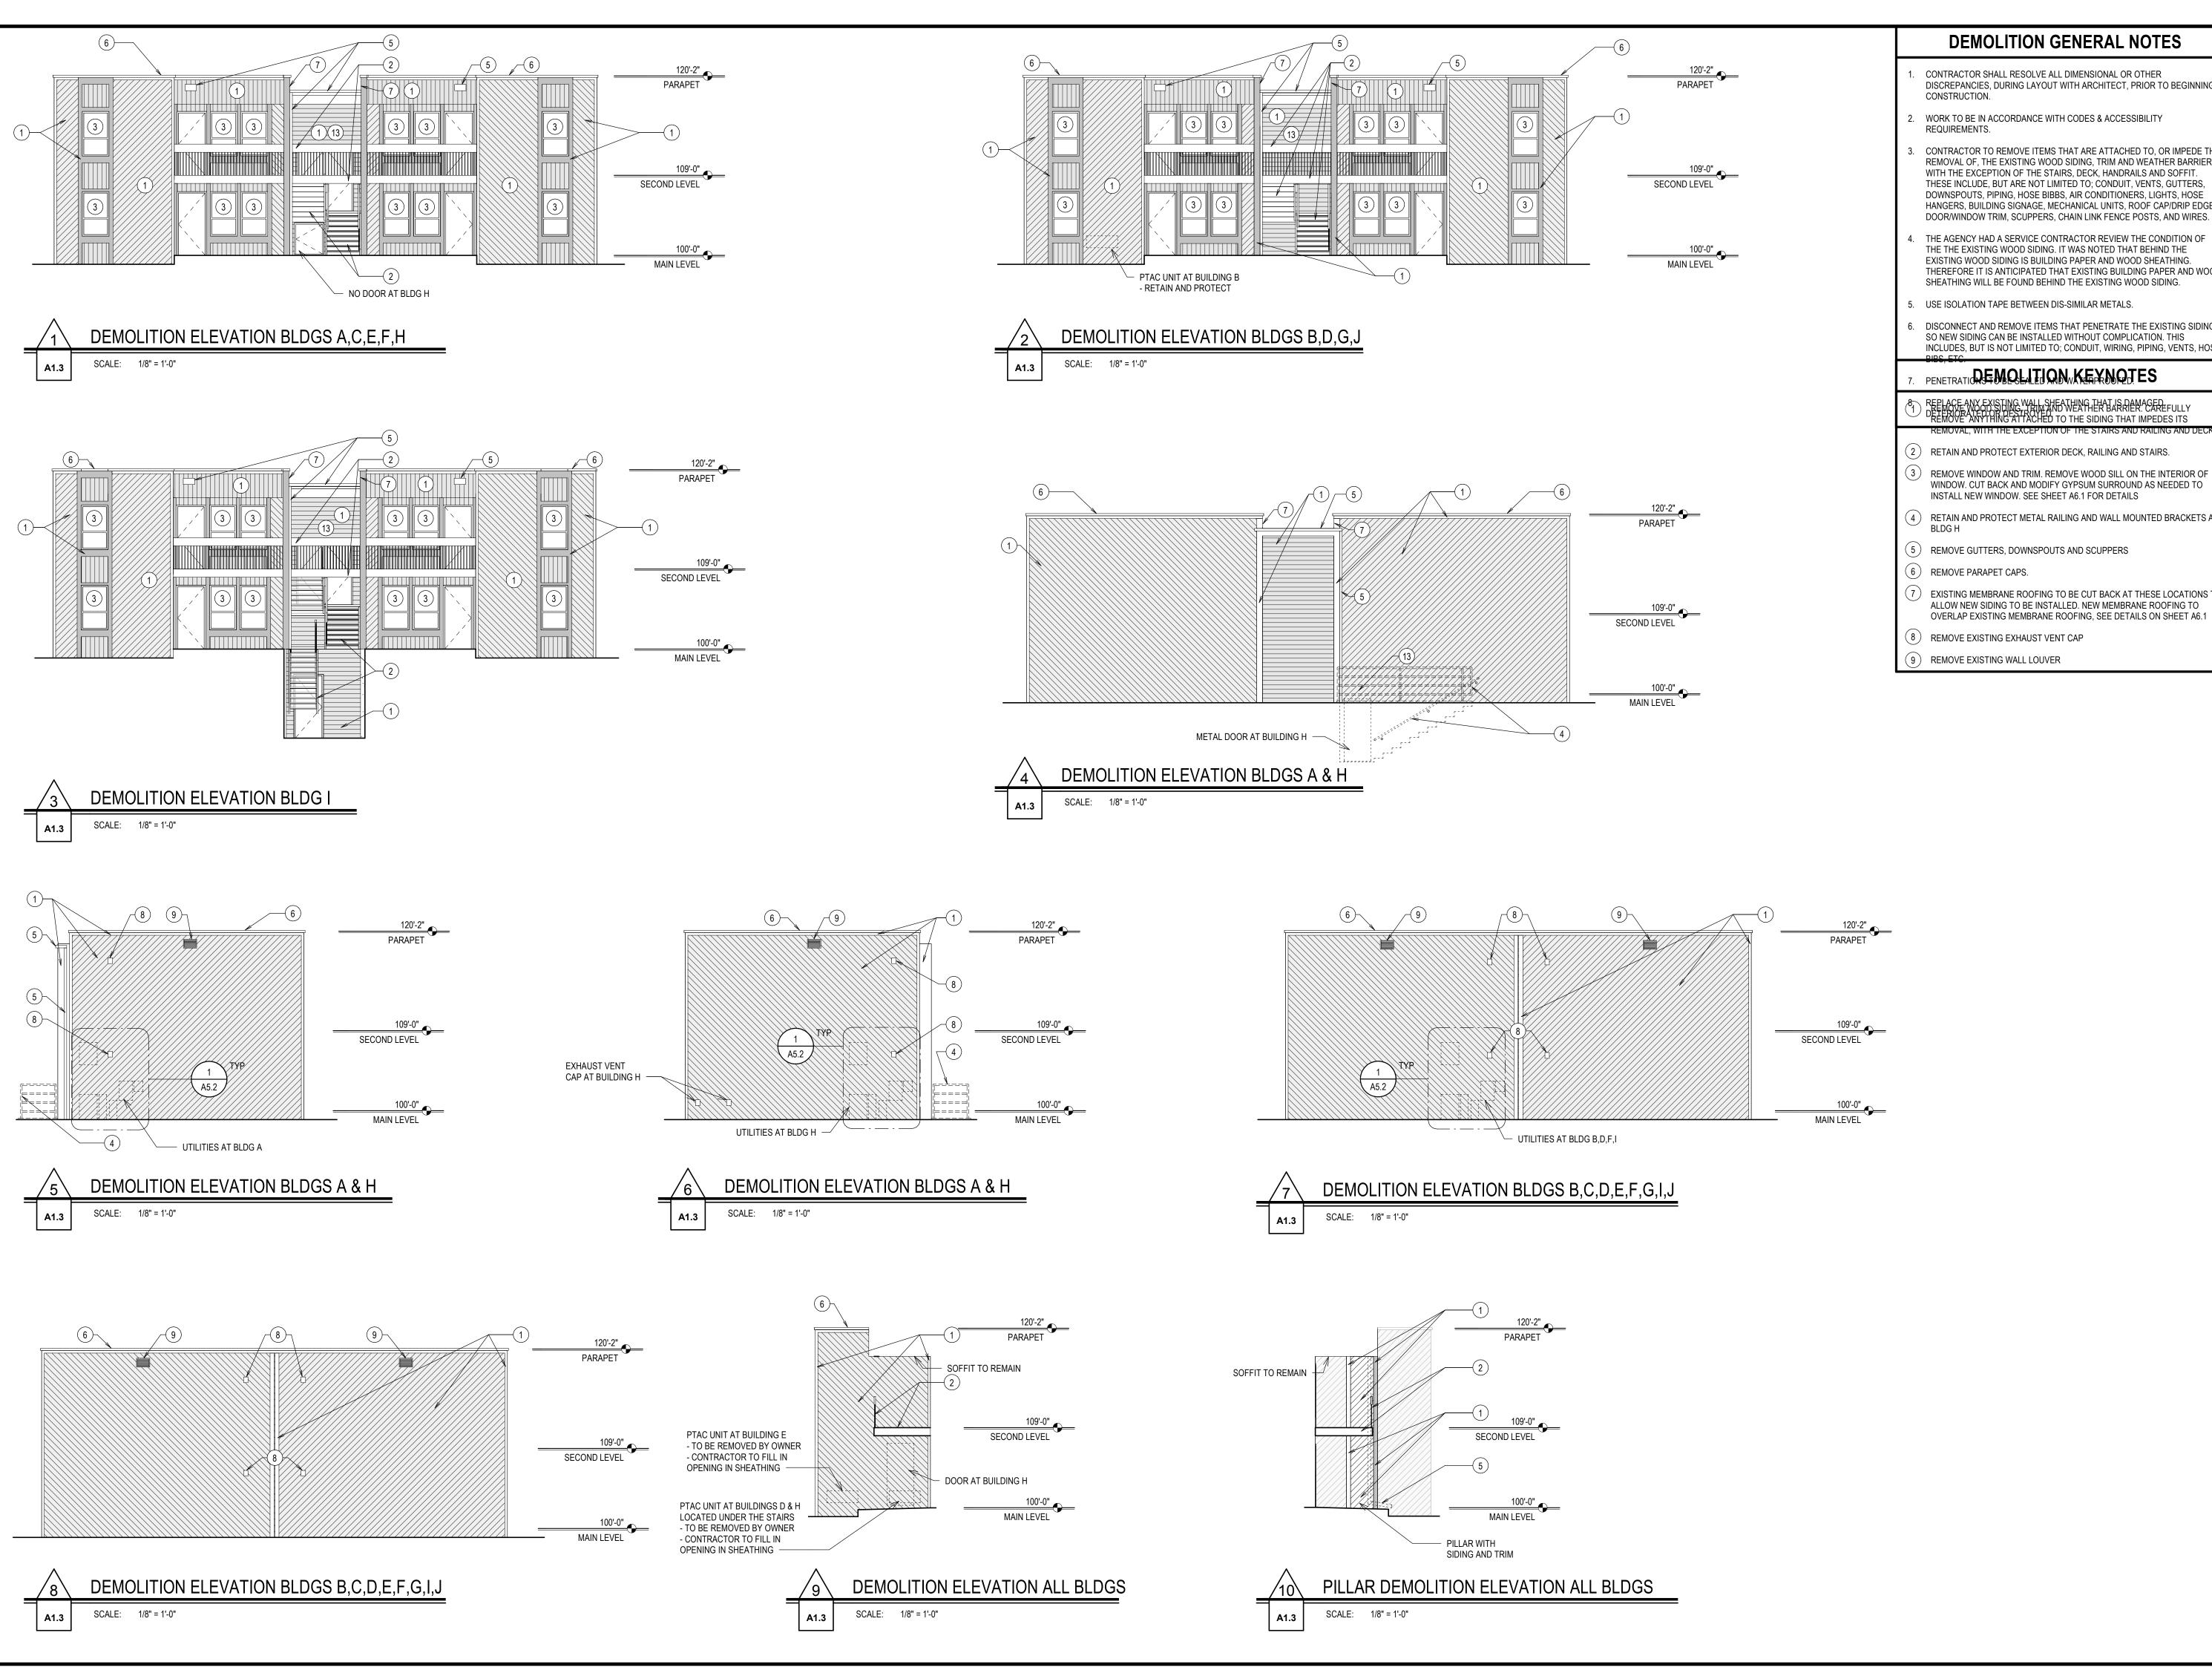
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AUGUST 2021 DRAWN BY: CHECKED BY:

DRAWING NO.:

SCALE: 1/8" = 1'-0"

MAIN LEVEL DEMOLITION PLAN



DEMOLITION GENERAL NOTES CONTRACTOR SHALL RESOLVE ALL DIMENSIONAL OR OTHER DISCREPANCIES, DURING LAYOUT WITH ARCHITECT, PRIOR TO BEGINNING

WORK TO BE IN ACCORDANCE WITH CODES & ACCESSIBILITY

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THE AGENCY HAD A SERVICE CONTRACTOR REVIEW THE CONDITION OF THE THE EXISTING WOOD SIDING. IT WAS NOTED THAT BEHIND THE EXISTING WOOD SIDING IS BUILDING PAPER AND WOOD SHEATHING. THEREFORE IT IS ANTICIPATED THAT EXISTING BUILDING PAPER AND WOOD SHEATHING WILL BE FOUND BEHIND THE EXISTING WOOD SIDING.

USE ISOLATION TAPE BETWEEN DIS-SIMILAR METALS.

DISCONNECT AND REMOVE ITEMS THAT PENETRATE THE EXISTING SIDING, SO NEW SIDING CAN BE INSTALLED WITHOUT COMPLICATION. THIS INCLUDES, BUT IS NOT LIMITED TO; CONDUIT, WIRING, PIPING, VENTS, HOSE

PENETRATION FINANCIES

- REPLACE MY EXISTING WALL SHEATHENGLER BARREN CEREFULLY DREMOVE ARYTHING ATTACHED TO THE SIDING THAT IMPEDES ITS
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AND WINDOW

): PULLING COURTS SIDING 756 S. 10TH / POCATELLO, IDAH

DPW 21239 ISU:

REVISIONS

PROJECT NO. 21001 DATE: AUGUST 2021 DRAWN BY:

NBW DRAWING NO.:

NBW

CHECKED BY:

GENERAL NOTES

1 NEW VINYL SIDING - COLOR 1

KEYNOTES


AND WINDOW 1 AVE 4HO 83201

DPW 21239 ISU: PULLING COURTS SIDIN 756 S. 10TH POCATELLO, IDA

REVISIONS

PROJECT NO.

21001 DATE: AUGUST 2021 DRAWN BY: CHECKED BY:

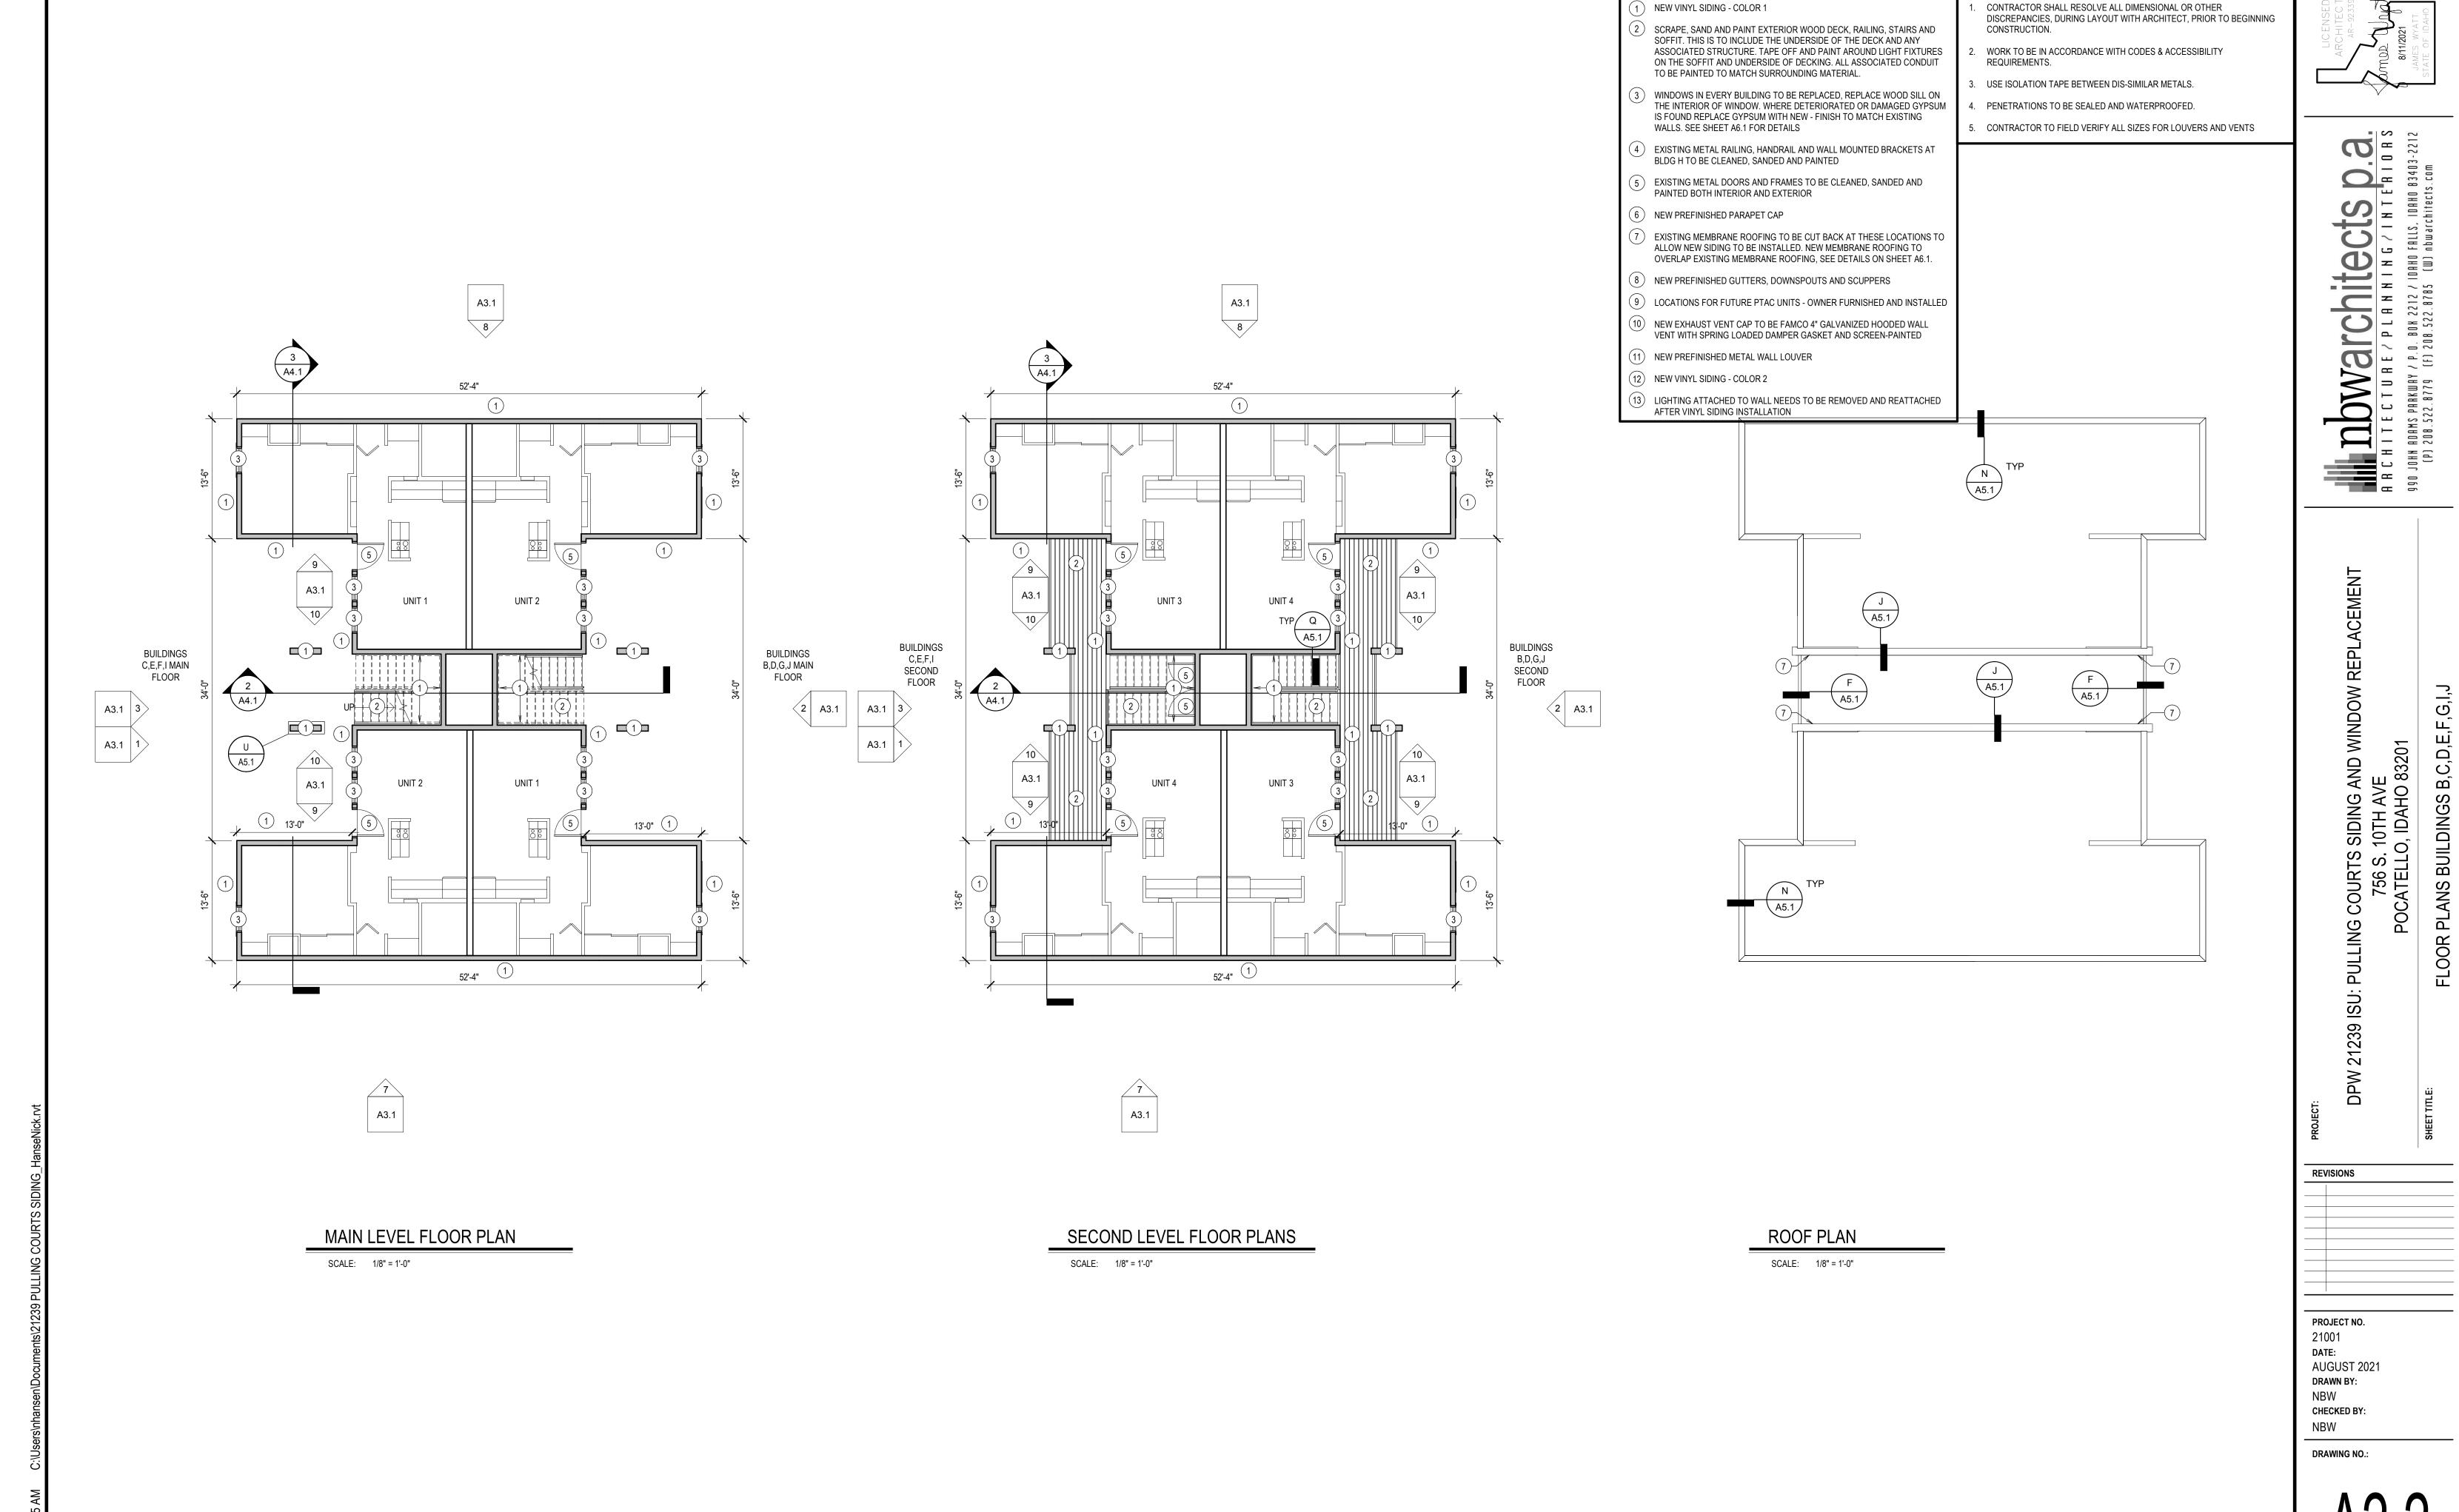

GENERAL NOTES


KEYNOTES



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J: PULLING COURTS SIDING 756 S. 10TH A POCATELLO, IDAH

PROJECT NO. AUGUST 2021

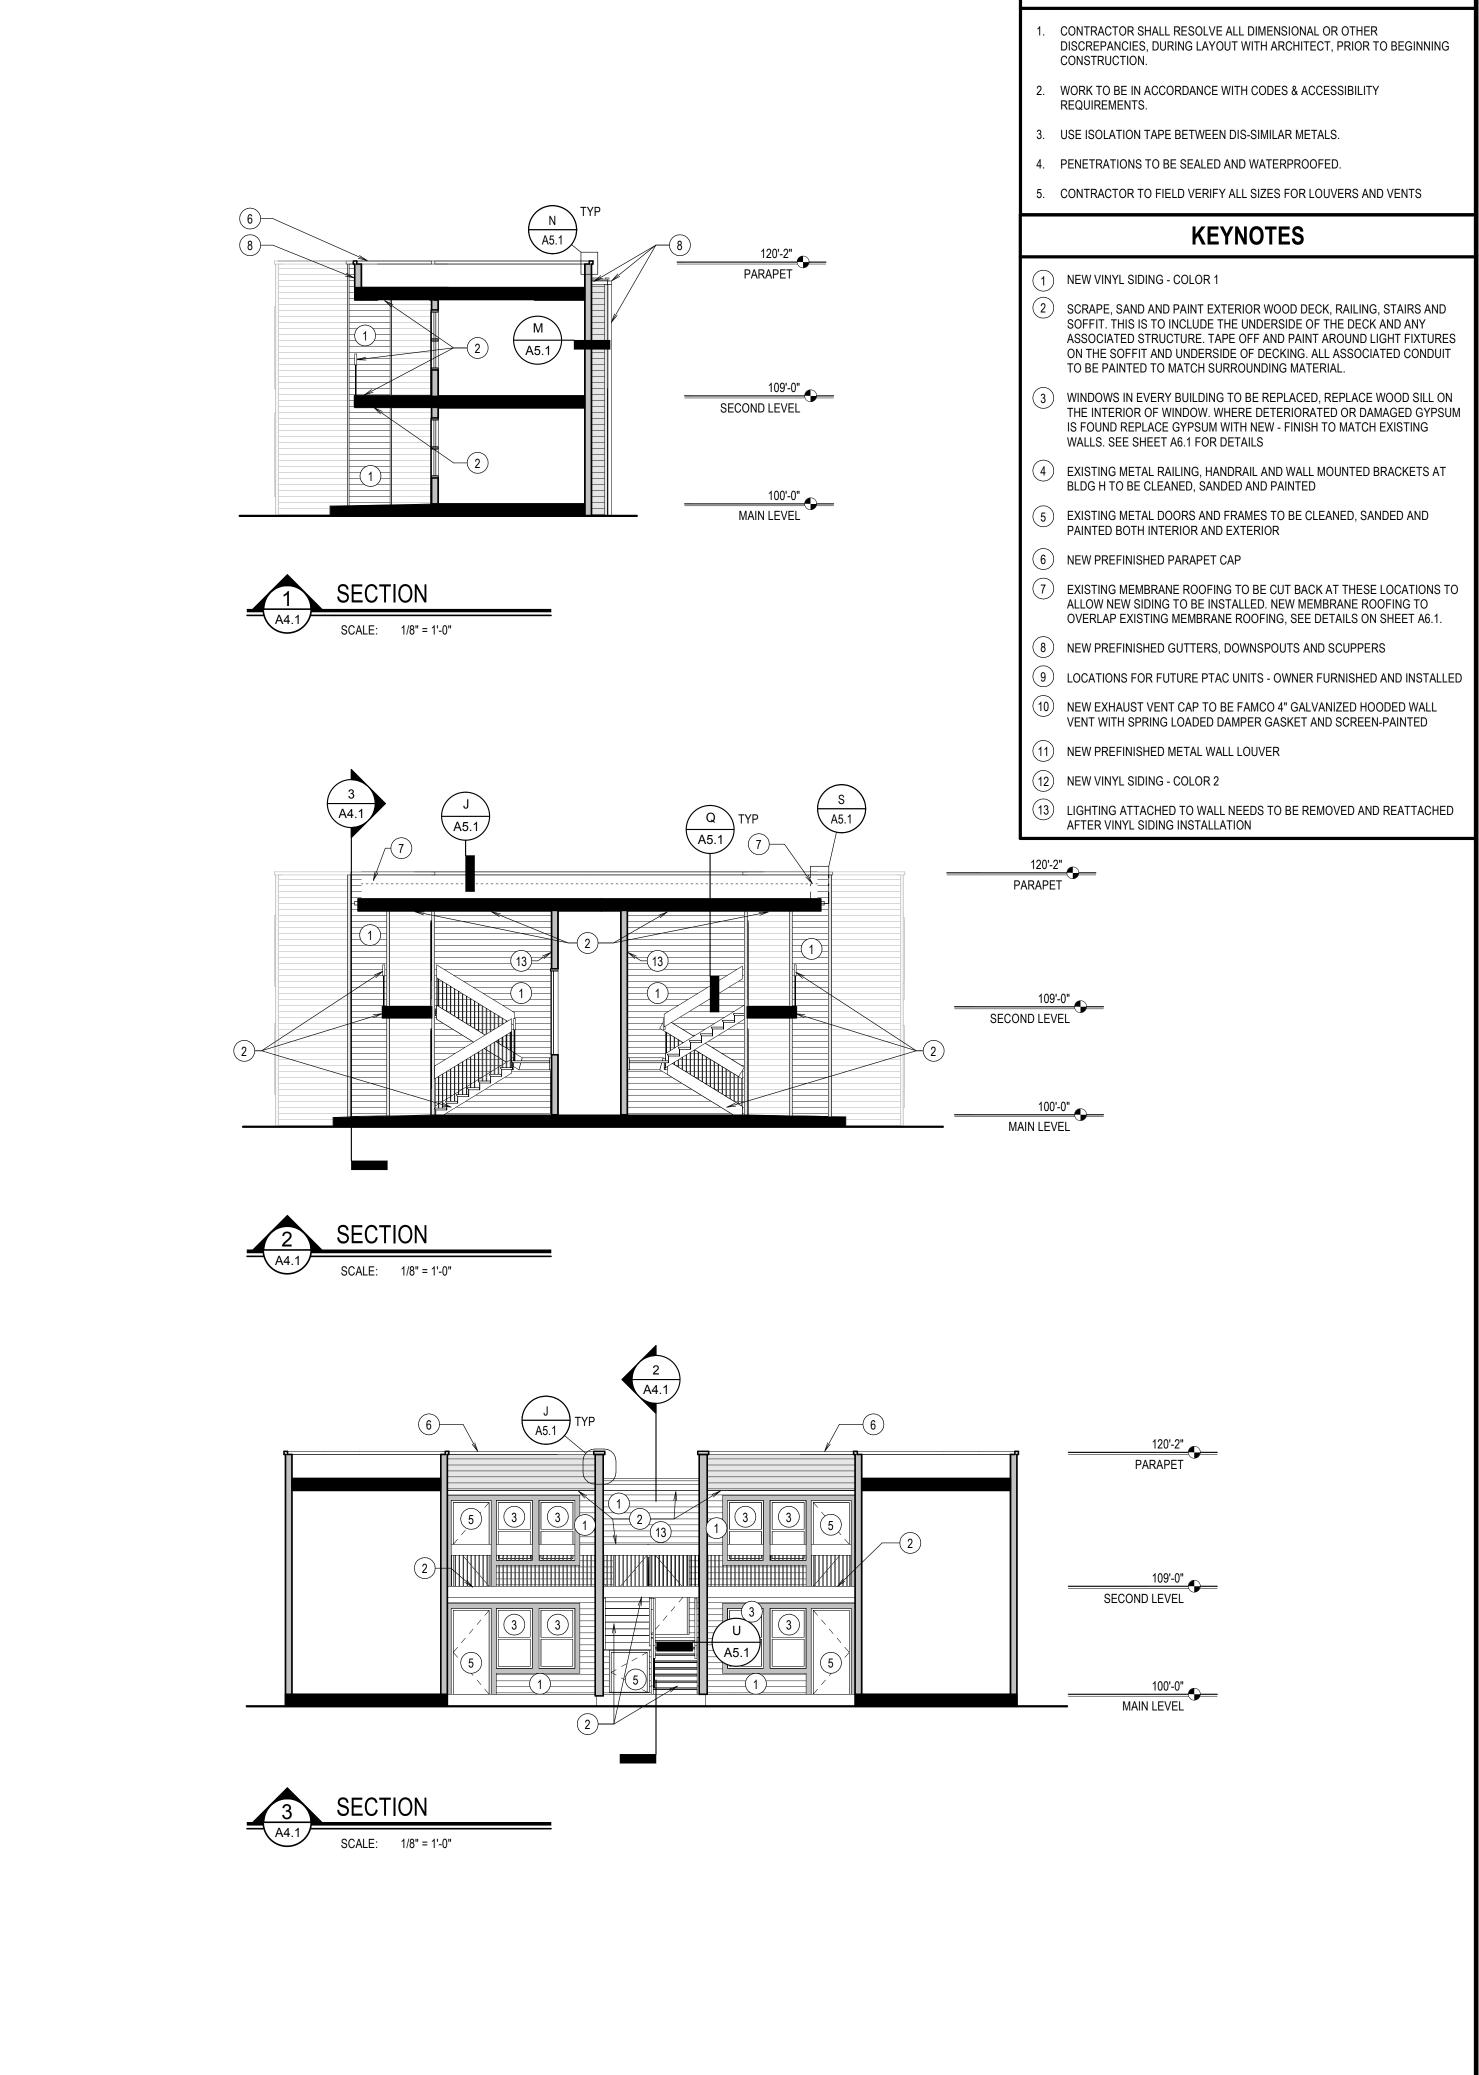

GENERAL NOTES

DWarchitects D.a.

RRCHITECTURE/PLANNING/INTERIORS

990 JOHN RDRMS PARKWAY / P.O. BOX 2212 / IDRHO FALLS, IDRHO 83403-2212

(P) 208.522.8779 (F) 208.522.8785 (W) nbwarchitects.com


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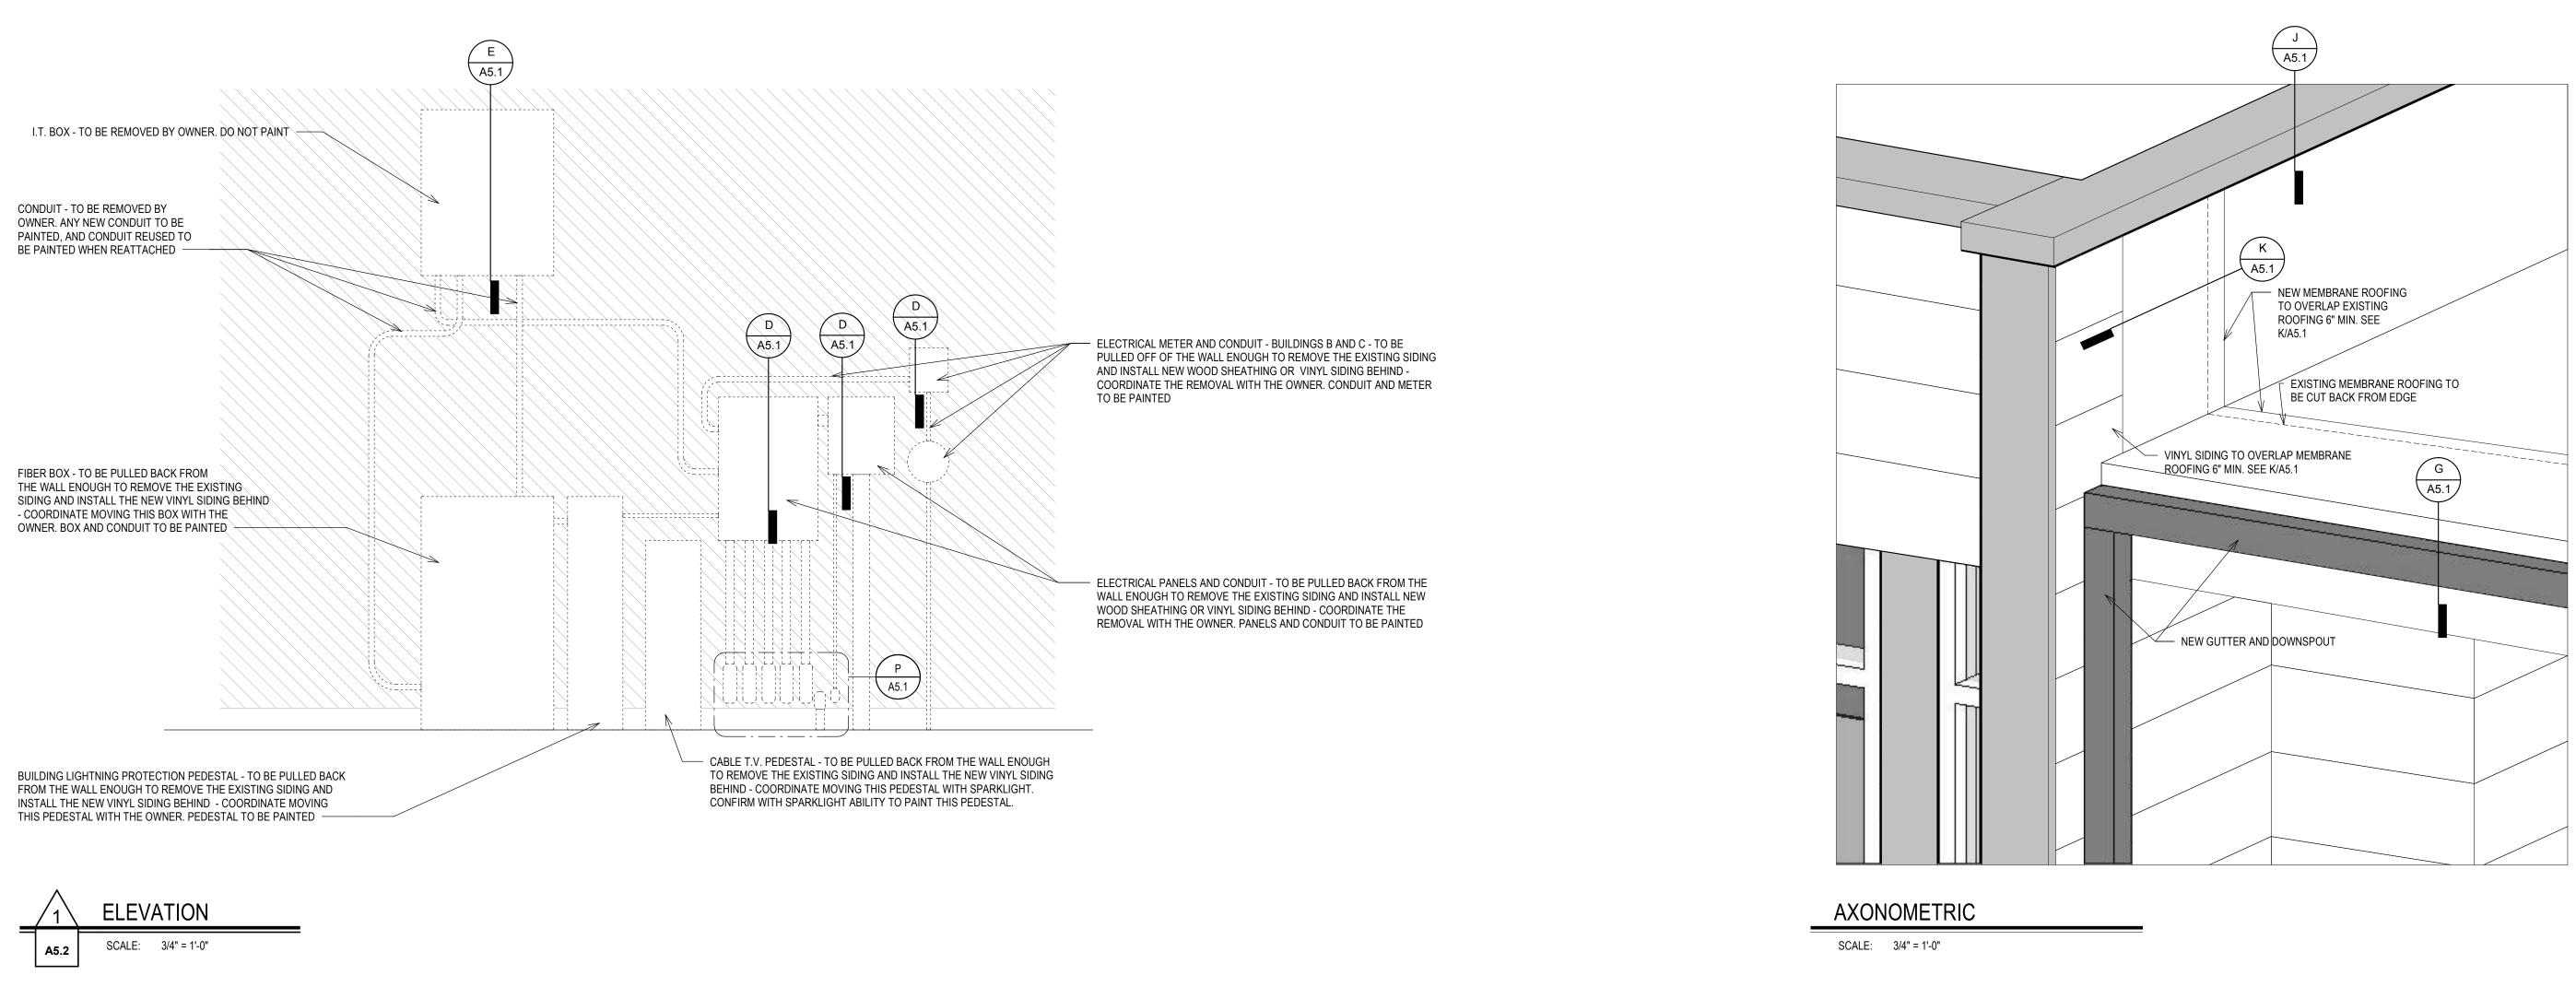
IG AND WINDOW REPL

DPW 21239 ISU: PULLING COURTS SIDING AND WI 756 S. 10TH AVE POCATELLO, IDAHO 83201 BUILDING SEC

REVISIONS

PROJECT NO. 21001 DATE: AUGUST 2021 DRAWN BY: NBW CHECKED BY:



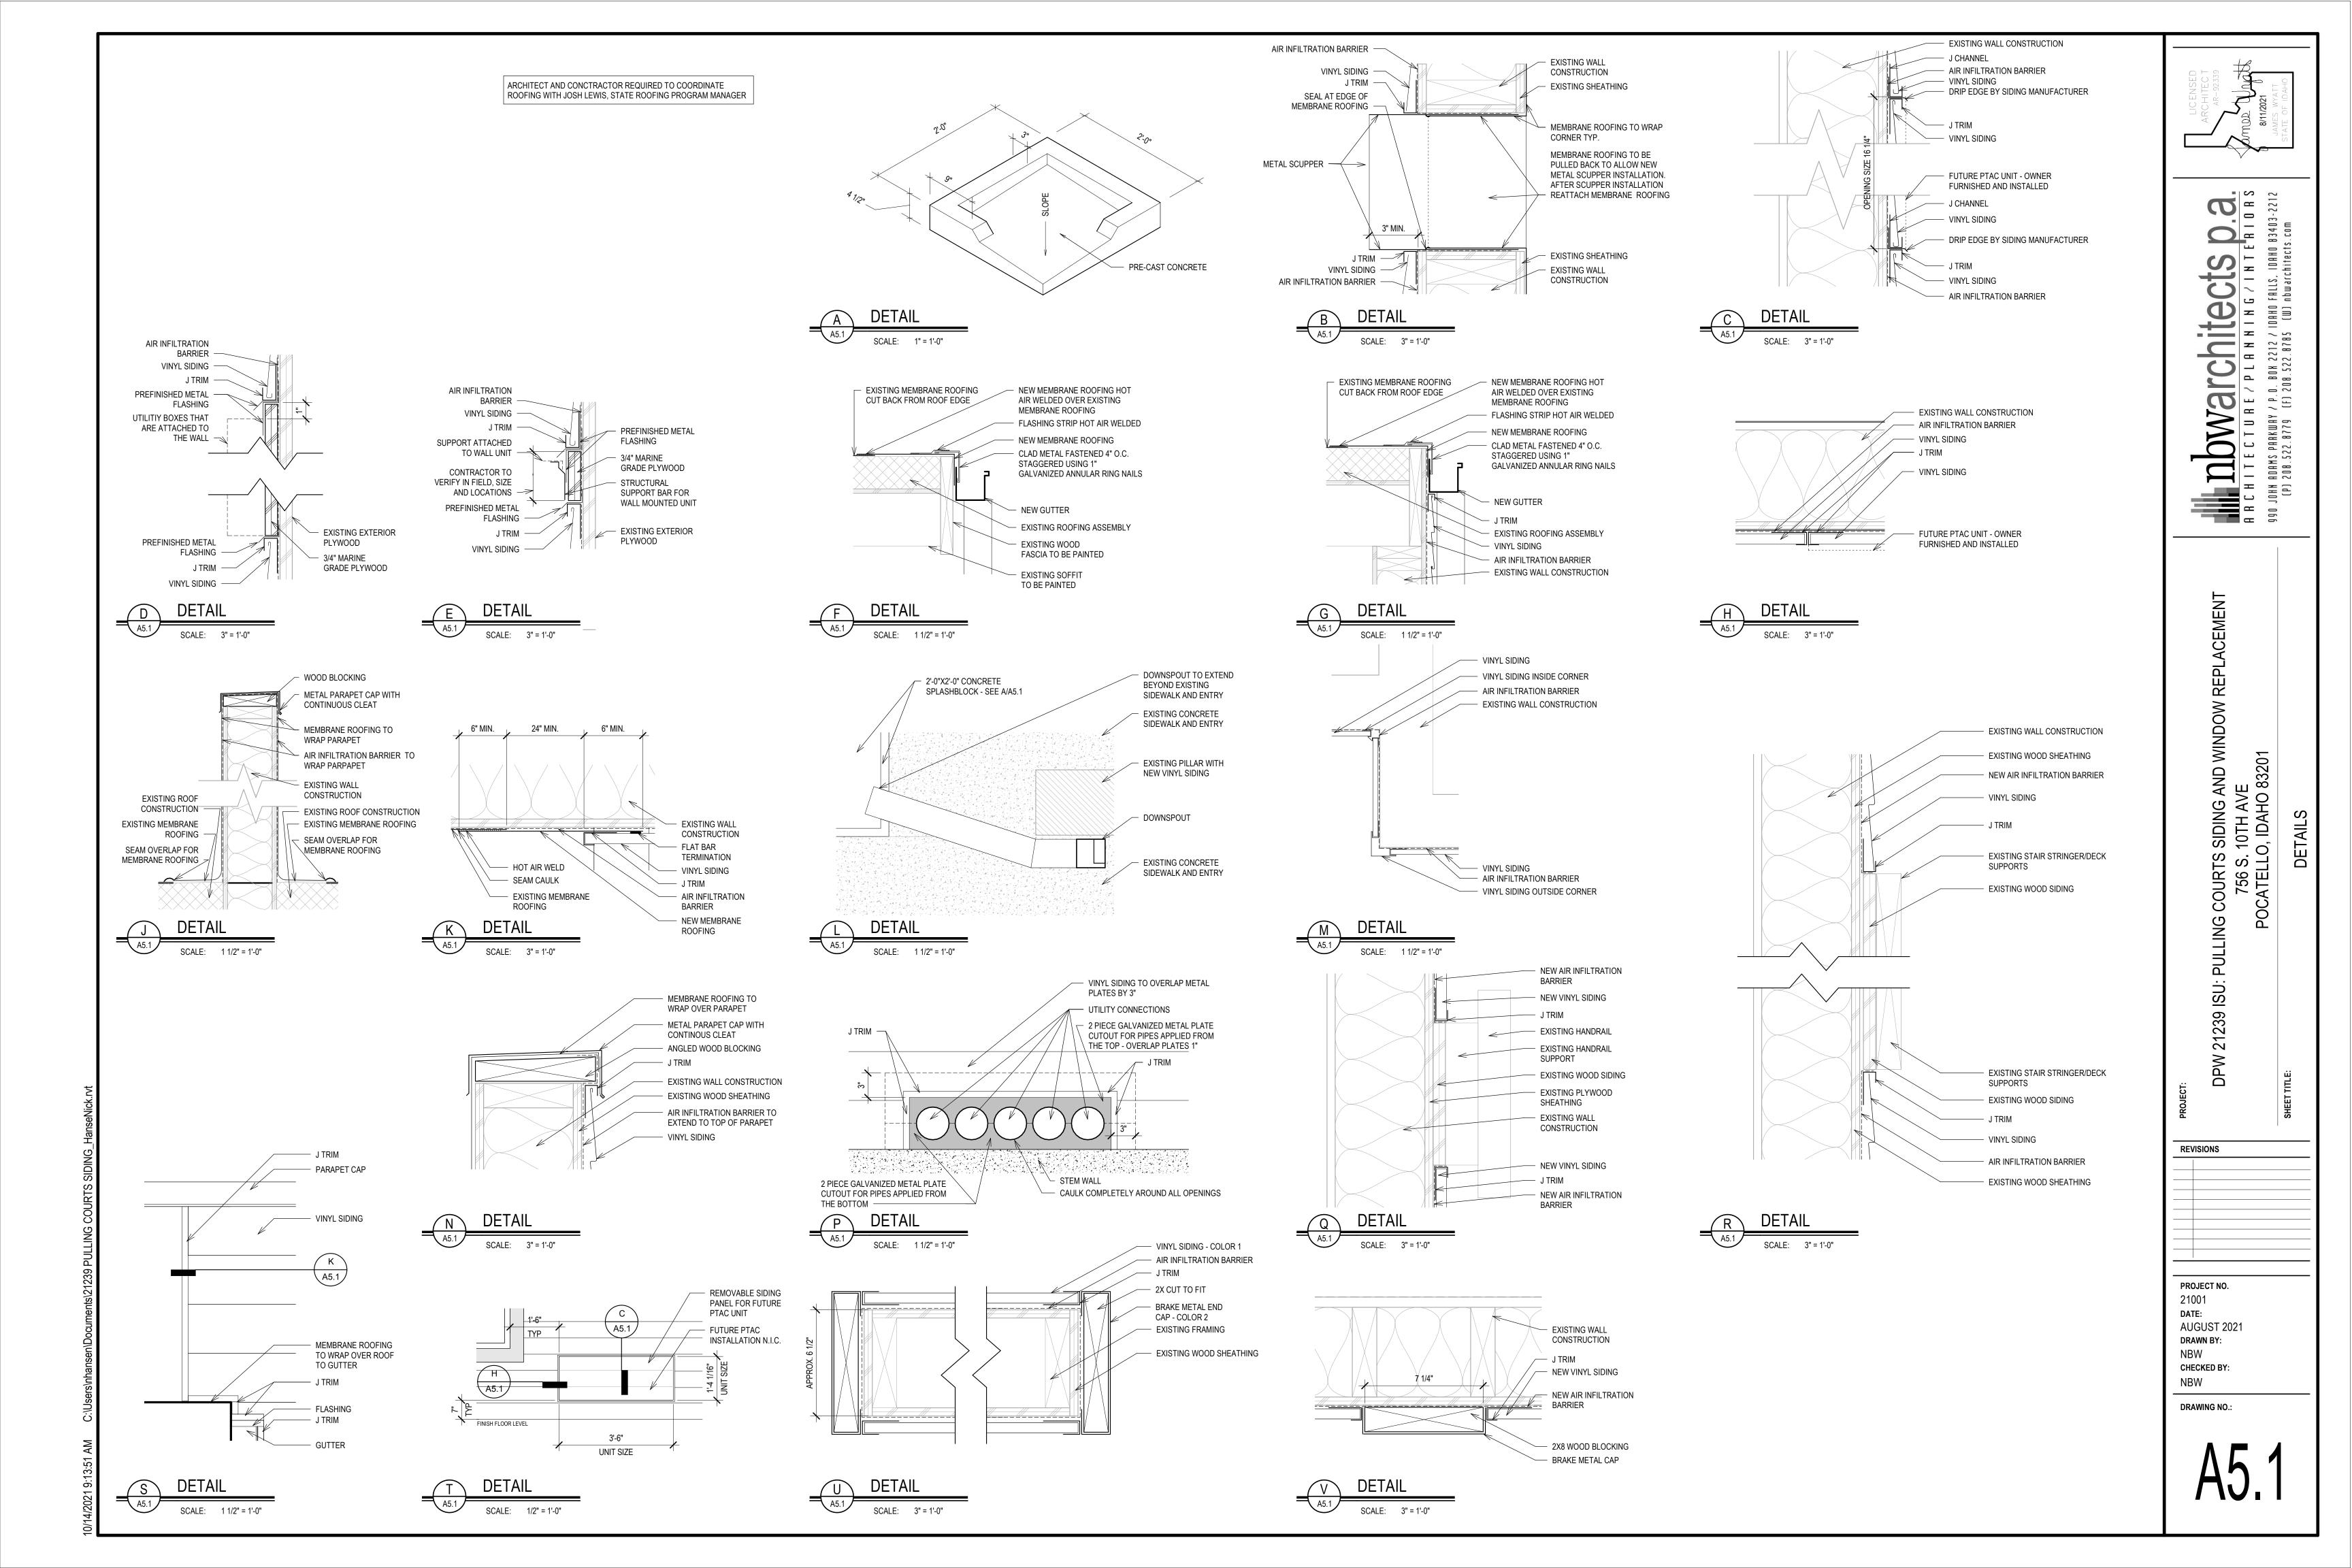

PULLING COURTS SIDING AND WINDOW REPL 756 S. 10TH AVE POCATELLO, IDAHO 83201

DPW 21239 ISU:

PROJECT NO. AUGUST 2021 NBW CHECKED BY:

3'-0" | 5'-0" | METAL CLAD WOOD | A/A6.1 | B/A6.1 & C/A6.1 | D/A6.1

J2-3 3'-0" 5'-0" METAL CLAD WOOD A/A6.1 B/A6.1 & C/A6.1 D/A6.1


WINDOW SCHEDULE									
WINDOW MARK	SI	ZE	FRAME		DETAILS				
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00	끝	분	ĒR	9	<u>m</u>				
N N	WIDTH	HEIGHT	MATERIAL	HEAD	JAMB	SILL			
SECOND LEVEL									
A3-1	3'-0"	5'-0"	METAL CLAD WOOD	A/A6.1	B/A6.1 & C/A6.1	D/A6.			
A3-1	3'-0"	5'-0"	METAL CLAD WOOD	A/A6.1	B/A6.1 & C/A6.1	D/A6.			
A3-2 A3-3	3'-0"	5'-0"	METAL CLAD WOOD	A/A6.1	B/A6.1 & C/A6.1	D/A6.			
A3-3 A4-1	3'-0"	5'-0"	METAL CLAD WOOD	A/A6.1	B/A6.1 & C/A6.1	D/A6.			
A4-1 A4-2	3'-0"	5'-0"	METAL CLAD WOOD	A/A6.1	B/A6.1 & C/A6.1	D/A6.			
		5'-0"							
A4-3 B3-1	3'-0" 3'-0"	5'-0"	METAL CLAD WOOD	A/A6.1	B/A6.1 & C/A6.1	D/A6.			
			METAL CLAD WOOD	A/A6.1	B/A6.1 & C/A6.1	D/A6.			
B3-2	3'-0"	5'-0"	METAL CLAD WOOD	A/A6.1	B/A6.1 & C/A6.1	D/A6.			
B3-3	3'-0"	5'-0"	METAL CLAD WOOD	A/A6.1	B/A6.1 & C/A6.1	D/A6.			
B4-1	3'-0"	5'-0"	METAL CLAD WOOD	A/A6.1	B/A6.1 & C/A6.1	D/A6.			
B4-2	3'-0"	5'-0"	METAL CLAD WOOD	A/A6.1	B/A6.1 & C/A6.1	D/A6.			
B4-3	3'-0"	5'-0"	METAL CLAD WOOD	A/A6.1	B/A6.1 & C/A6.1	D/A6.			
C3-1	3'-0"	5'-0"	METAL CLAD WOOD	A/A6.1	B/A6.1 & C/A6.1	D/A6.			
C3-2	3'-0"	5'-0"	METAL CLAD WOOD	A/A6.1	B/A6.1 & C/A6.1	D/A6.			
C3-3	3'-0"	5'-0"	METAL CLAD WOOD	A/A6.1	B/A6.1 & C/A6.1	D/A6.			
C4-1	3'-0"	5'-0"	METAL CLAD WOOD	A/A6.1	B/A6.1 & C/A6.1	D/A6.			
C4-2	3'-0"	5'-0"	METAL CLAD WOOD	A/A6.1	B/A6.1 & C/A6.1	D/A6.			
C4-3	3'-0"	5'-0"	METAL CLAD WOOD	A/A6.1	B/A6.1 & C/A6.1	D/A6.			
D3-1	3'-0"	5'-0"	METAL CLAD WOOD	A/A6.1	B/A6.1 & C/A6.1	D/A6.			
D3-2	3'-0"	5'-0"	METAL CLAD WOOD	A/A6.1	B/A6.1 & C/A6.1	D/A6.			
D3-3	3'-0"	5'-0"	METAL CLAD WOOD	A/A6.1	B/A6.1 & C/A6.1	D/A6.			
D4-1	3'-0"	5'-0"	METAL CLAD WOOD	A/A6.1	B/A6.1 & C/A6.1	D/A6.			
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D4-3	3'-0"	5'-0"	METAL CLAD WOOD	A/A6.1	B/A6.1 & C/A6.1	D/A6.			
E3-1	3'-0"	5'-0"	METAL CLAD WOOD	A/A6.1	B/A6.1 & C/A6.1	D/A6.			
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E4-1	3'-0"	5'-0"	METAL CLAD WOOD	A/A6.1	B/A6.1 & C/A6.1	D/A6.			
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E4-3	3'-0"	5'-0"	METAL CLAD WOOD	A/A6.1	B/A6.1 & C/A6.1	D/A6.			
F3-1	3'-0"	5'-0"	METAL CLAD WOOD	A/A6.1	B/A6.1 & C/A6.1	D/A6.			
F3-2	3'-0"	5'-0"	METAL CLAD WOOD	A/A6.1	B/A6.1 & C/A6.1	D/A6.			
F3-3	3'-0"	5'-0"	METAL CLAD WOOD	A/A6.1	B/A6.1 & C/A6.1	D/A6.			
F4-1	3'-0"	5'-0"	METAL CLAD WOOD	A/A6.1	B/A6.1 & C/A6.1	D/A6.			
F4-2	3'-0"	5'-0"	METAL CLAD WOOD	A/A6.1	B/A6.1 & C/A6.1	D/A6.			
F4-3	3'-0"	5'-0"	METAL CLAD WOOD	A/A6.1	B/A6.1 & C/A6.1	D/A6.			
	3'-0"	5'-0"							
G3-1 G3-2	3'-0"	5'-0"	METAL CLAD WOOD METAL CLAD WOOD	A/A6.1	B/A6.1 & C/A6.1	D/A6.			
				A/A6.1	B/A6.1 & C/A6.1	D/A6.			
G3-3	3'-0"	5'-0"	METAL CLAD WOOD	A/A6.1	B/A6.1 & C/A6.1	D/A6.			
G4-1	3'-0"	5'-0"	METAL CLAD WOOD	A/A6.1	B/A6.1 & C/A6.1	D/A6.			
G4-2	3'-0"	5'-0"	METAL CLAD WOOD	A/A6.1	B/A6.1 & C/A6.1	D/A6.			
G4-3	3'-0"	5'-0"	METAL CLAD WOOD	A/A6.1	B/A6.1 & C/A6.1	D/A6.			
H3-1	3'-0"	5'-0"	METAL CLAD WOOD	A/A6.1	B/A6.1 & C/A6.1	D/A6.			
H3-2	3'-0"	5'-0"	METAL CLAD WOOD	A/A6.1	B/A6.1 & C/A6.1	D/A6.			
H3-3	3'-0"	5'-0"	METAL CLAD WOOD	A/A6.1	B/A6.1 & C/A6.1	D/A6.			
H4-1	3'-0"	5'-0"	METAL CLAD WOOD	A/A6.1	B/A6.1 & C/A6.1	D/A6.			
H4-2	3'-0"	5'-0"	METAL CLAD WOOD	A/A6.1	B/A6.1 & C/A6.1	D/A6.			
H4-3	3'-0"	5'-0"	METAL CLAD WOOD	A/A6.1	B/A6.1 & C/A6.1	D/A6.			
I3-1	3'-0"	5'-0"	METAL CLAD WOOD	A/A6.1	B/A6.1 & C/A6.1	D/A6.			
13-2	3'-0"	5'-0"	METAL CLAD WOOD	A/A6.1	B/A6.1 & C/A6.1	D/A6.			
13-3	3'-0"	5'-0"	METAL CLAD WOOD	A/A6.1	B/A6.1 & C/A6.1	D/A6.			
14-1	3'-0"	5'-0"	METAL CLAD WOOD	A/A6.1	B/A6.1 & C/A6.1	D/A6.			
14-2	3'-0"	5'-0"	METAL CLAD WOOD	A/A6.1	B/A6.1 & C/A6.1	D/A6.			
14-3	3'-0"	5'-0"	METAL CLAD WOOD	A/A6.1	B/A6.1 & C/A6.1	D/A6.			
J3-1	3'-0"	5'-0"	METAL CLAD WOOD	A/A6.1	B/A6.1 & C/A6.1	D/A6.			
J3-2	3'-0"	5'-0"	METAL CLAD WOOD	A/A6.1	B/A6.1 & C/A6.1	D/A6.			
J3-3	3'-0"	5'-0"	METAL CLAD WOOD	A/A6.1	B/A6.1 & C/A6.1	D/A6.			
J4-1	3'-0"	5'-0"	METAL CLAD WOOD	A/A6.1	B/A6.1 & C/A6.1	D/A6.			
J4-2	3'-0"	5'-0"	METAL CLAD WOOD	A/A6.1	B/A6.1 & C/A6.1	D/A6.			
J4-3	3'-0"	5'-0"	METAL CLAD WOOD	A/A6.1	B/A6.1 & C/A6.1	D/A6.			



A6.1

WINDOW NUMBERING TYP ALL BLDGS

SCALE: 1/8" = 1'-0"

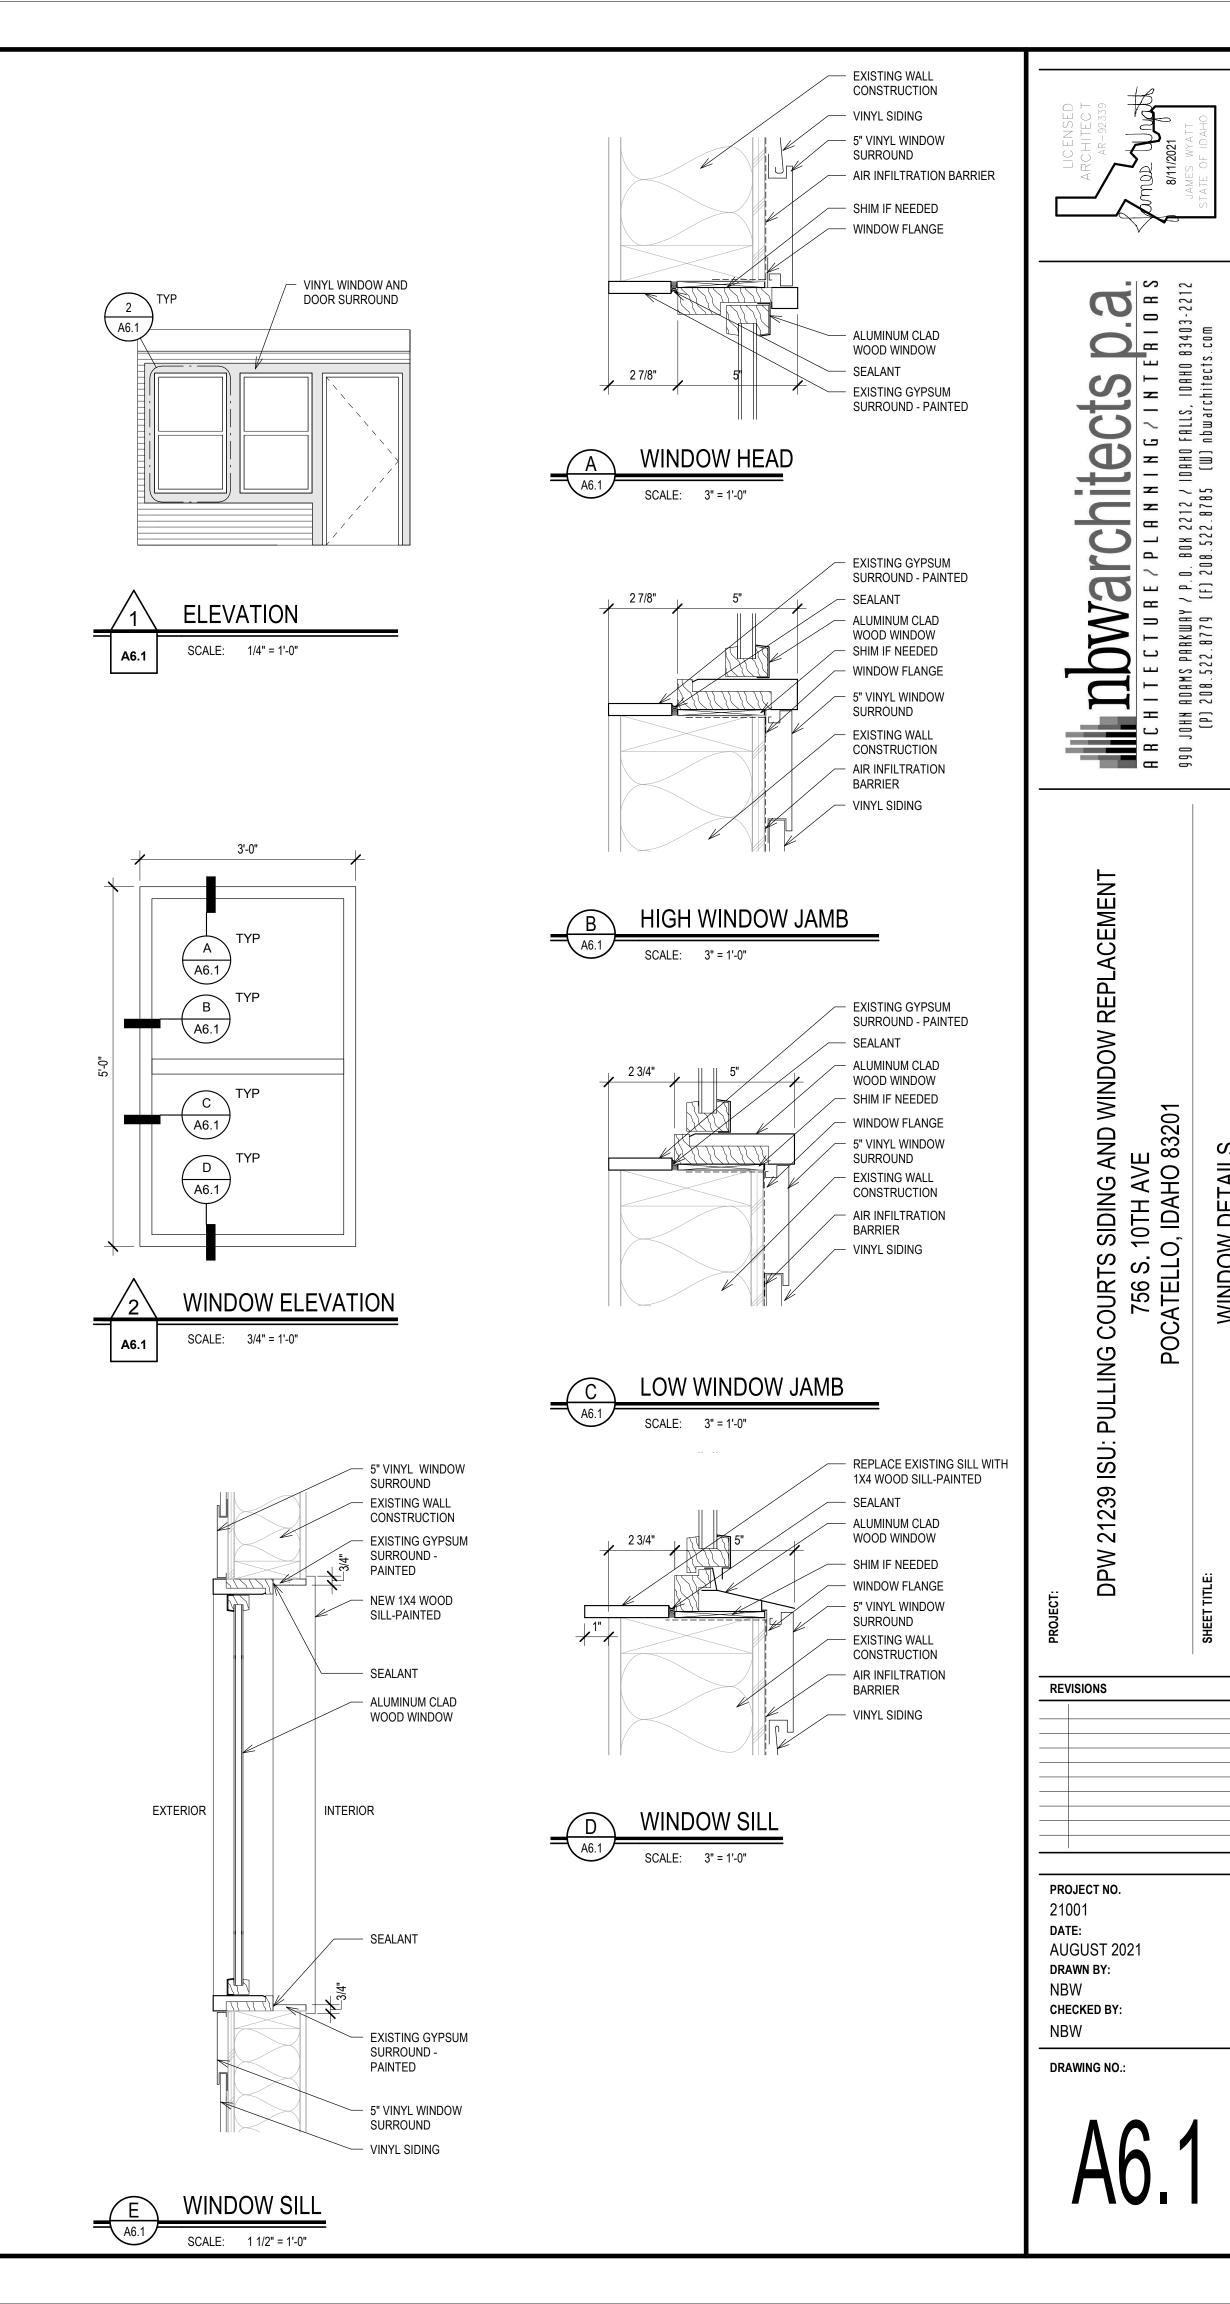

83201

DE

AVE NHO