

DPW PROJECT NO. 20-232

ISU CUSTODIAL OFFICE REMODEL

IDAHO STATE UNIVERSITY POCATELLO, IDAHO

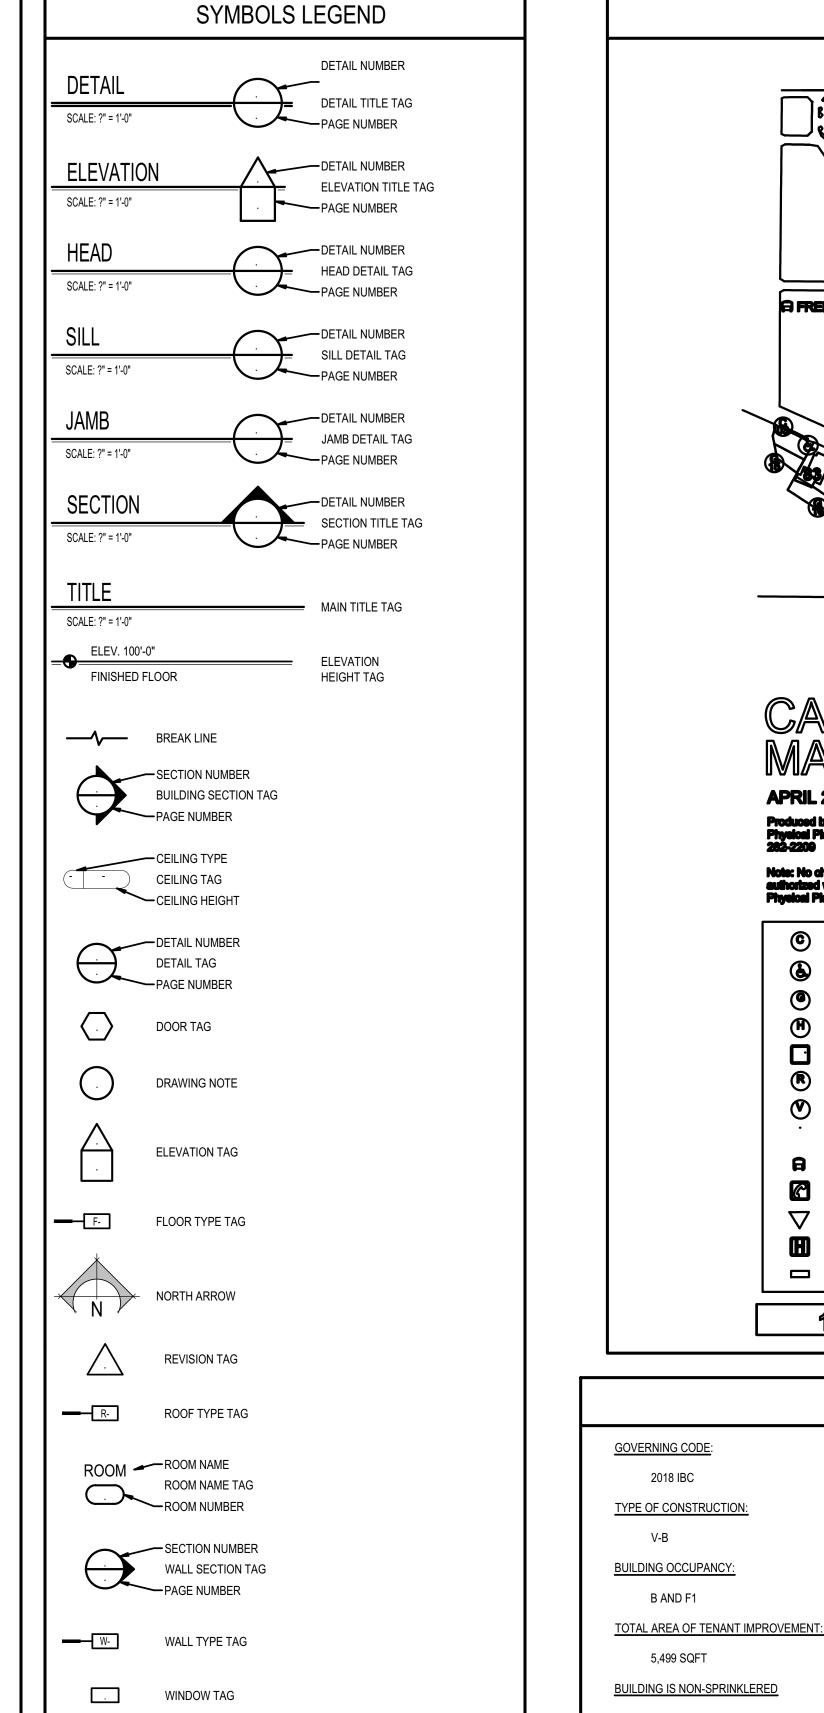

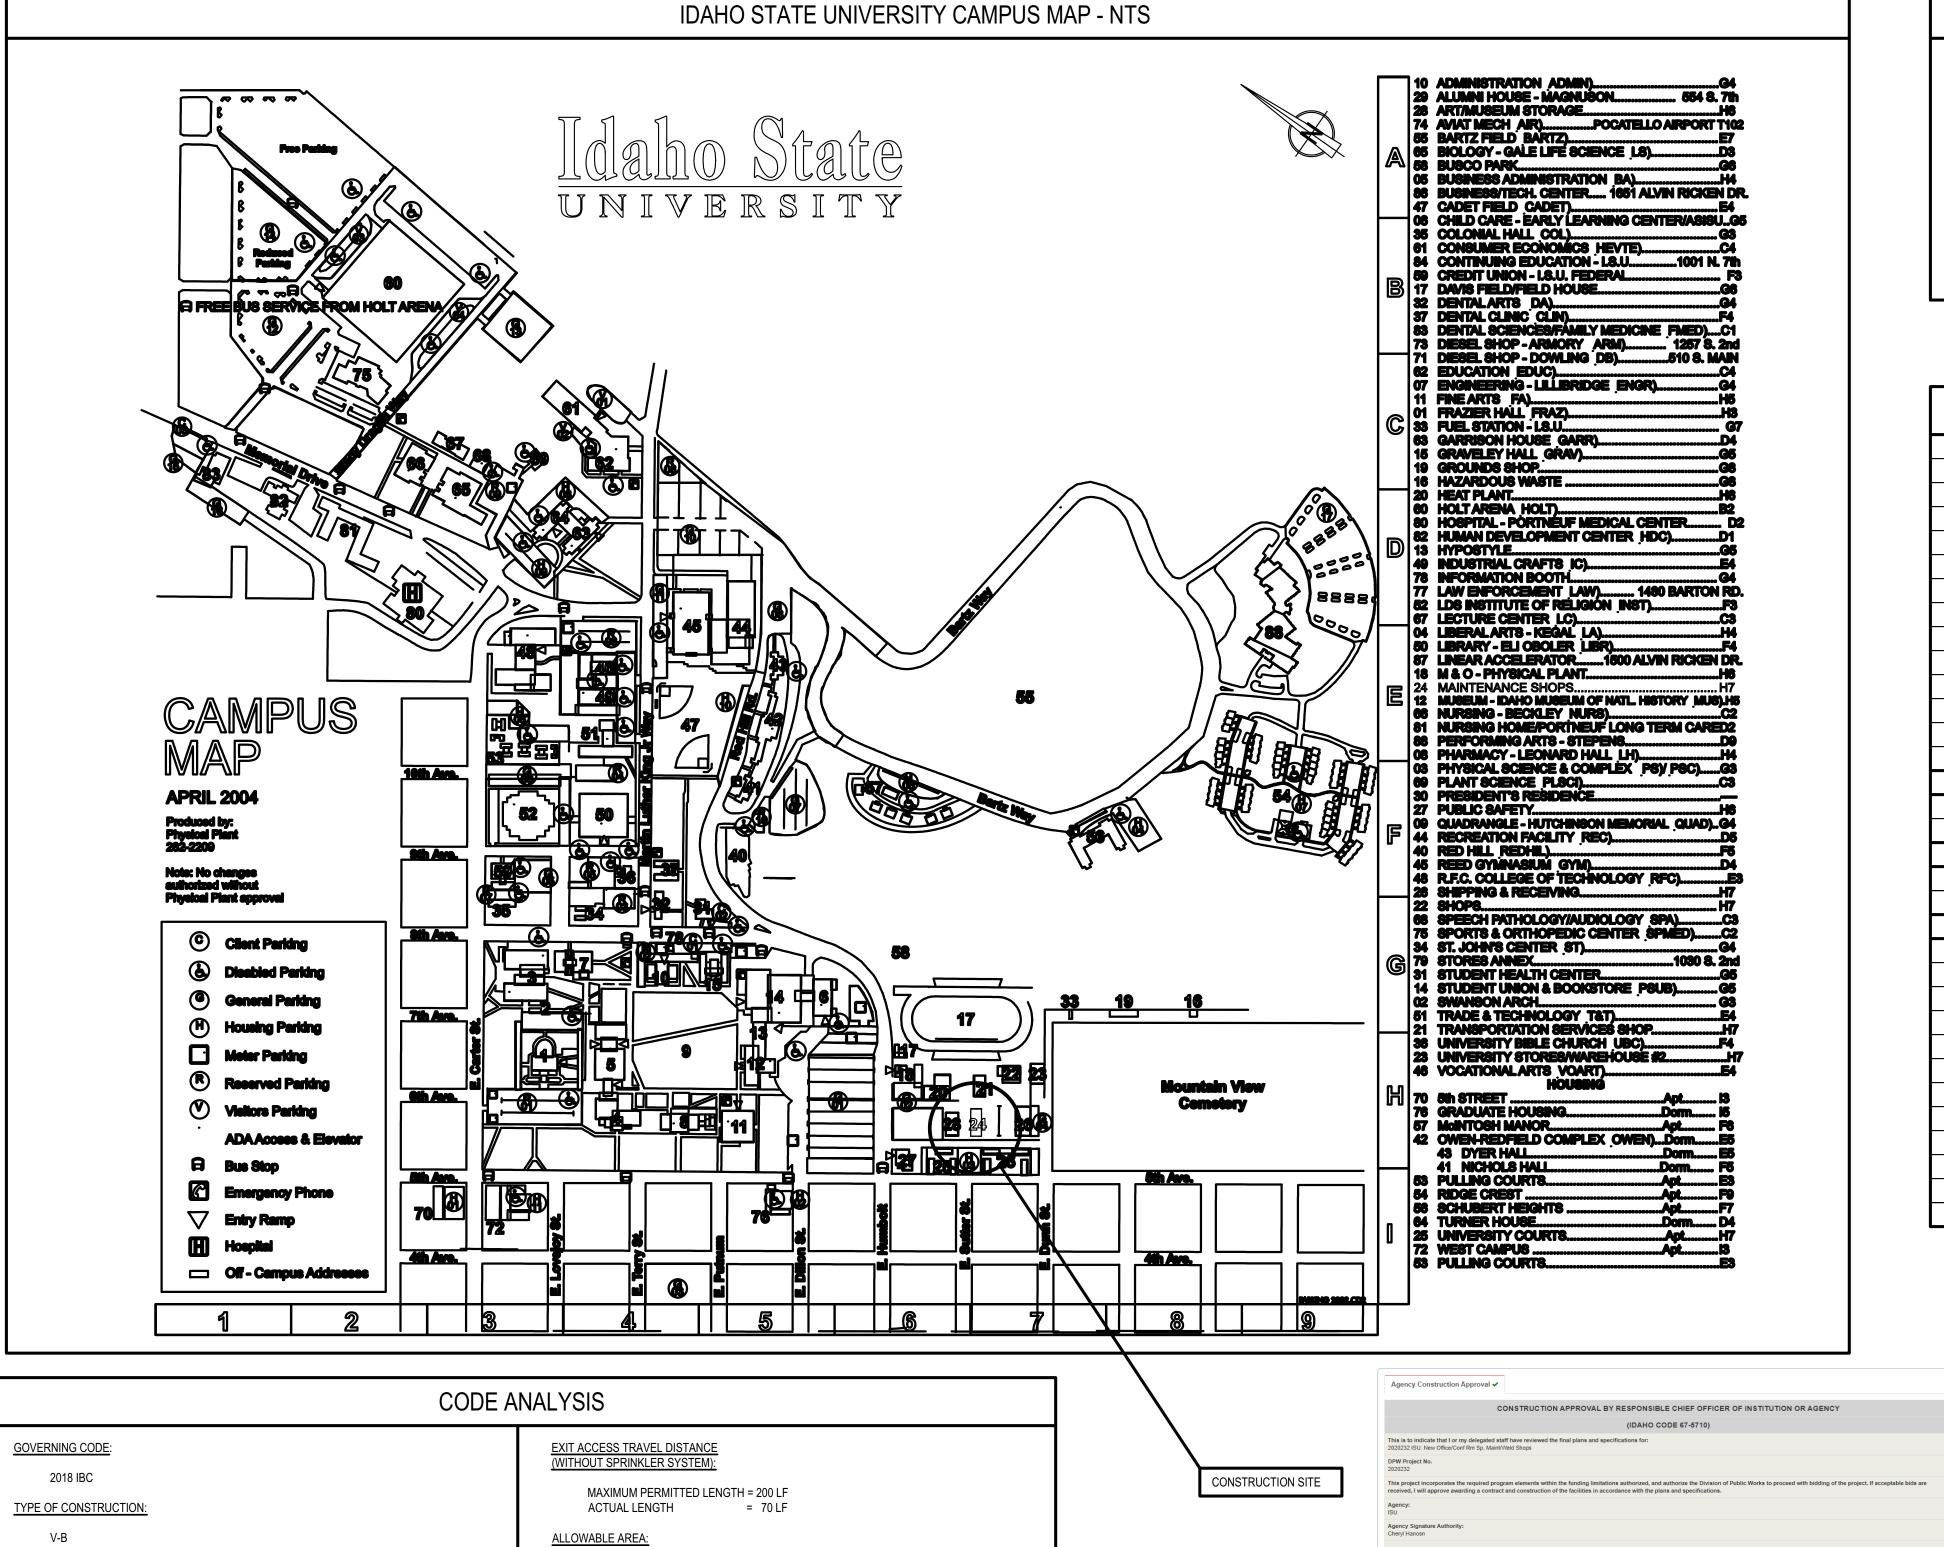

Approval (Approved)

2 A Project Manage

♣ DPW Administrator

1 Agency - Signature Authority

ALLOWABLE AREA: B OCCUPANCY V-B, NON SPRINKLERED = 9,000 SF>2,986 SF

ALLOWABLE AREA: F1 OCCUPANCY V-B, NON SPRINKLERED = 8,500 SF>2,513 SF

2,513

FACTOR

MECHANICAL ENGINEER: ENGINEERED SYSTEMS ASSOCIATES

1355 EAST CENTER
POCATELLO, IDAHO 83201
TELEPHONE: (208) 233-0501
FAX: (208) 233-0529

ELECTRICAL ENGINEER: MUS 645

MUSGROVE ENGINEERING, P.A. 645 W 25TH STREET IDAHO FALLS, IDAHO 83402 TELEPHONE: (208) 523-2862 FAX: (208) 523-2864

DRAWING INDEX ARCHITECTURAL TITLE SHEET AND INDEX MAIN FLOOR DEMOLITION PLAN MEZZANINE DEMOLITION PLAN NEW MAIN FLOOR PLAN WALL TYPES AND ROOM FINISH SCHEDULE NEW MEZZANINE PLAN EXTERIOR ELEVATIONS EXTERIOR ELEVATIONS WALL SECTIONS WALL SECTIONS DOOR AND WINDOW SCHEDULES AND DETAILS REFLECTED CEILING PLAN ROOF DRAINAGE PLAN **PLUMBING** MAIN LEVEL PLUMBING FLOOR PLAN PLUMBING DETAILS AND SCHEDULES **MECHANICAL** MECHANICAL PLAN AND SCHEDULES MECHANICAL DETAILS ELECTRICAL ELECTRICAL TITLE SHEET MAIN LEVEL LIGHTING DEMOLITION PLAN MEZZANINE LEVEL LIGHTING DEMOLITION PLAN MAIN LEVEL POWER DEMOLITION PLAN MEZZANINE LEVEL POWER DEMOLITION PLAN MAIN LEVEL LIGHTING INSTALLATION PLAN MAIN LEVEL POWER INSTALLATION PLAN MAIN LEVEL MECHANICAL POWER INSTALLATION PLAN MAIN LEVEL SPECIAL SYSTEMS INSTALLATION PLAN PANEL SCHEDULES AND SINGLE LINE DIAGRAM ELECTRICAL DETAILS

LIGHTING DETAILS

This is not a building permit

Plan Approval #:BLD2201-00069
Date:03/11/22

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LICENSED ARCHITECT AR-92339

AR-92339

O1-28-22

JAMES WYATT STATE OF IDAHO

A B C H I T E C T U R E / P L R N N I N G / I N T E 990 JOHN ROAMS PARKWAY / P.O. BON 2212 / IORHO FALLS, IORHO

ROJECT NO. 20-232 L OFFICE REMODE STATE UNIVERSITY ATELLO, IDAHO


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PROJECT NO.:
19032
DATE:
JANUARY 2022
DRAWN BY:
KP
CHECKED BY:
JHW

DRAWING NO.:

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- SEE MECHANICAL DRAWINGS FOR ALL MECHANICAL CEILING PENETRATIONS AND MECHANICAL WORK.
- SEE PLUMBING DRAWINGS FOR ALL PLUMBING WORK.
- RESOLVE ALL DISCREPANCIES WITH ARCHITECT PRIOR TO DEMOLITION.
- ALL WORK TO BE IN ACCORDANCE WITH ALL CODES AND ACCESSIBILITY REQUIREMENTS.
- CONTRACTOR TO VERIFY ALL DIMENSIONS IN FIELD.
- GENERAL CONTRACTOR IS REQUIRED TO PATCH AND REPAIR (WHETHER SO NOTED OR NOT) ALL EXISTING SURFACE AREAS AS REQUIRED BY DEMOLITION AND/OR TO COORDINATE SUCH REPAIR WORK WITH SUB-CONTRACTORS.
- PROTECT EXISTING EXTERIOR CONCRETE / ASPHALT FROM DAMAGE
- PROTECT ALL EXISTING-TO REMAIN ITEMS (WHETHER SO NOTED OR NOT) AND PROTECT ITEMS TO BE REMOVED AND REINSTALLED. REPAIR/REPLACE THESE ITEMS IF DAMAGED DURING
- CONSTRUCTION. ALL ITEMS NOTED TO BE REMOVED / REPLACED INCLUDING ALL DEMOLISHED CONSTRUCTION DEBRIS SHALL BE REMOVED FROM THE PROJECT SITE AND BE DISPOSED OF AS PER CURRENT CODES, LAWS AND REQUIREMENTS OF THE ENVIRONMENTAL PROTECTION

AGENCY (EPA).

- REMOVE EXISTING WOOD DOOR & FRAME.
- 4. REMOVE EXISTING WOOD STAIRS COMPLETE
- REMOVE EXISTING SINK
- 6. REMOVE CARPET AND BASE INCLUDING ALL ADHESIVES.
- REMOVE EXISTING COMPRESSED AIR
- REMOVE EXISTING H.M. DOOR AND FRAME.
- 10. REMOVE EXISTING UNIT HEATER COMPLETE.
- 12. EXISTING DATA PANEL TO REMAIN

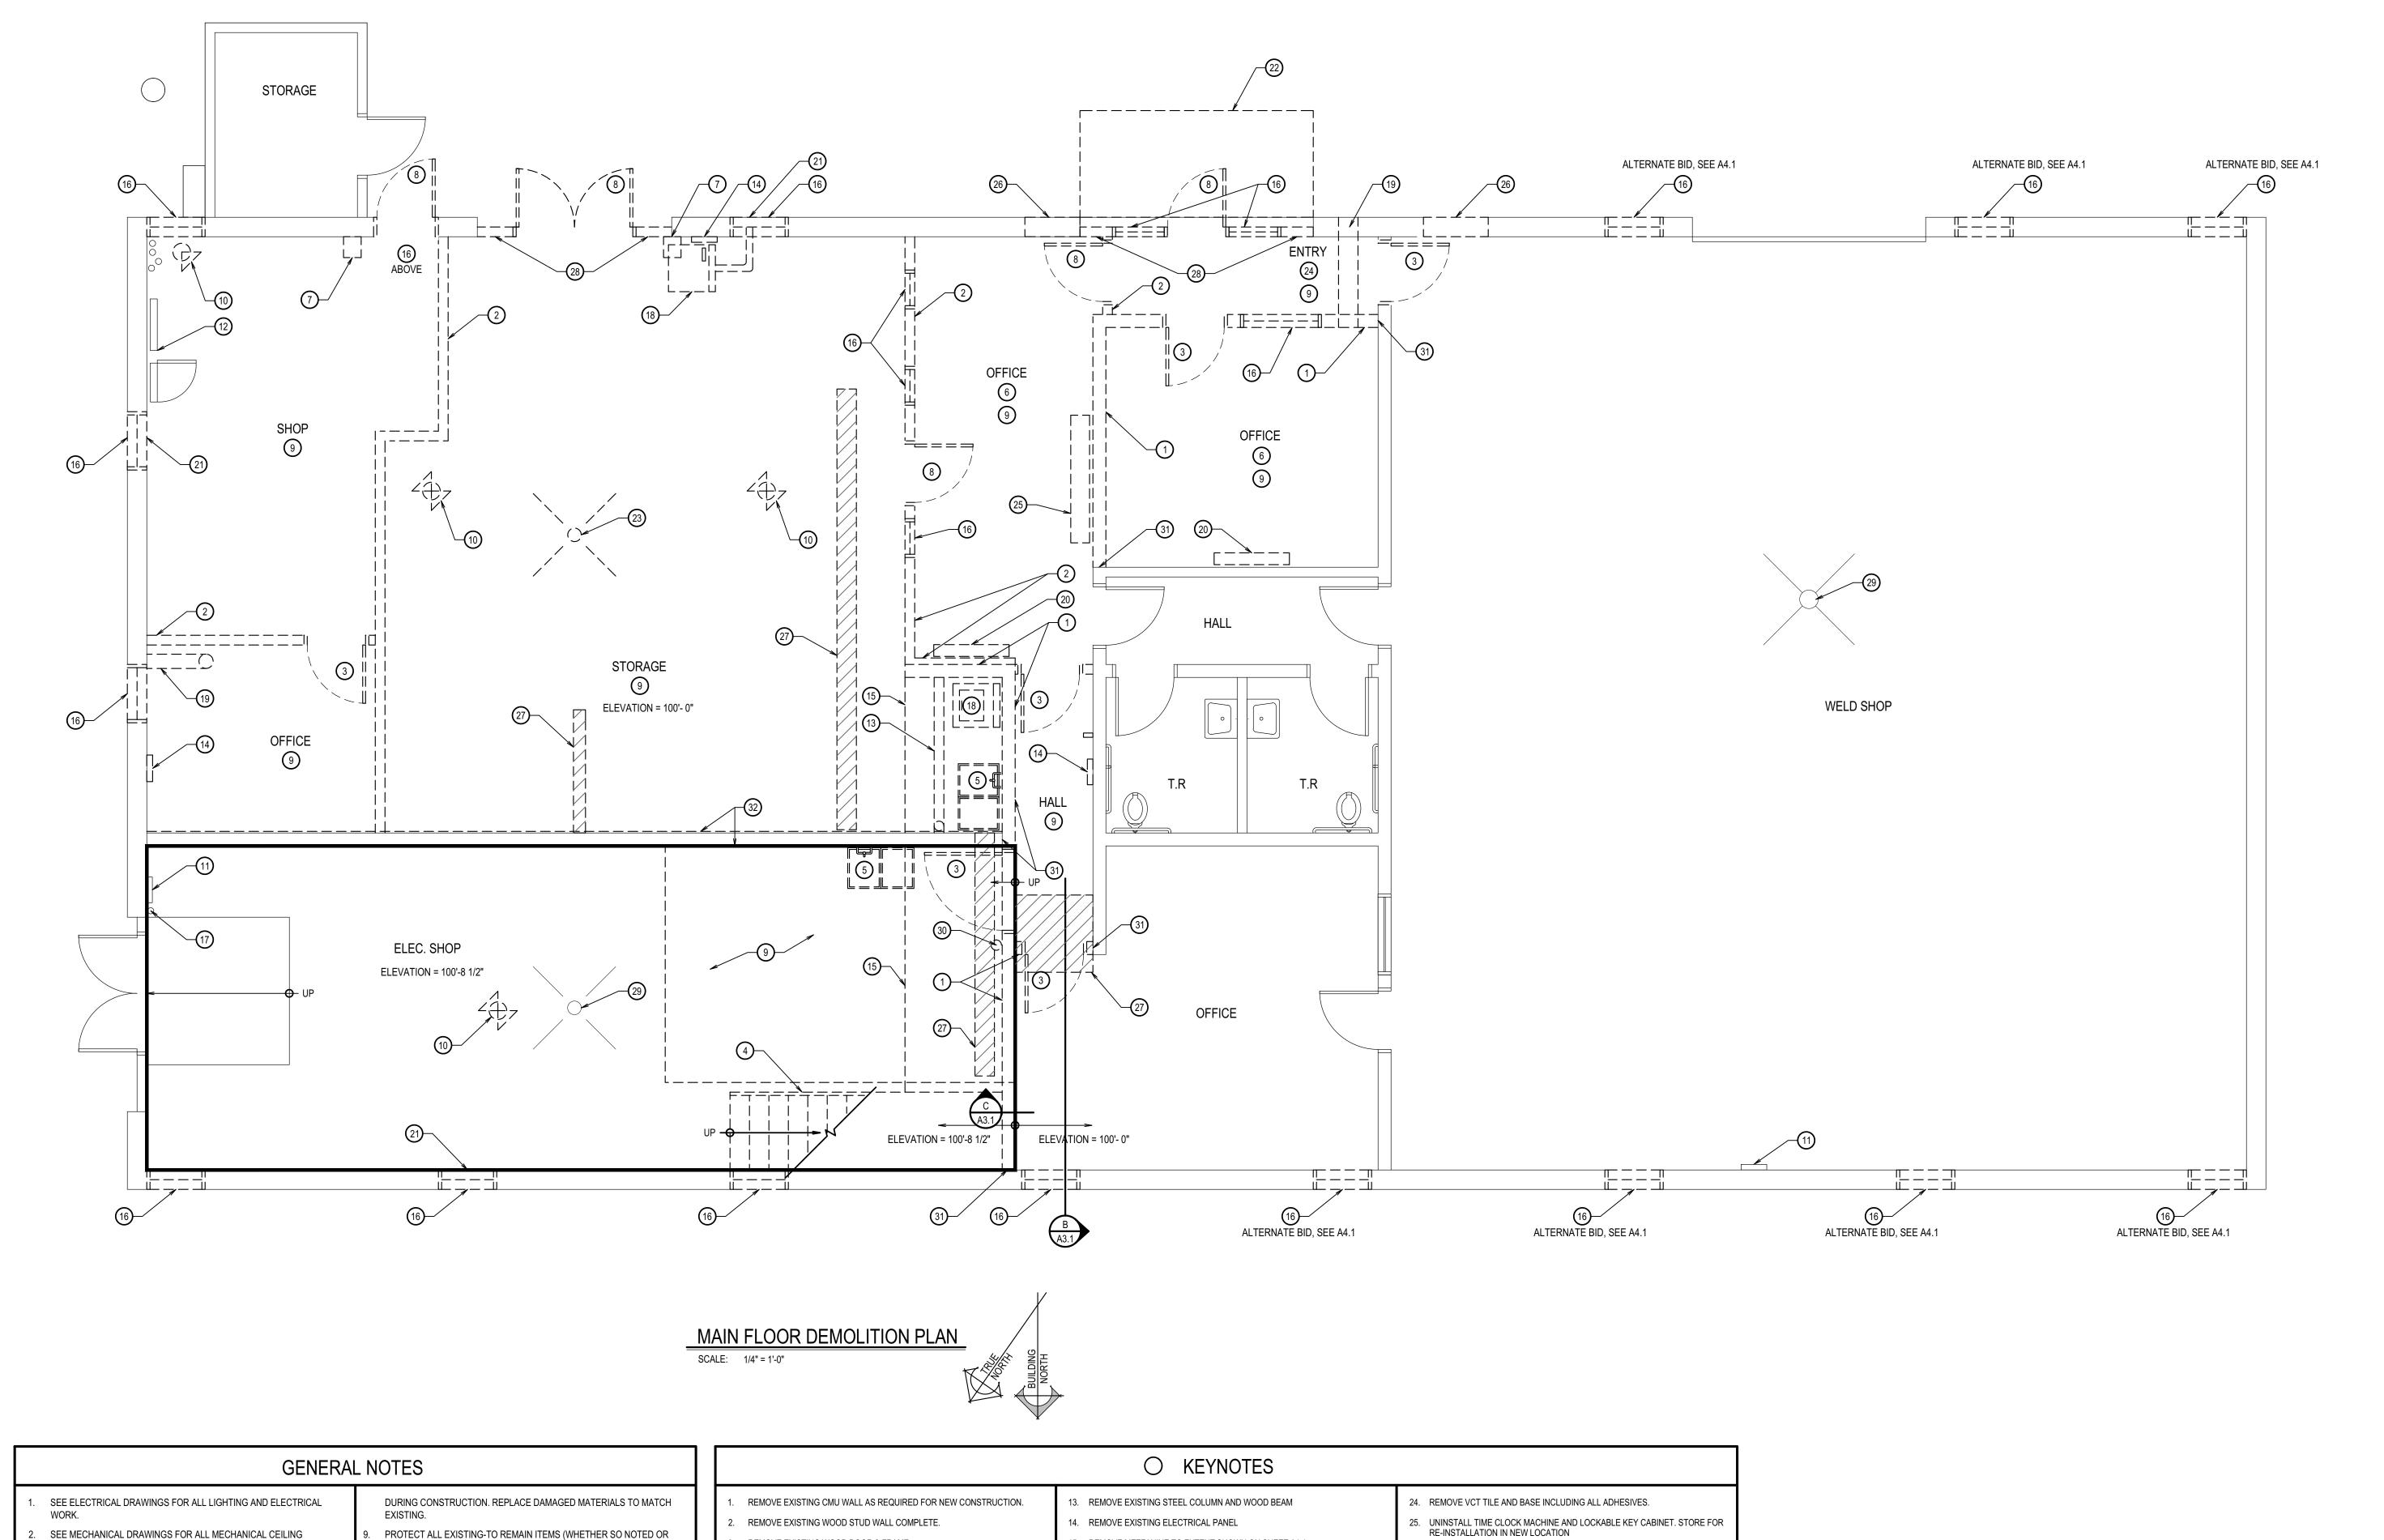- 15. REMOVE MEZZANINE TO EXTENT SHOWN ON SHEET A1.1.
- 16. REMOVE WINDOW
- 17. EXISTING FIRE EXTINGUISHER TO REMAIN
- 18. UNINSTALL DRYER / WASHER AND STORE FOR RE-INSTALLATION IN NEW

21. UNINSTALL AIR CONDITIONING UNIT AND RETURN TO OWNER

RETURN TO OWNER

22. REMOVE CANOPY ABOVE

- 19. REMOVE MECHANICAL DUCT 20. UNINSTALL WALL MOUNTED ELECTRICAL HEATING AND COOLING UNIT AND
- 9. GRIND AND PREP CONCRETE FLOOR TO RECEIVE NEW FINISHES.
- 11. EXISTING ELECTRICAL PANEL TO REMAIN
 - 23. REMOVE EXISTING FLOOR DRAIN

- 26. SAW CUT NEW OPENING IN CMU WALL TO ACCOMMODATE NEW HEADER AND
- DOOR. CUT BACK ANY RE-BAR AS REQUIRED. GRIND SMOOTH.
- 27. SAW CUT AND PATCH EXISTING CONCRETE SLAB.
- 28. REMOVE EXISTING DOOR SURROUND
- 29. EXISTING FLOOR DRAIN TO REMAIN
 - 30. RE-LOCATE EXISTING FIRE EXTINGUISHER
 - . GRIND SMOOTH EXISTING CMU WALL/ CONCRETE FLOOR WHERE ABUTTING CMU WALL HAS BEEN REMOVED, TYPICAL.
 - 32. REMOVE EXISTING PLYWOOD SHEATHING ATTACHED TO CMU WALL IF REQUIRED BY NEW CONSTRUCTION

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19032 JANUARY 2022 DRAWN BY: CHECKED BY:


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Plan Approval #:BLD2201-00069 Date: 03/11/22





GENERAL	NOTES
GENERAL	MOLES

- SEE ELECTRICAL DRAWINGS FOR ALL LIGHTING AND ELECTRICAL
- 2. MECHANICAL DRAWINGS FOR ALL MECHANICAL CEILING PENETRATIONS AND MECHANICAL WORK.
- 3. SEE PLUMBING DRAWINGS FOR ALL PLUMBING WORK.
- 4. RESOLVE ALL DISCREPANCIES WITH CONTRACTOR AND/OR
- ARCHITECT <u>PRIOR</u> TO DEMOLITION.

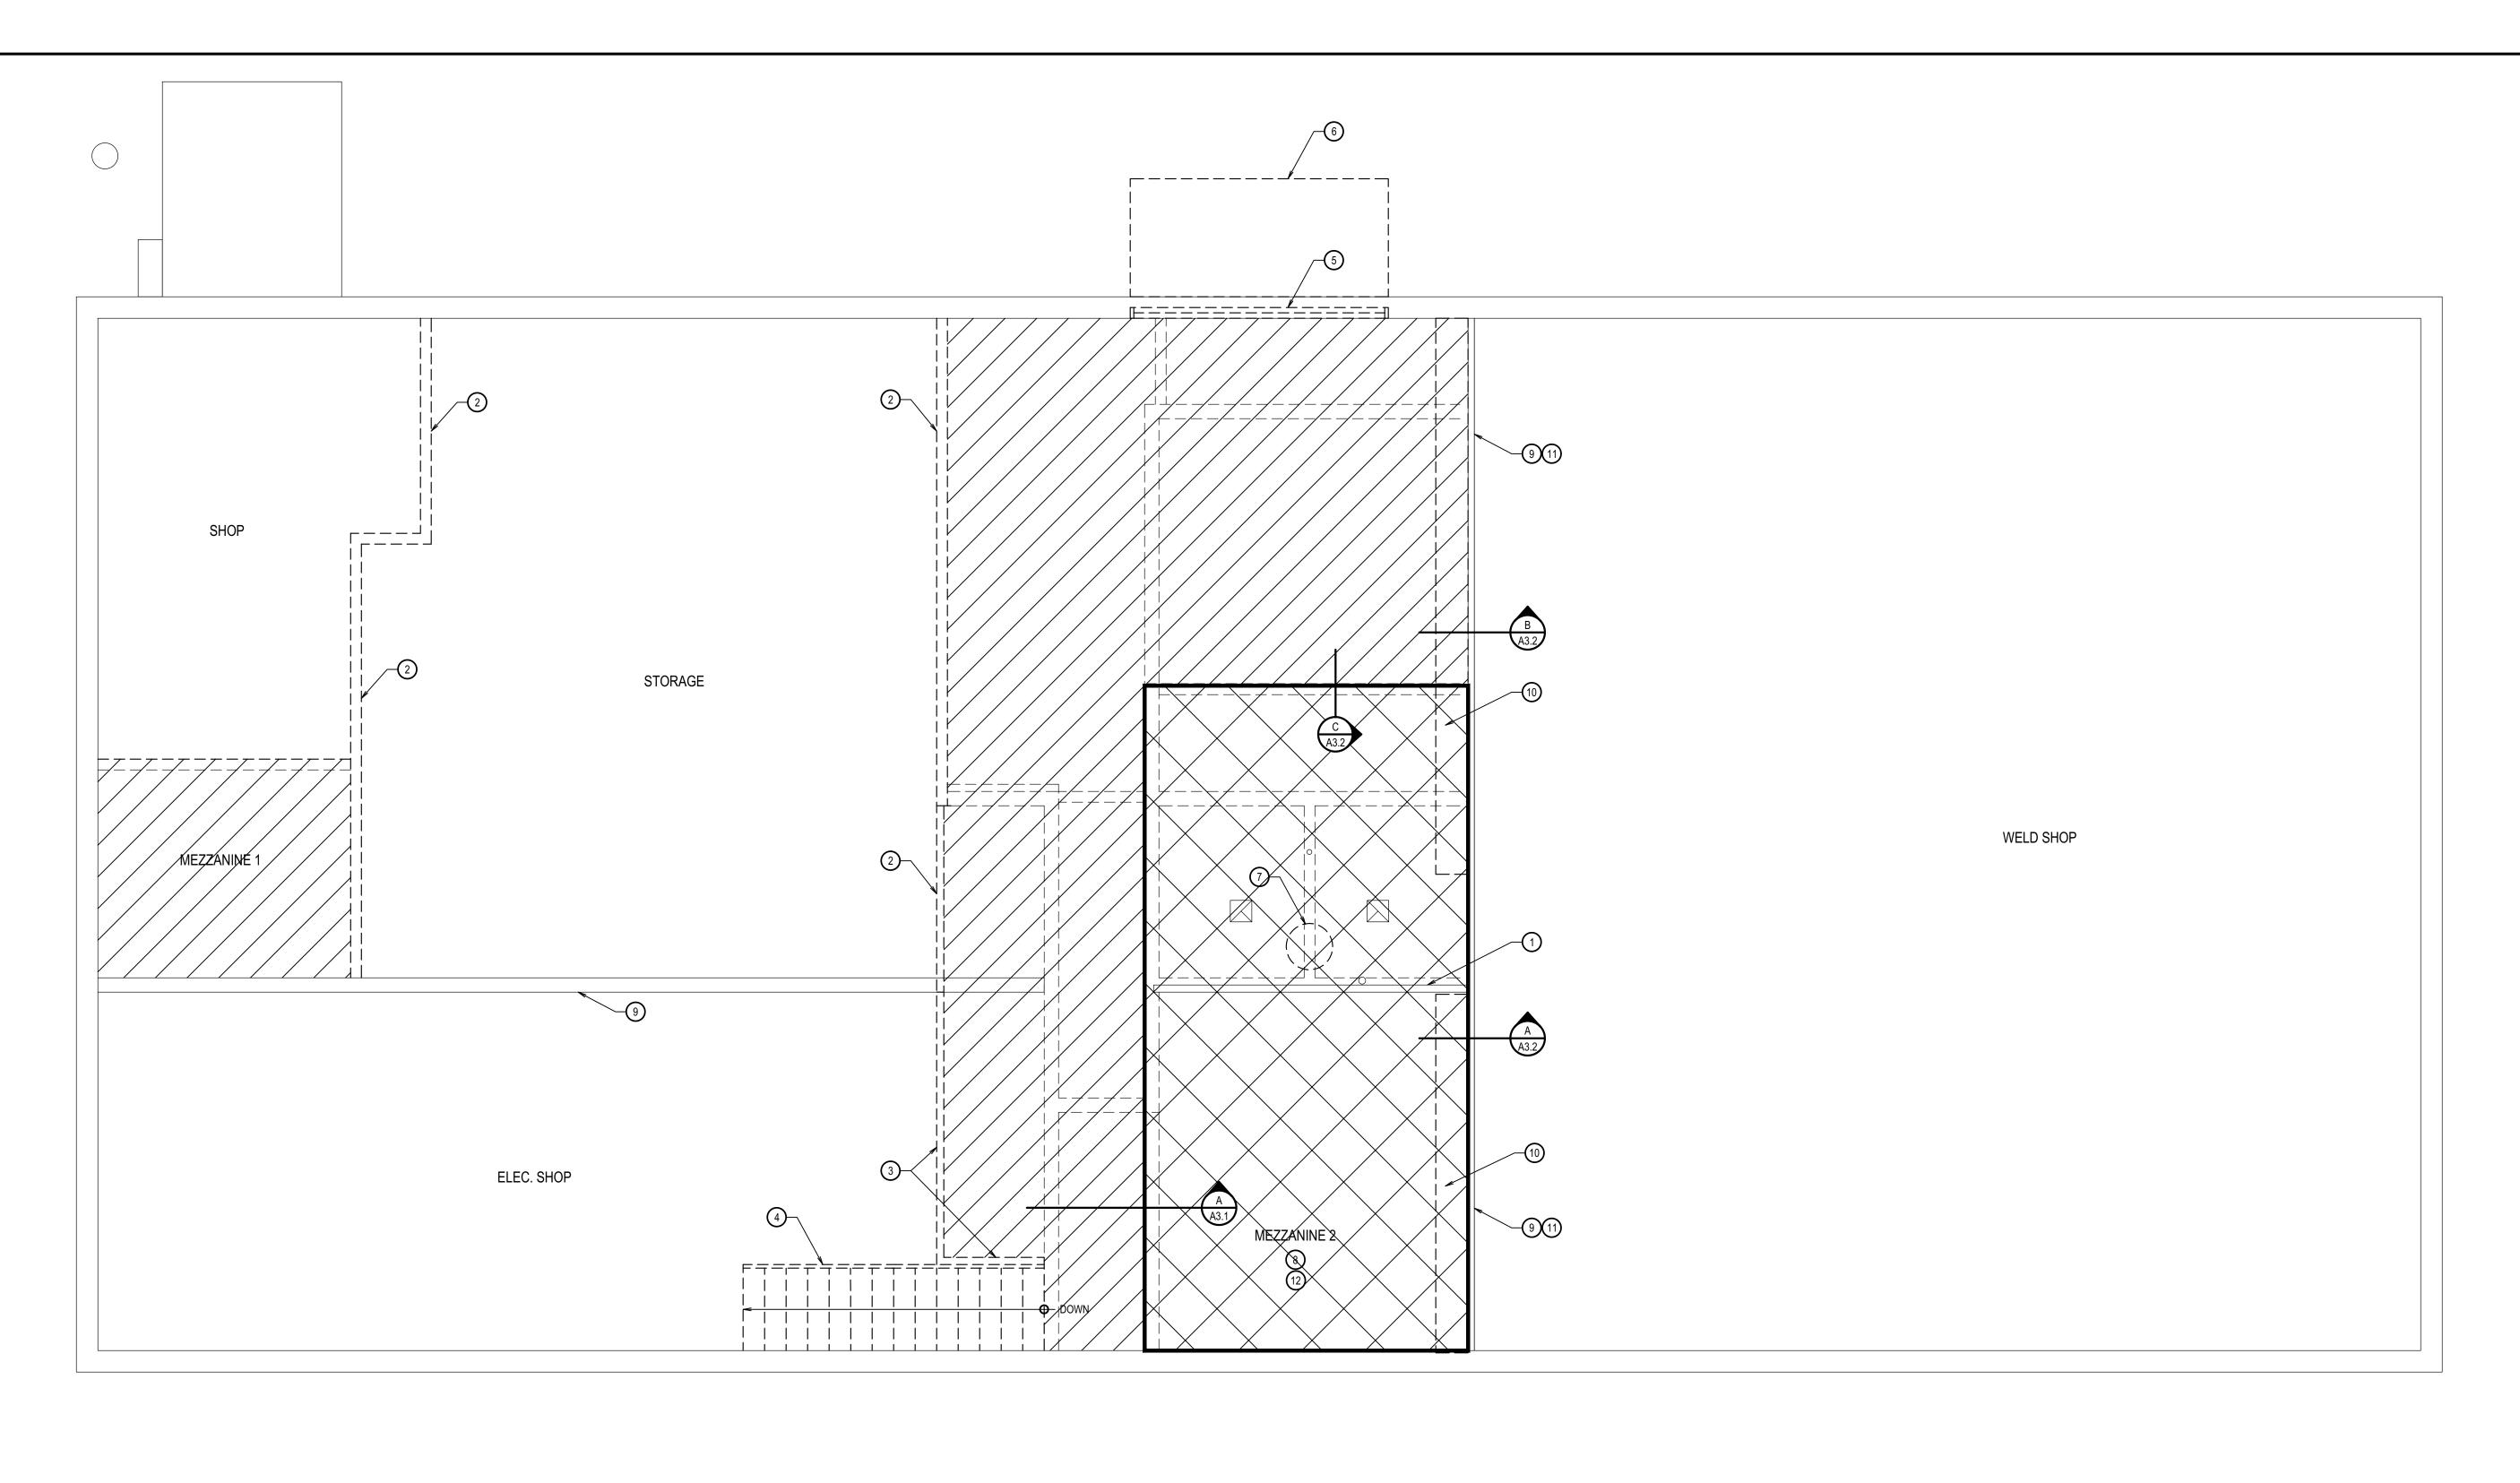 ALL WORK TO BE IN ACCORDANCE WITH ALL CODES AND
- ACCESSIBILITY REQUIREMENTS.
- 5. CONTRACTOR TO VERIFY ALL DIMENSIONS IN FIELD.
- 6. GENERAL CONTRACTOR IS REQUIRED TO PATCH AND REPAIR (WHETHER SO NOTED OR NOT) ALL EXISTING SURFACE AREAS AS REQUIRED BY DEMOLITION AND/OR TO COORDINATE SUCH REPAIR
- WORK WITH SUB-CONTRACTORS.

PROTECT EXISTING EXTERIOR CONCRETE / ASPHALT FROM DAMAGE

- DURING CONSTRUCTION. REPLACE DAMAGED MATERIALS TO MATCH EXISTING.
- PROTECT ALL EXISTING-TO REMAIN ITEMS (WHETHER SO NOTED OR NOT) AND PROTECT ITEMS TO BE REMOVED AND REINSTALLED. REPAIR/REPLACE THESE ITEMS IF DAMAGED DURING CONSTRUCTION.
- 10. ALL ITEMS NOTED TO BE REMOVED / REPLACED INCLUDING ALL DEMOLISHED CONSTRUCTION DEBRIS SHALL BE REMOVED FROM THE PROJECT SITE AND BE DISPOSED OF AS PER CURRENT CODES, LAWS AND REQUIREMENTS OF THE ENVIRONMENTAL PROTECTION AGENCY (EPA).
- 11. SAW CUT AND PATCH EXISTING CONCRETE FLOOR AS REQUIRED TO INSTALL NEW UNDERSLAB UTILITIES.

			KEYNOTES
1.	EXISTING WOOD STUD WALL TO REMAIN	11.	EXISTING WOOD STUD / PEGBOARD WALL ON CMU WALL TO REMAIN
2.	REMOVE EXISTING WOOD STUD WALL COMPLETE	12.	SHORE UP MEZZANINE TO REMAIN AS REQUIRED TO REMOVE WALLS BELOW
3.	REMOVE EXISTING WOOD STUD PONY WALL		

4. REMOVE EXISTING WOOD STAIRS COMPLETE
5. REMOVE EXISTING WINDOW

- 6. REMOVE EXISTING CANOPY7. UNINSTALL EXISTING WATER HEATER AND REINSTALL IN NEW UTILITY ROOM,
- SEE PLUMBING DRAWINGS

 8. PORTION OF EXISTING MEZZANINE TO REMAIN
 - 9. EXISTING WALL CMU WALL TO REMAIN10. REMOVE SHELVING UNITS

	MEZZANINE TO BE REMOVED
	MEZZANINE TO REMAIN. THE MAIN FLOOR CEILINGS ARE ATTACHED TO MEZZANINE STRUCTURE AND ARE TO REMAIN INTACT.

ARCHITECT
AR-92339
AR-92339
01-28-22
JAMES WYATT
STATE OF IDAHO

RINING / INTERIORS
2212 / IDRHO FALLS, IDRHO 83403-2212
2.8785 (W) nbwarchitects.com

R R C H I T E C T U R E / P L R N N I N G / I

990 JOHN RORMS PARKWAY / P. O. BON 2212 / IDRHO FALLS.

OJECT NO. 20-232

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ATELLO, IDAHO

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REVISIONS

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PROJECT NO.:
19032

DATE:
JANUARY 2022

DRAWN BY:
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CHECKED BY:
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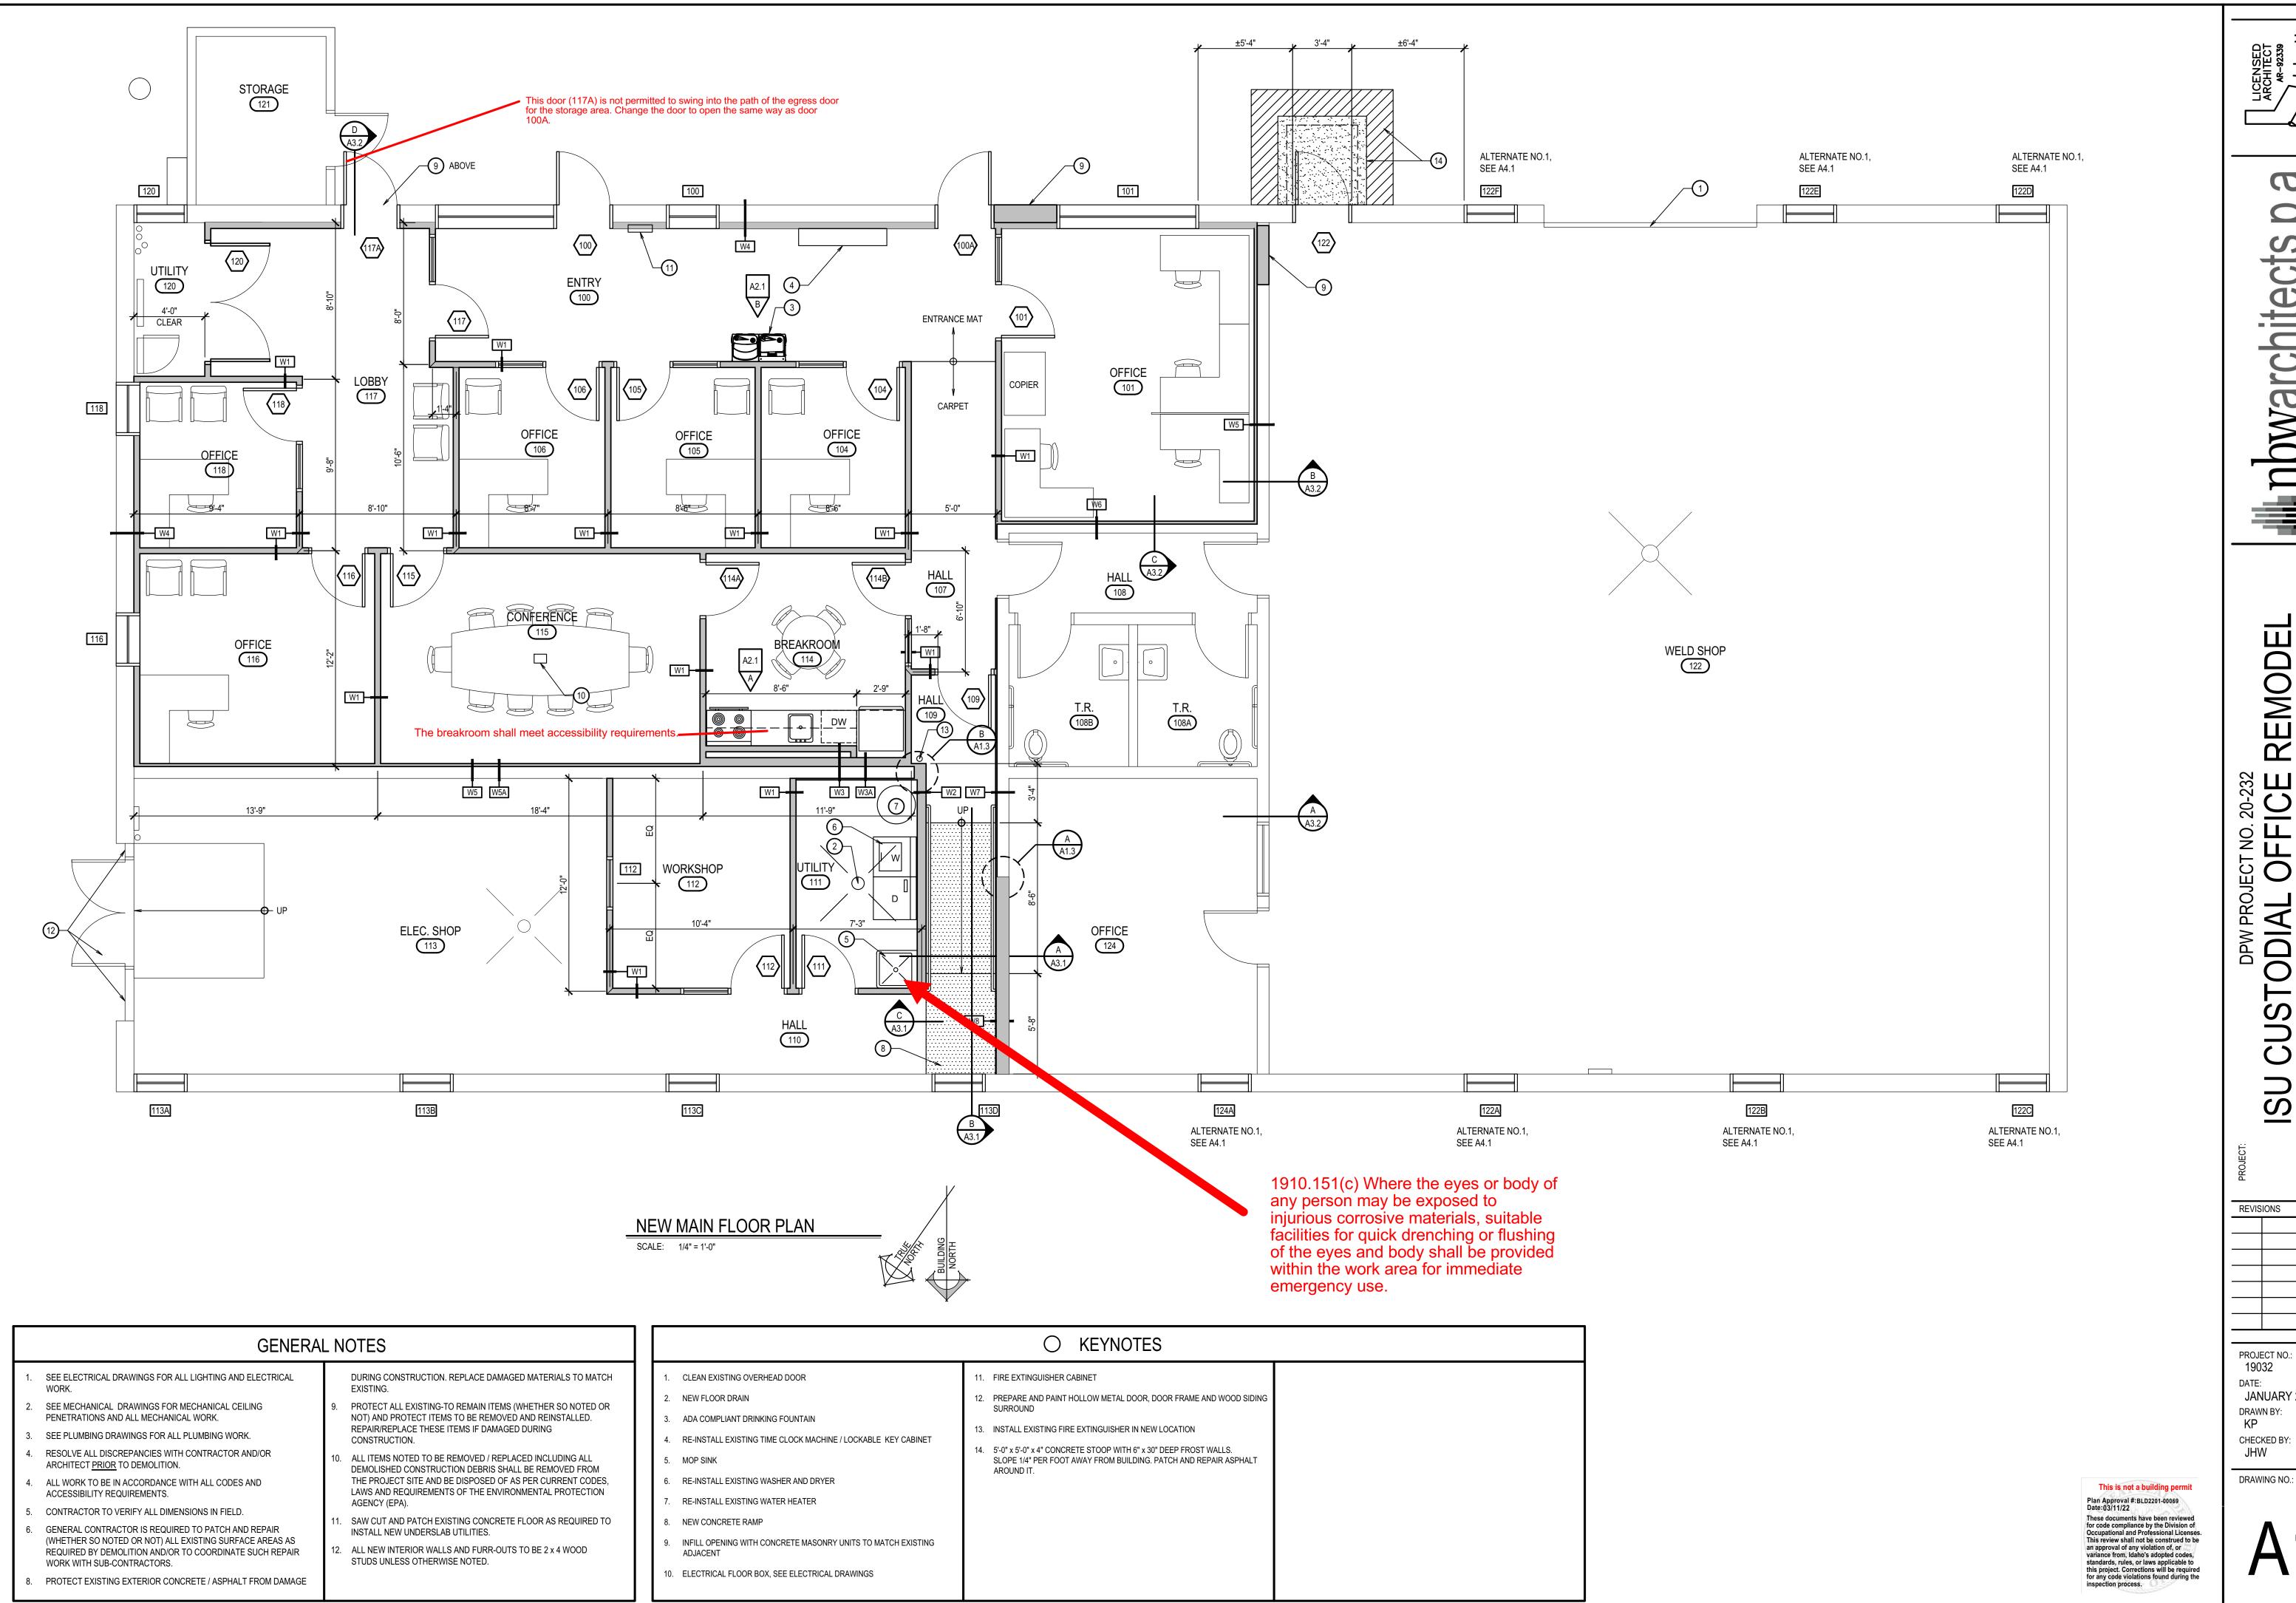
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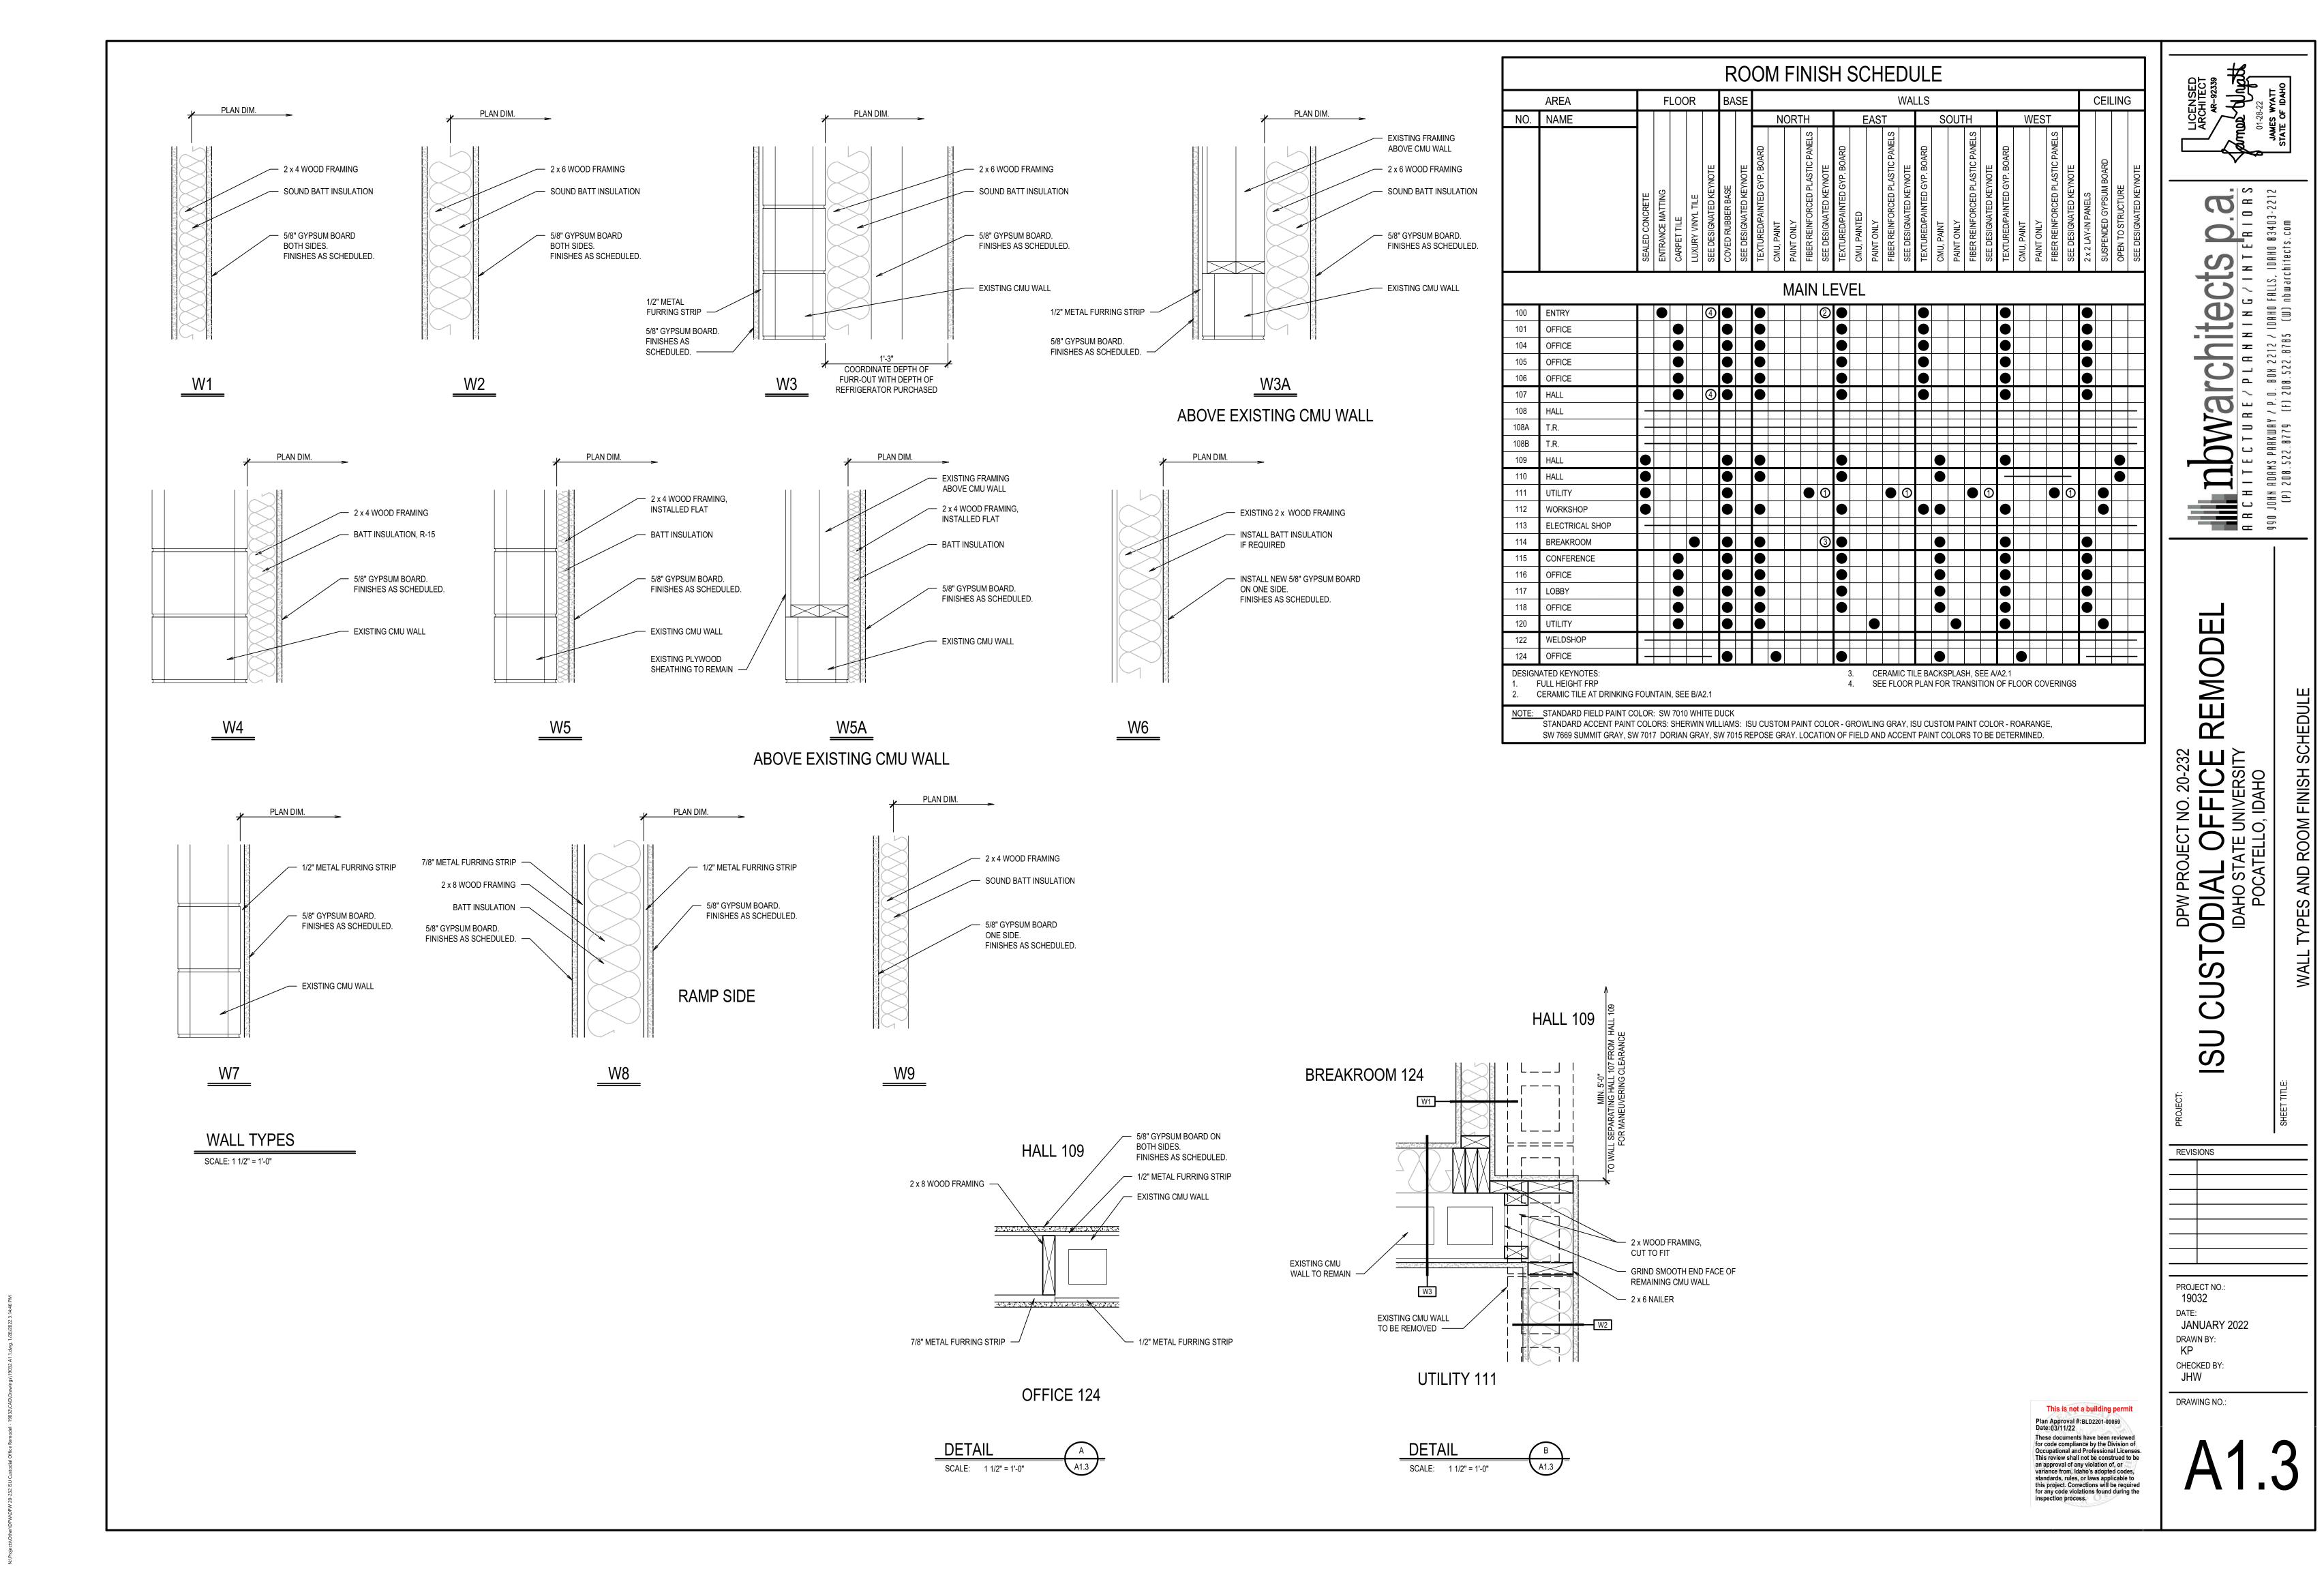



RRCHITECTURE/PLANNING/INTERIORS
990 JOHN RORMS PARKWAY / P.O. BOX 2212 / IDRHO FALLS, IDAHO 83403-2212
(P) 208.522.8779 (F) 208.522.8785 (W) nbwarchitects.com

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ATE UNIVERSITY
TELLO, IDAHO

REVISIONS

19032 JANUARY 2022 DRAWN BY: CHECKED BY:



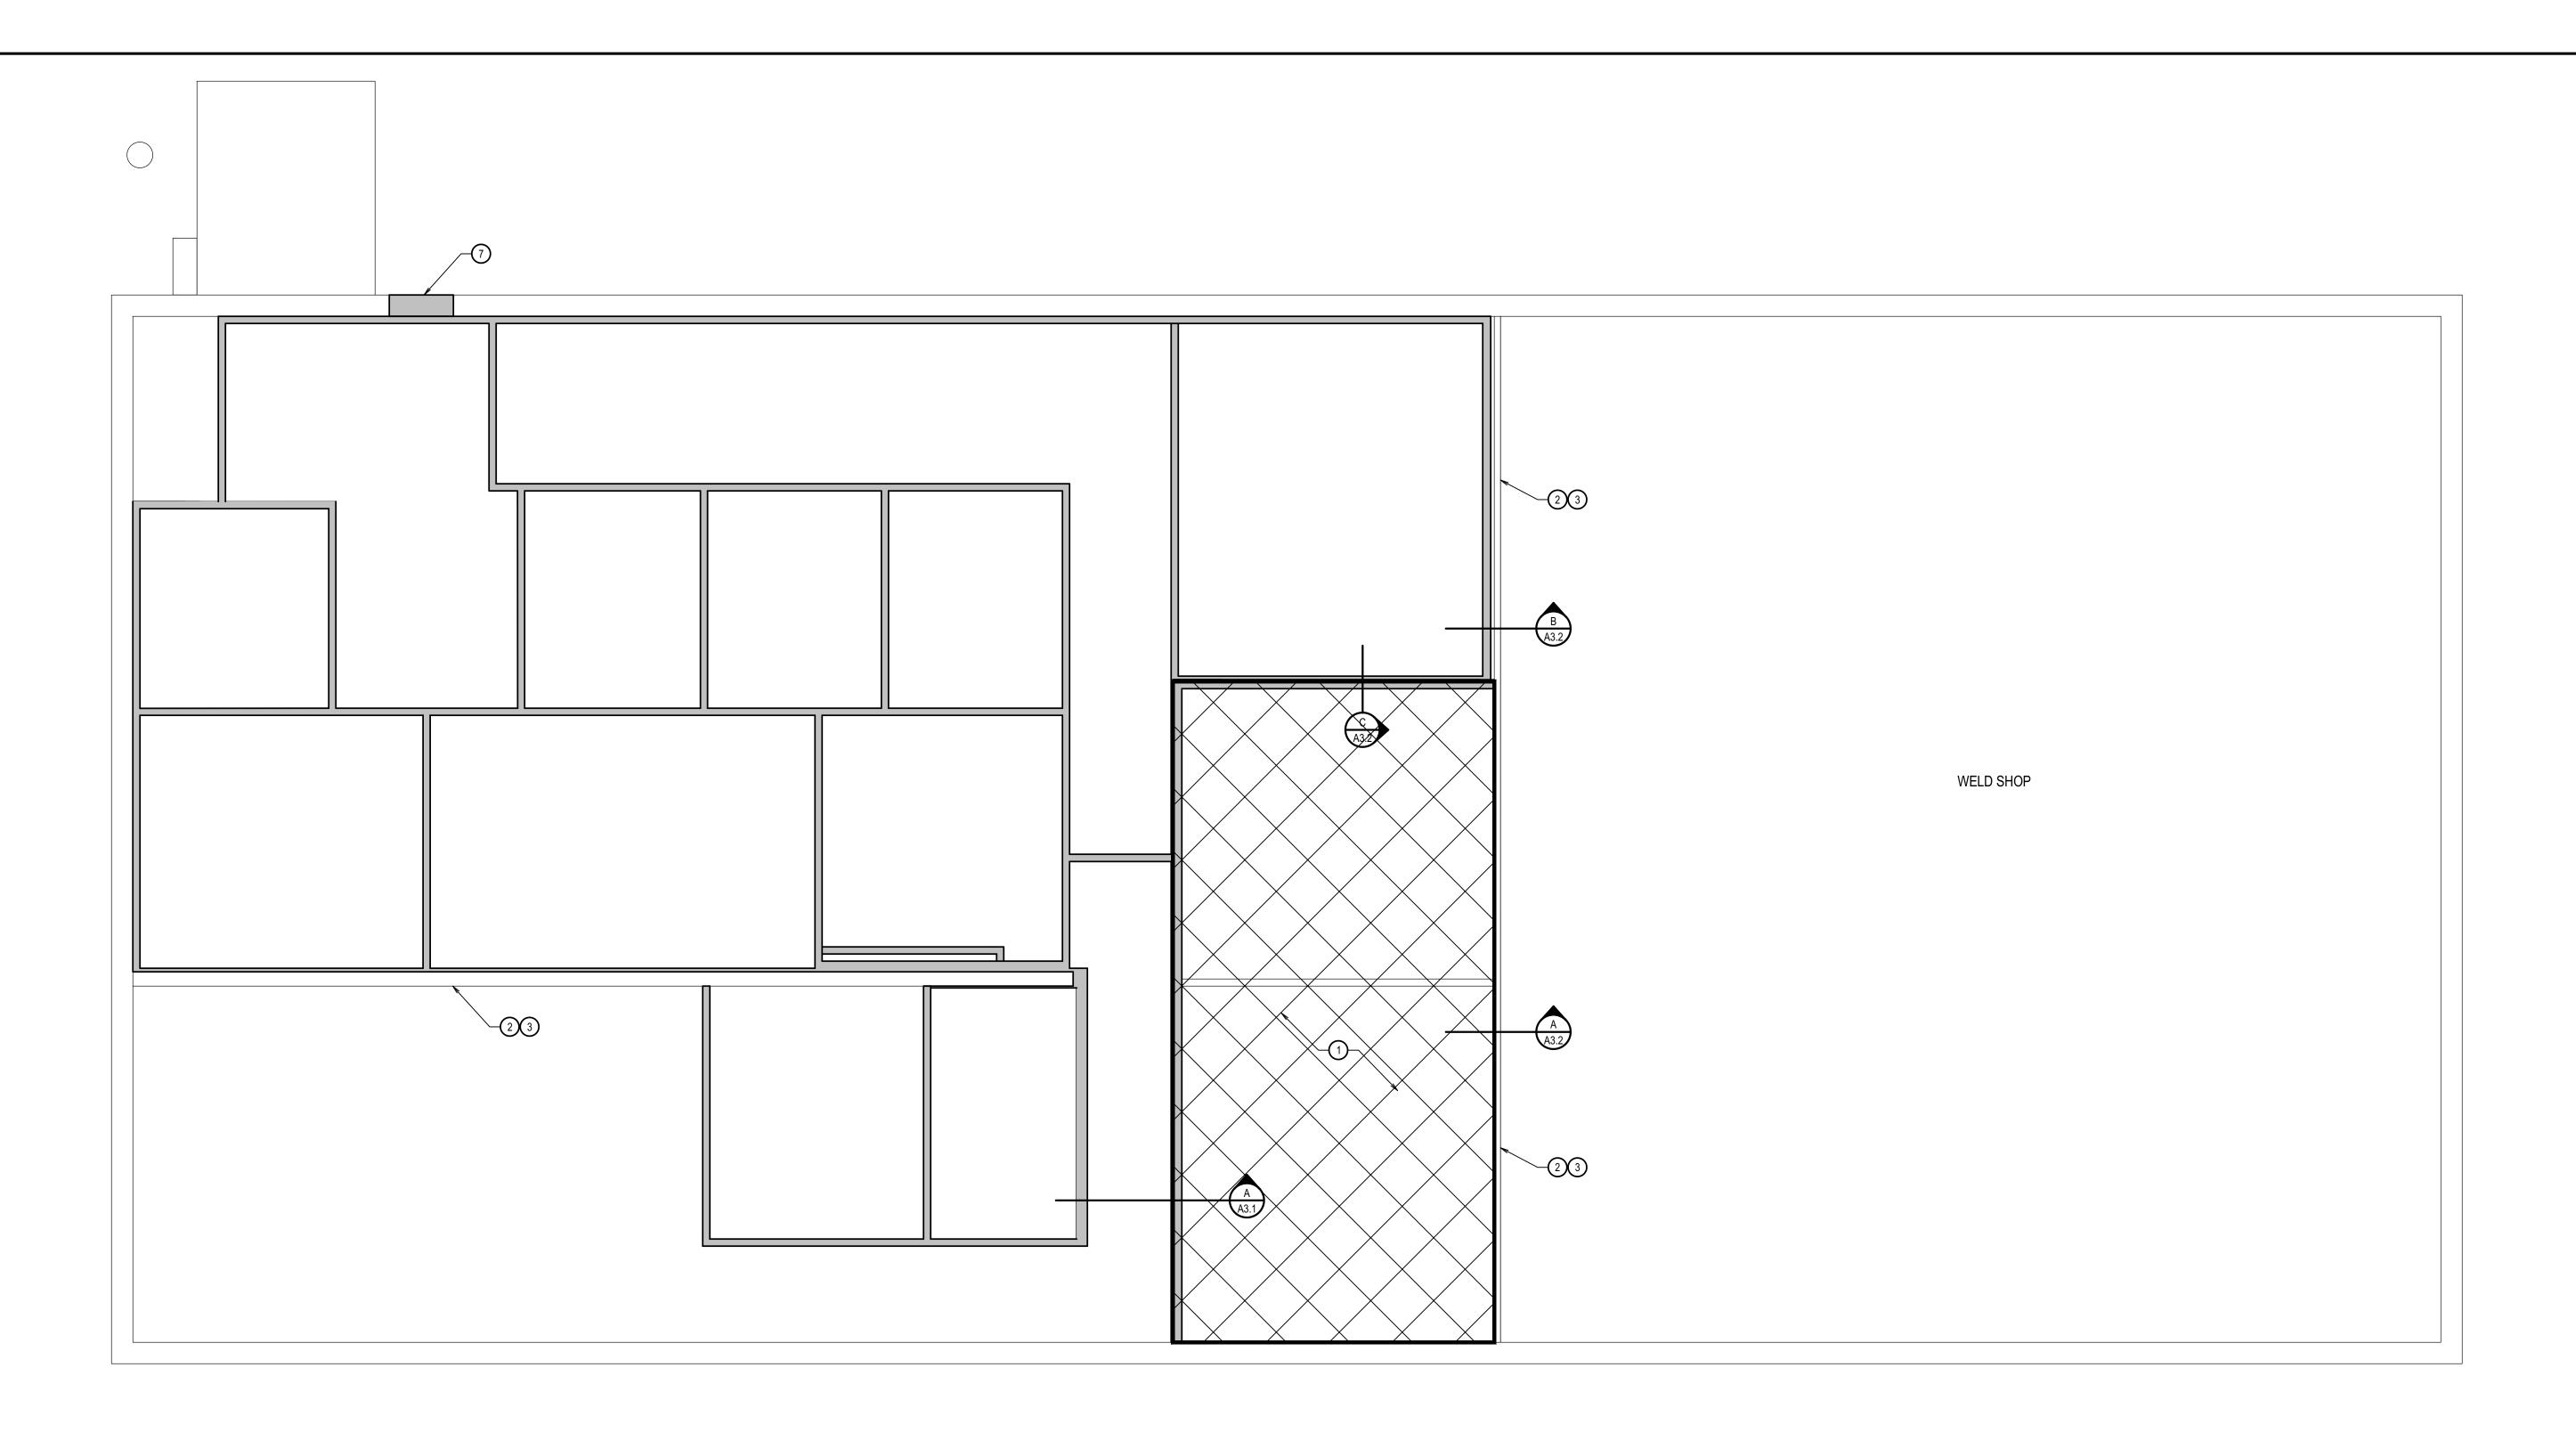



GENERAL NOTES

- SEE ELECTRICAL DRAWINGS FOR ALL LIGHTING AND ELECTRICAL WORK.

 MECHANICAL DRAWINGS FOR ALL MECHANICAL CEILING PENETRATIONS
- 3. SEE PLUMBING DRAWINGS FOR ALL PLUMBING WORK.
- 4. RESOLVE ALL DISCREPANCIES WITH CONTRACTOR AND/OR ARCHITECT PRIOR TO DEMOLITION.
- 4. ALL WORK TO BE IN ACCORDANCE WITH ALL CODES AND ACCESSIBILITY REQUIREMENTS.
- 5. CONTRACTOR TO VERIFY ALL DIMENSIONS IN FIELD.6. SEE SHEET A1.2 AND A1.3 FOR WALL TYPES

AND MECHANICAL WORK.

7. INFILL OPENING ABOVE DOOR WITH MASONRY CONCRETE UNITS TO MATCH EXISTING ADJACENT.

O 1	KEYNOTES
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- 1. PORTION OF EXISTING MEZZANINE TO REMAIN
- 2. EXISTING WALL CMU WALL BELOW TO REMAIN
- 3. EXISTING WOOD STUD / PEGBOARD WALL ON TOP OF CMU WALL TO REMAIN

X	X	X
	$\langle \ \rangle$	\langle
\times	\times	X

MEZZANINE TO REMAIN. THE MAIN FLOOR CEILINGS ARE ATTACHED TO MEZZANINE STRUCTURE AND ARE TO REMAIN INTACT.

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LICENSED ARCHITECT AR-92339

AR-92339

O1-28-22

JAMES WYATT STATE OF IDAHO

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IDAHO STATE UNIVERSITY
POCATELLO, IDAHO

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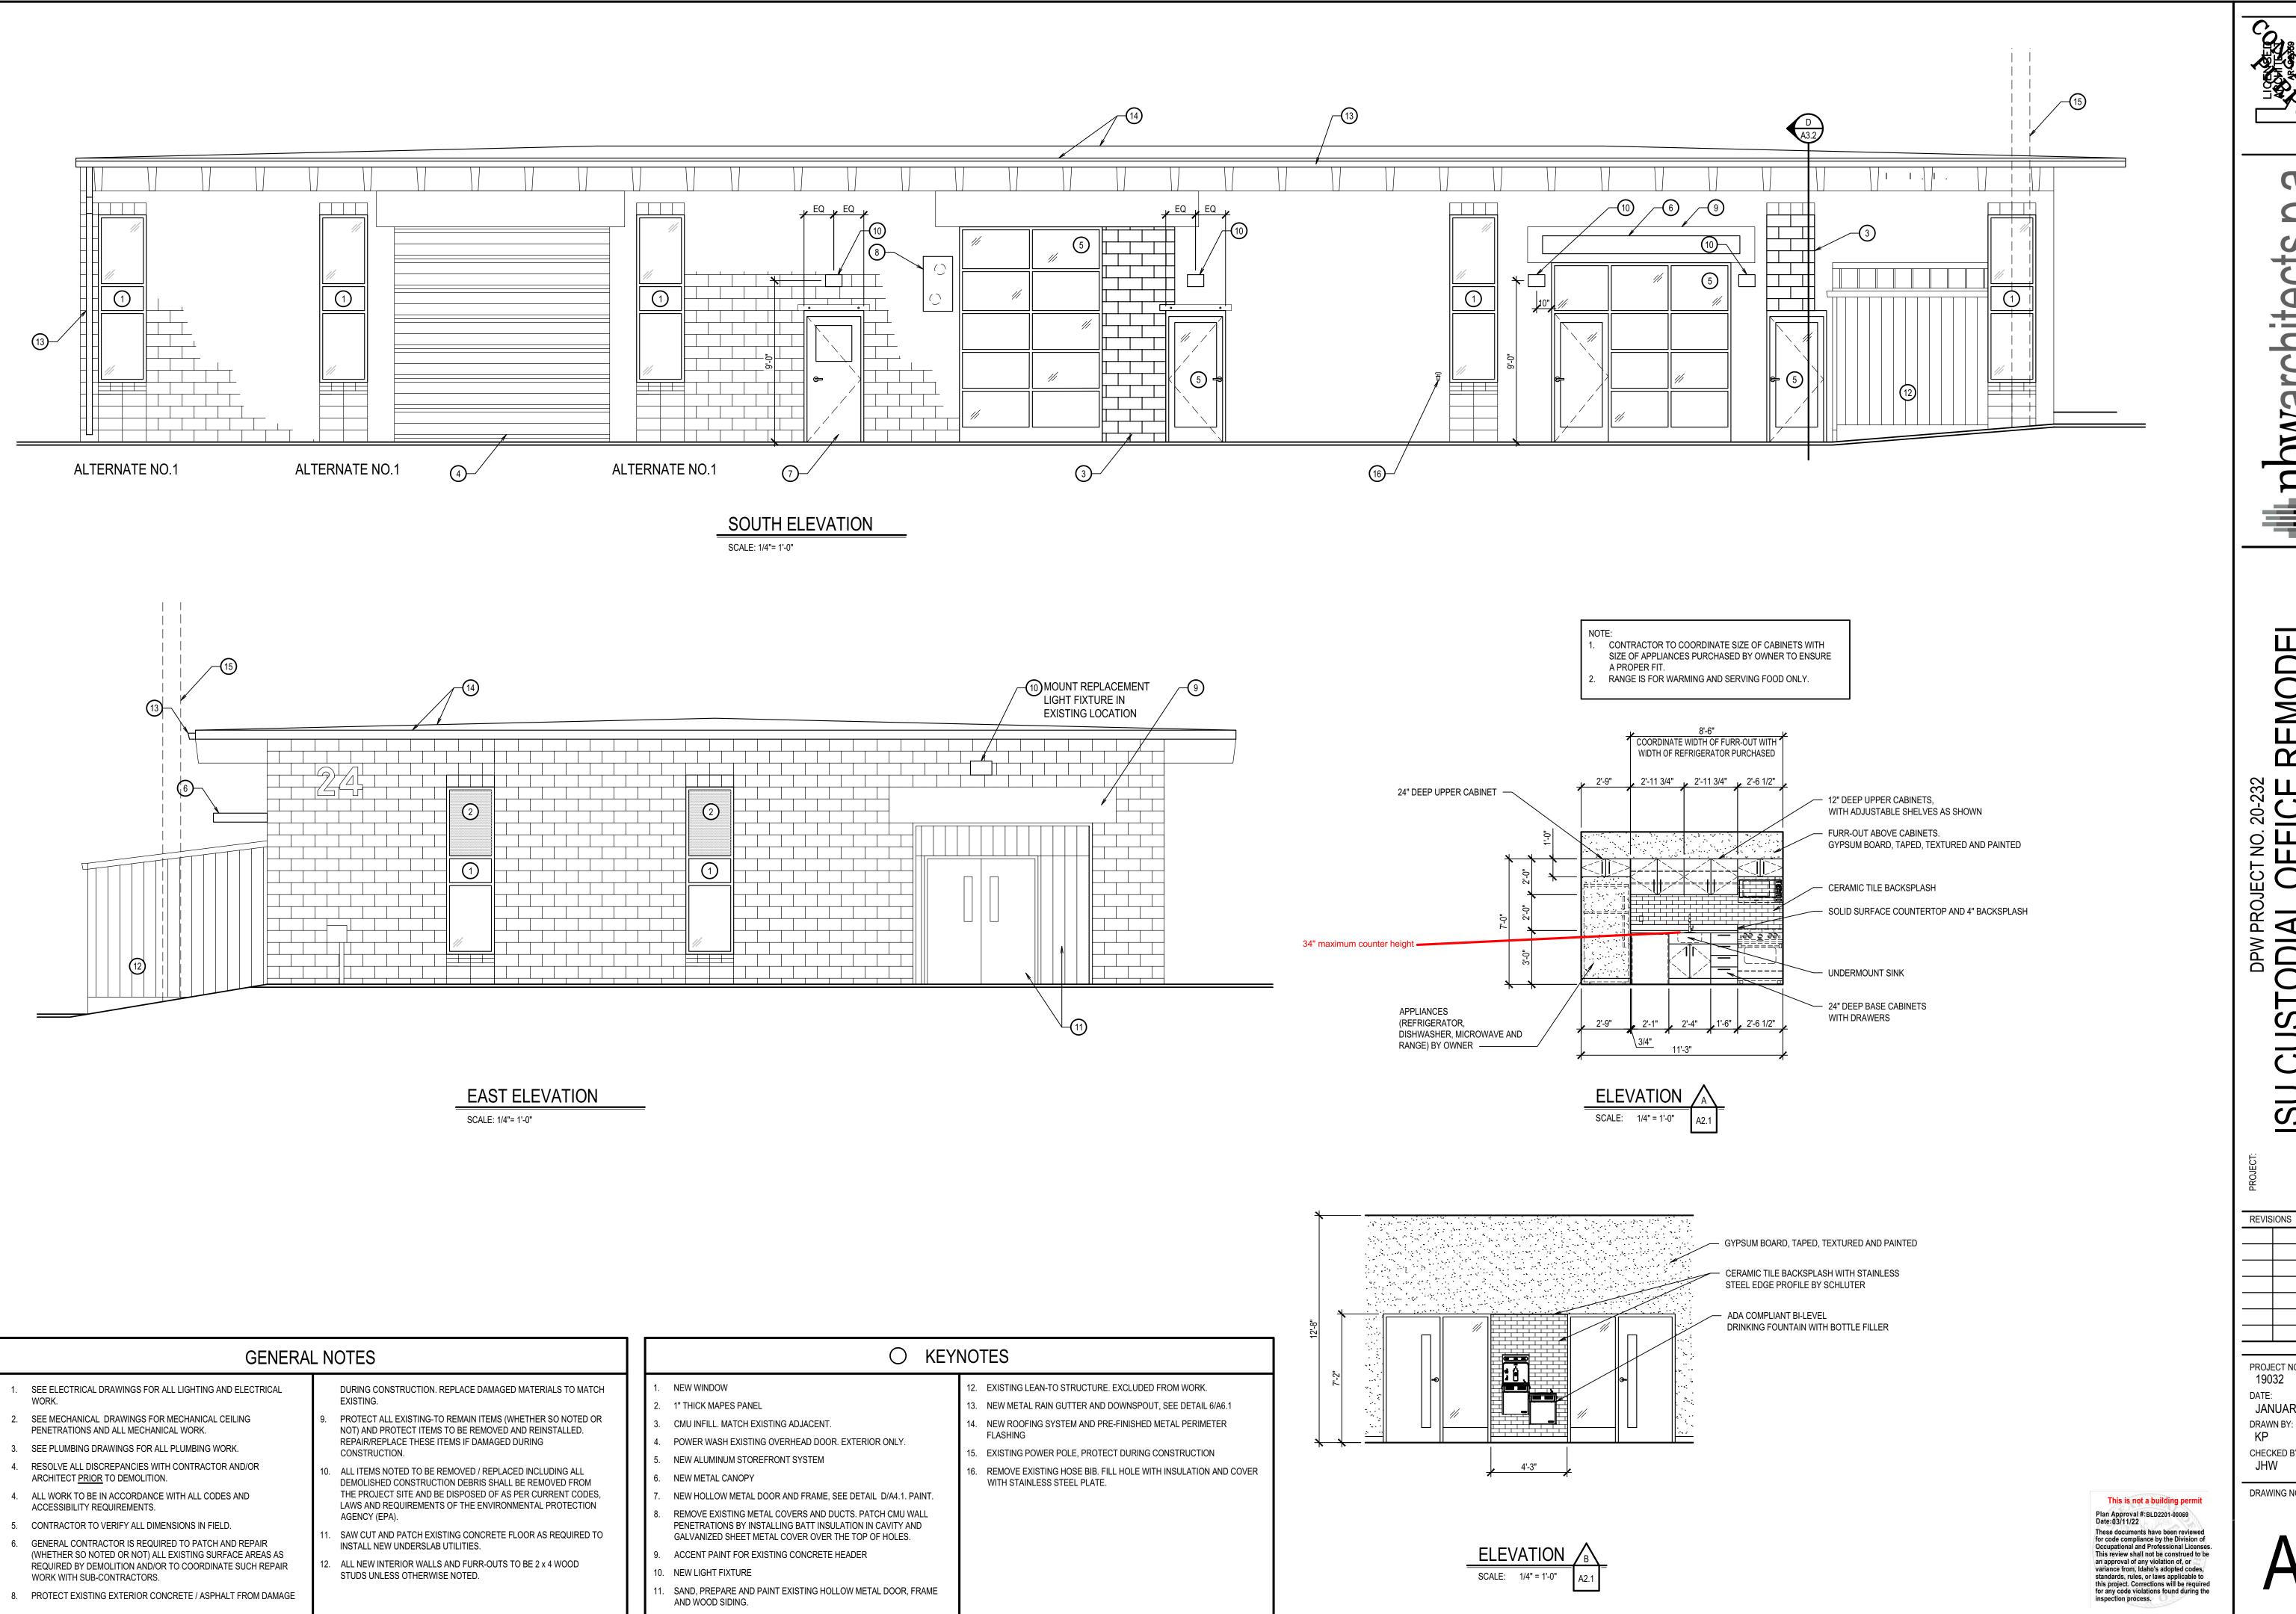
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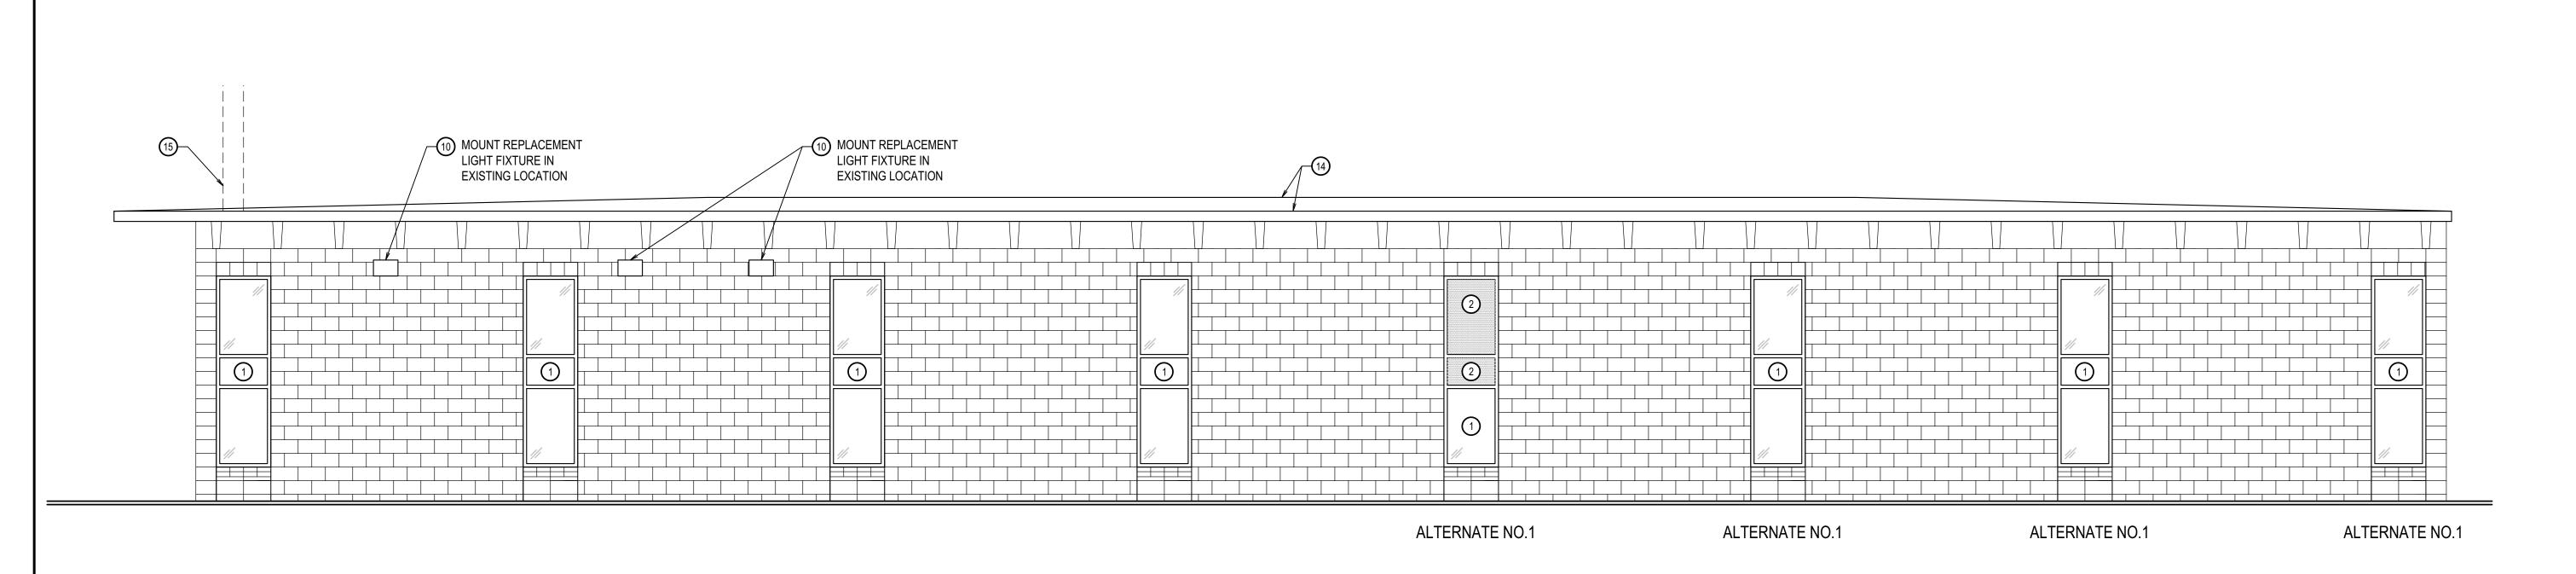


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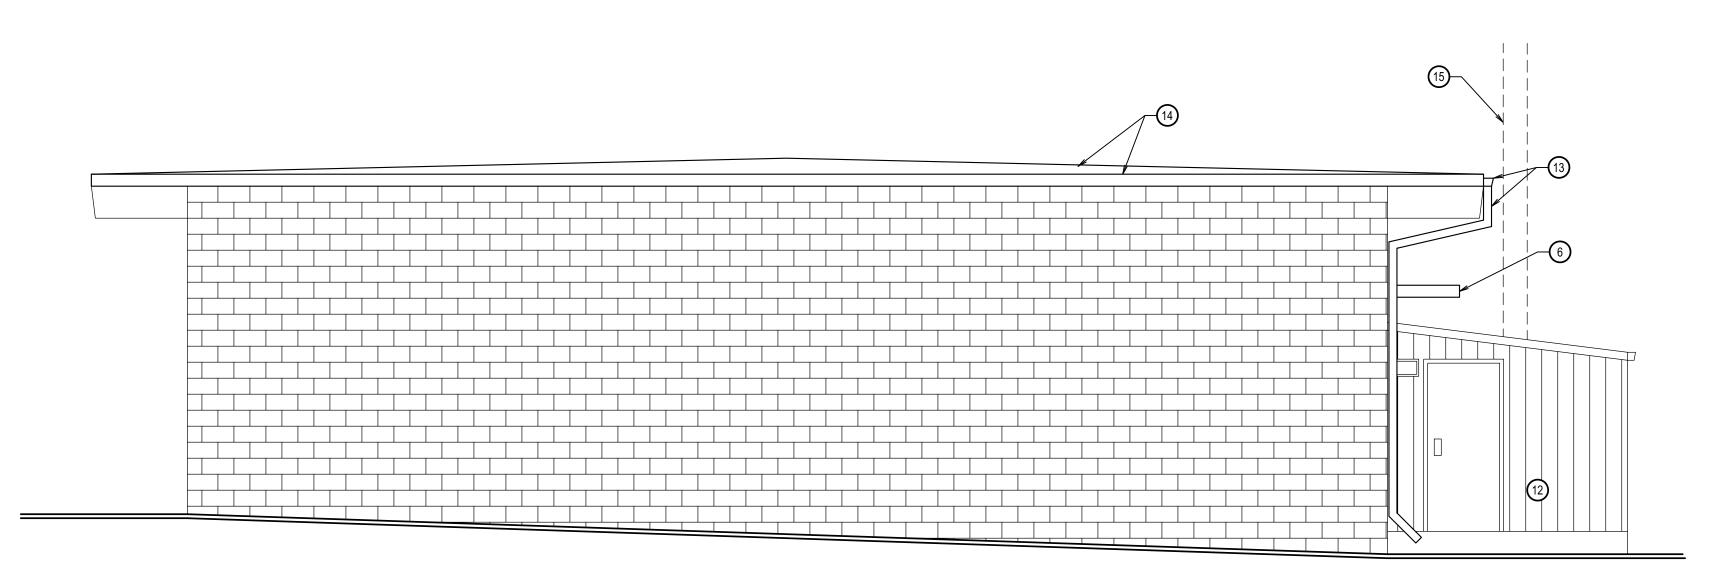
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19032 DATE: JANUARY 2022 DRAWN BY: KP CHECKED BY:



NORTH ELEVATION

SCALE: 1/4"= 1'-0"



WEST ELEVATION

SCALE: 1/4"= 1'-0"

GENERAL NOTES

- SEE ELECTRICAL DRAWINGS FOR ALL LIGHTING AND ELECTRICAL
- SEE MECHANICAL DRAWINGS FOR MECHANICAL CEILING PENETRATIONS AND ALL MECHANICAL WORK.
- SEE PLUMBING DRAWINGS FOR ALL PLUMBING WORK.
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- PROTECT EXISTING EXTERIOR CONCRETE / ASPHALT FROM DAMAGE

- DURING CONSTRUCTION. REPLACE DAMAGED MATERIALS TO MATCH
- - PROTECT ALL EXISTING-TO REMAIN ITEMS (WHETHER SO NOTED OR NOT) AND PROTECT ITEMS TO BE REMOVED AND REINSTALLED. REPAIR/REPLACE THESE ITEMS IF DAMAGED DURING CONSTRUCTION.
 - ALL ITEMS NOTED TO BE REMOVED / REPLACED INCLUDING ALL DEMOLISHED CONSTRUCTION DEBRIS SHALL BE REMOVED FROM THE PROJECT SITE AND BE DISPOSED OF AS PER CURRENT CODES, LAWS AND REQUIREMENTS OF THE ENVIRONMENTAL PROTECTION AGENCY (EPA).
 - SAW CUT AND PATCH EXISTING CONCRETE FLOOR AS REQUIRED TO

INSTALL NEW UNDERSLAB UTILITIES.

ALL NEW INTERIOR WALLS AND FURR-OUTS TO BE 2 x 4 WOOD STUDS UNLESS OTHERWISE NOTED.

KEYNOTES

- **NEW WINDOW** 2. 1" THICK MAPES PANEL
- 3. CMU INFILL. MATCH EXISTING ADJACENT. FLASHING
- 4. NEW CMU WINDOW SILL. MATCH EXISTING ADJACENT. NEW ALUMINUM STOREFRONT SYSTEM
- NEW METAL CANOPY
- NEW HOLLOW METAL DOOR AND FRAME, SEE DETAIL D/A4.1. PAINT.
- REMOVE EXISTING METAL COVER AND DUCTS. PATCH CMU WALL PENETRATIONS BY INSTALLING BATT INSULATION IN CAVITY AND GALVANIZED SHEET METAL OVER THE TOP OF HOLE.
- 9. ACCENT PAINT FOR EXISTING CONCRETE HEADER
- 10. NEW LIGHT FIXTURE
- SAND, PREPARE AND PAINT EXISTING HOLLOW METAL DOOR, FRAME AND WOOD SIDING.

- 12. EXISTING LEAN-TO STRUCTURE. EXCLUDED FROM WORK.
- 13. NEW METAL RAIN GUTTER AND DOWNSPOUT, SEE DETAIL 6/A6.1
- 14. NEW ROOFING SYSTEM AND PRE-FINISHED METAL PERIMETER
- 5. EXISTING POWER POLE, PROTECT DURING CONSTRUCTION
- REMOVE EXISTING HOSE BIB. FILL HOLE WITH INSULATION AND COVER
- WITH STAINLESS STEEL PLATE.
- POWER WASH EXISTING OVERHEAD DOOR. EXTERIOR ONLY.

Dbwarchitects D.a.

RRCHITECTURE/PLANNING/INTERIORS

990 JOHN RORMS PARKWAY / P.O. BON 2212 / IOAHO FALLS, IOAHO 83403-2212

[P] 208.522.8779 [F] 208.522.8785 [W] nbwarchitects.com

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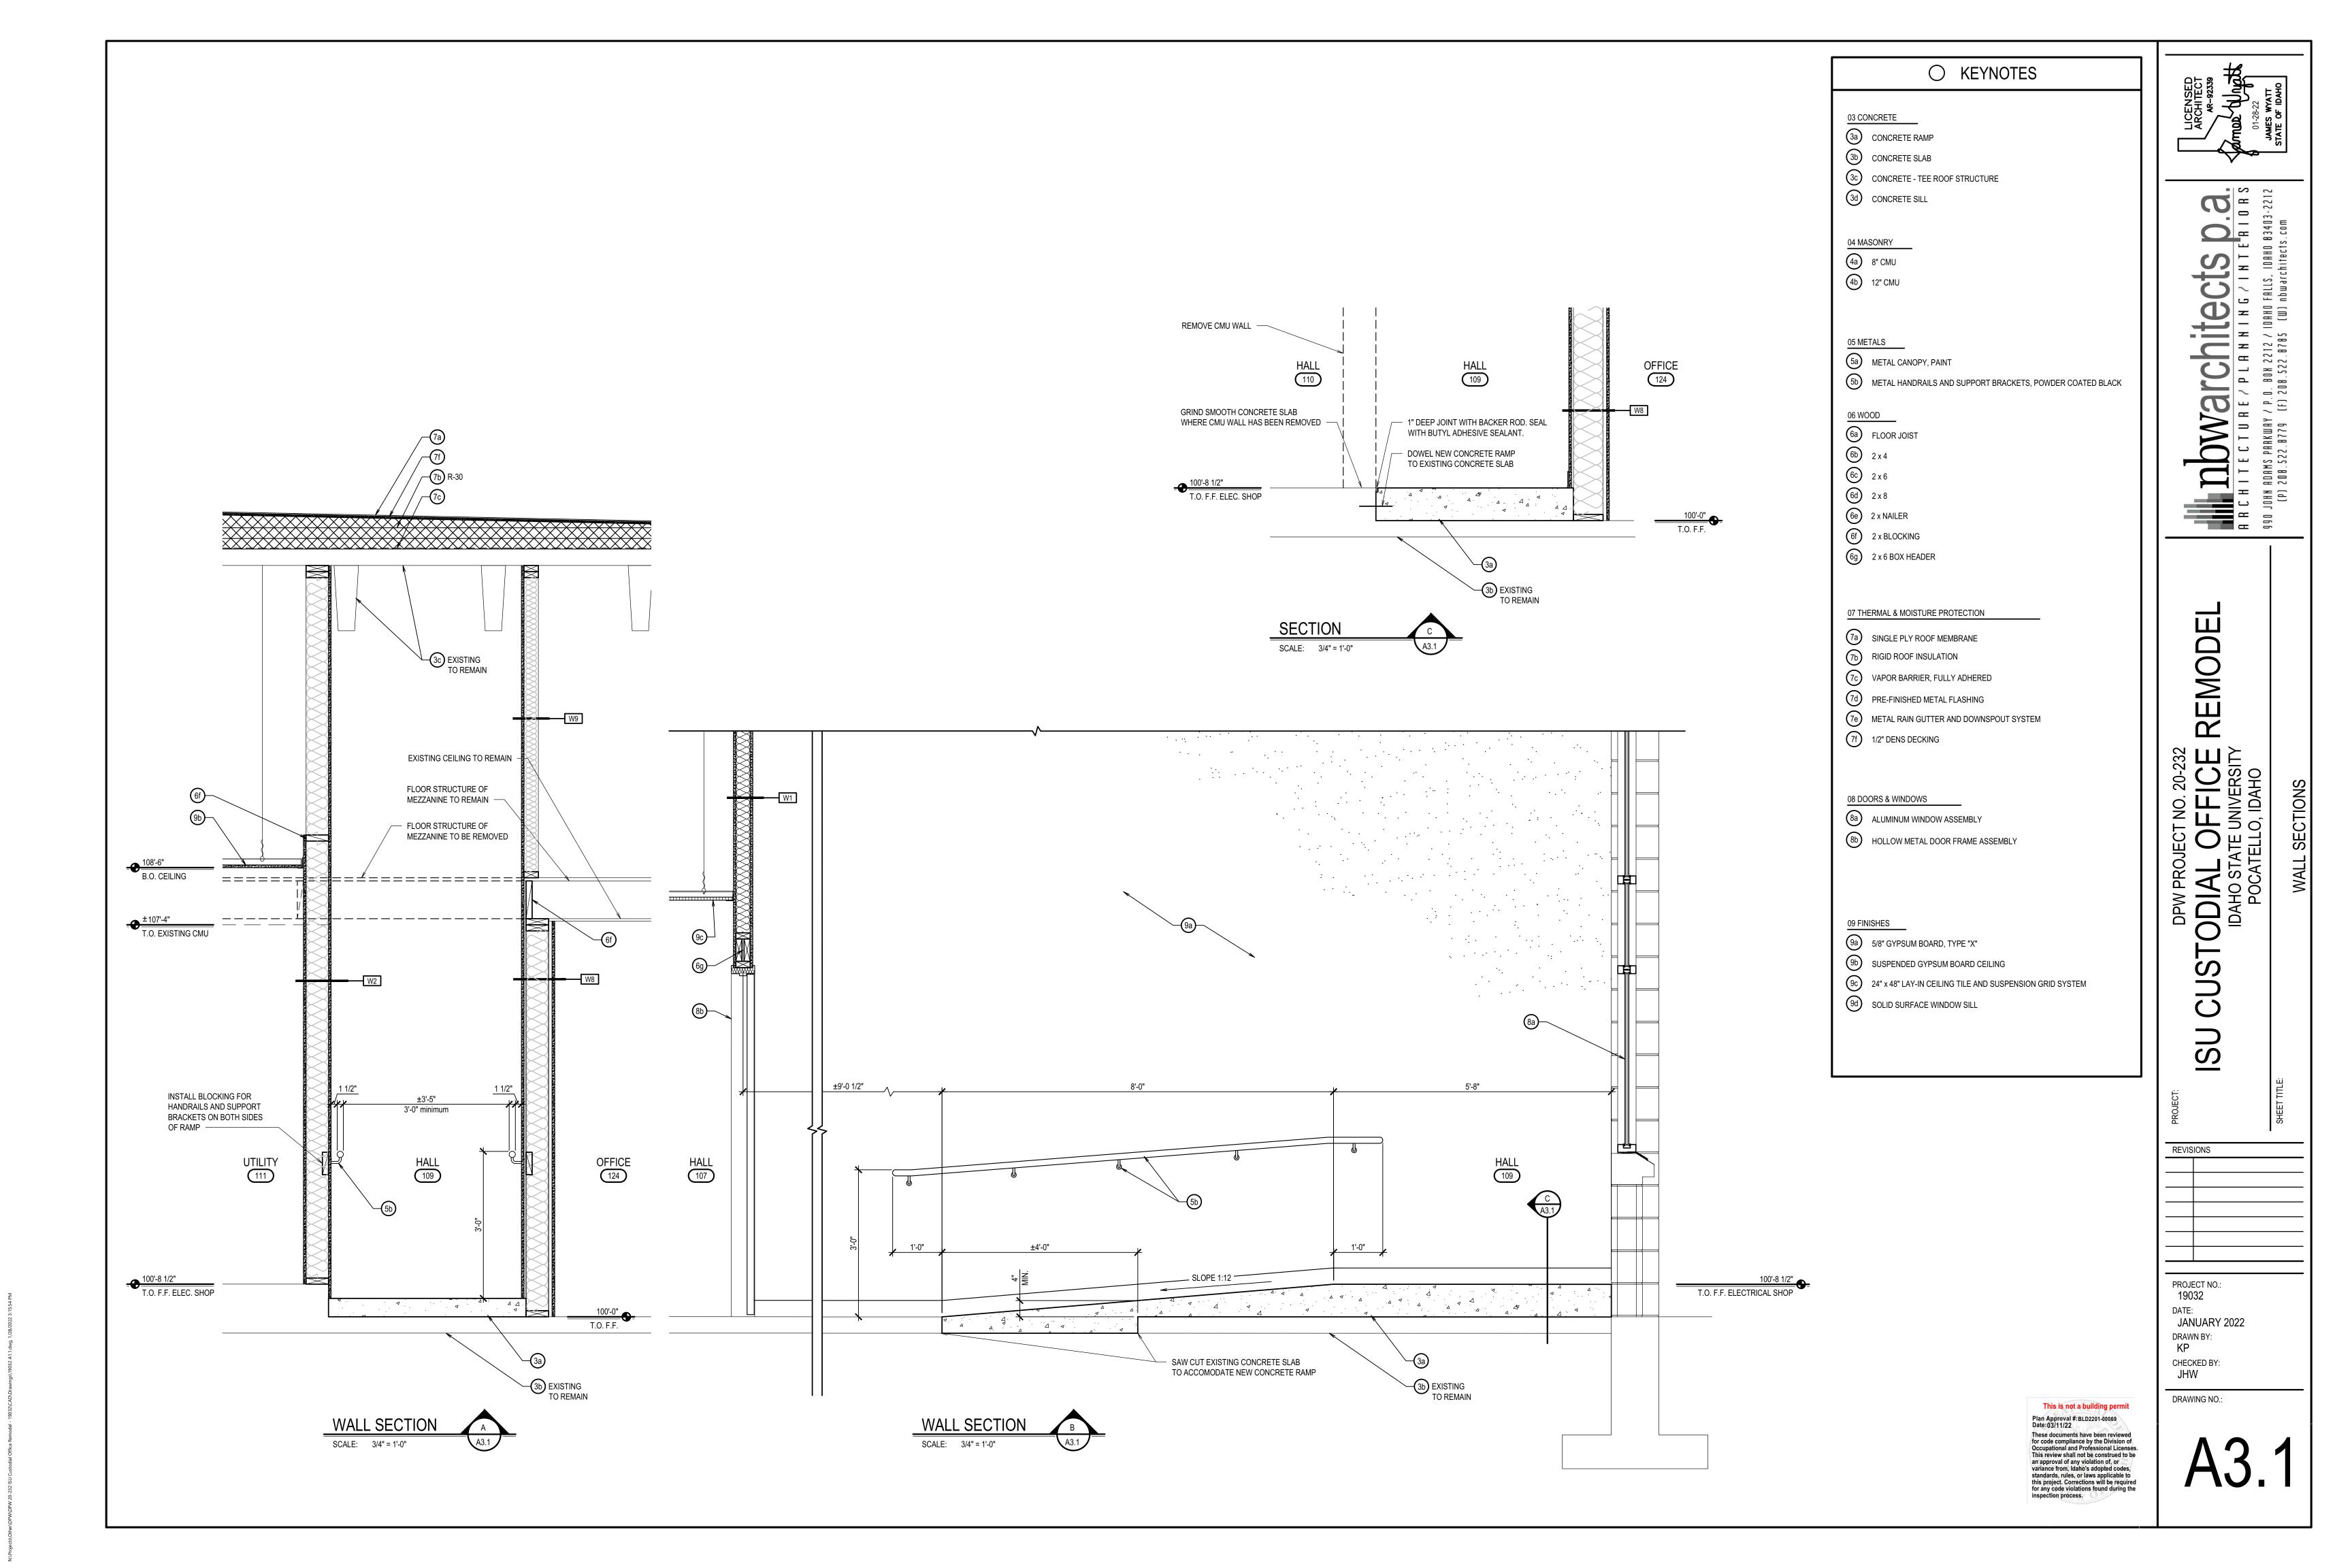
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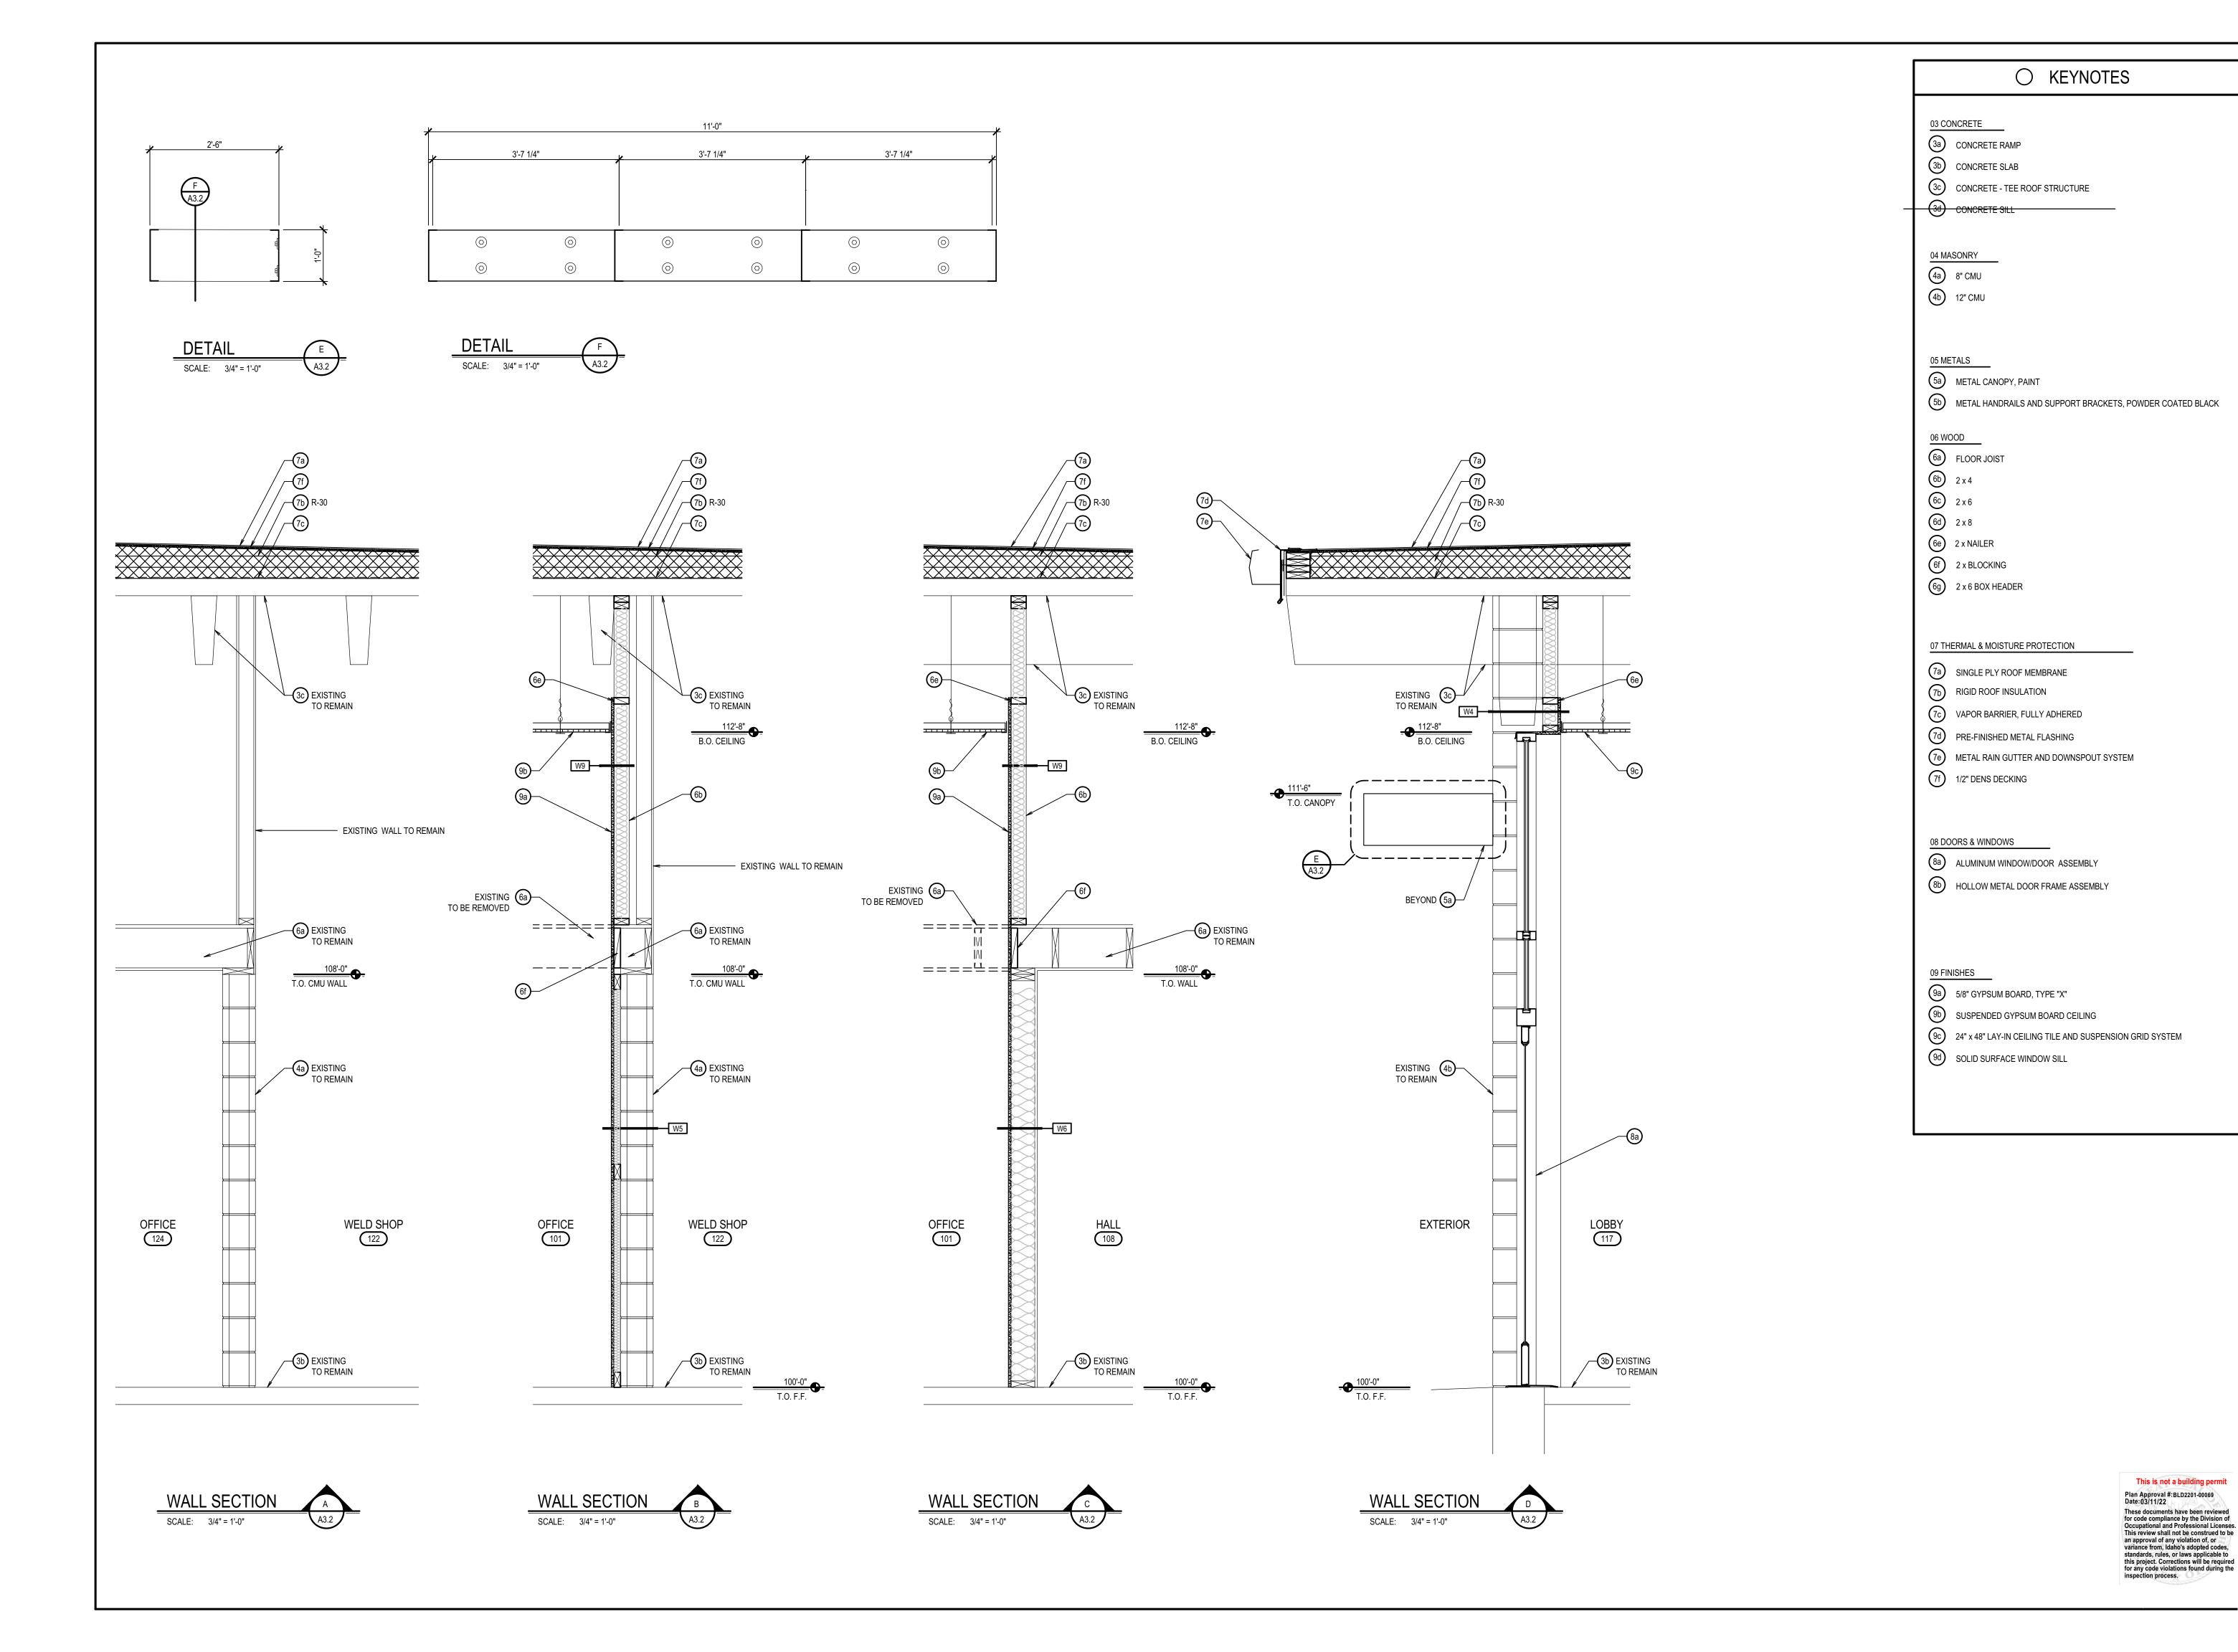
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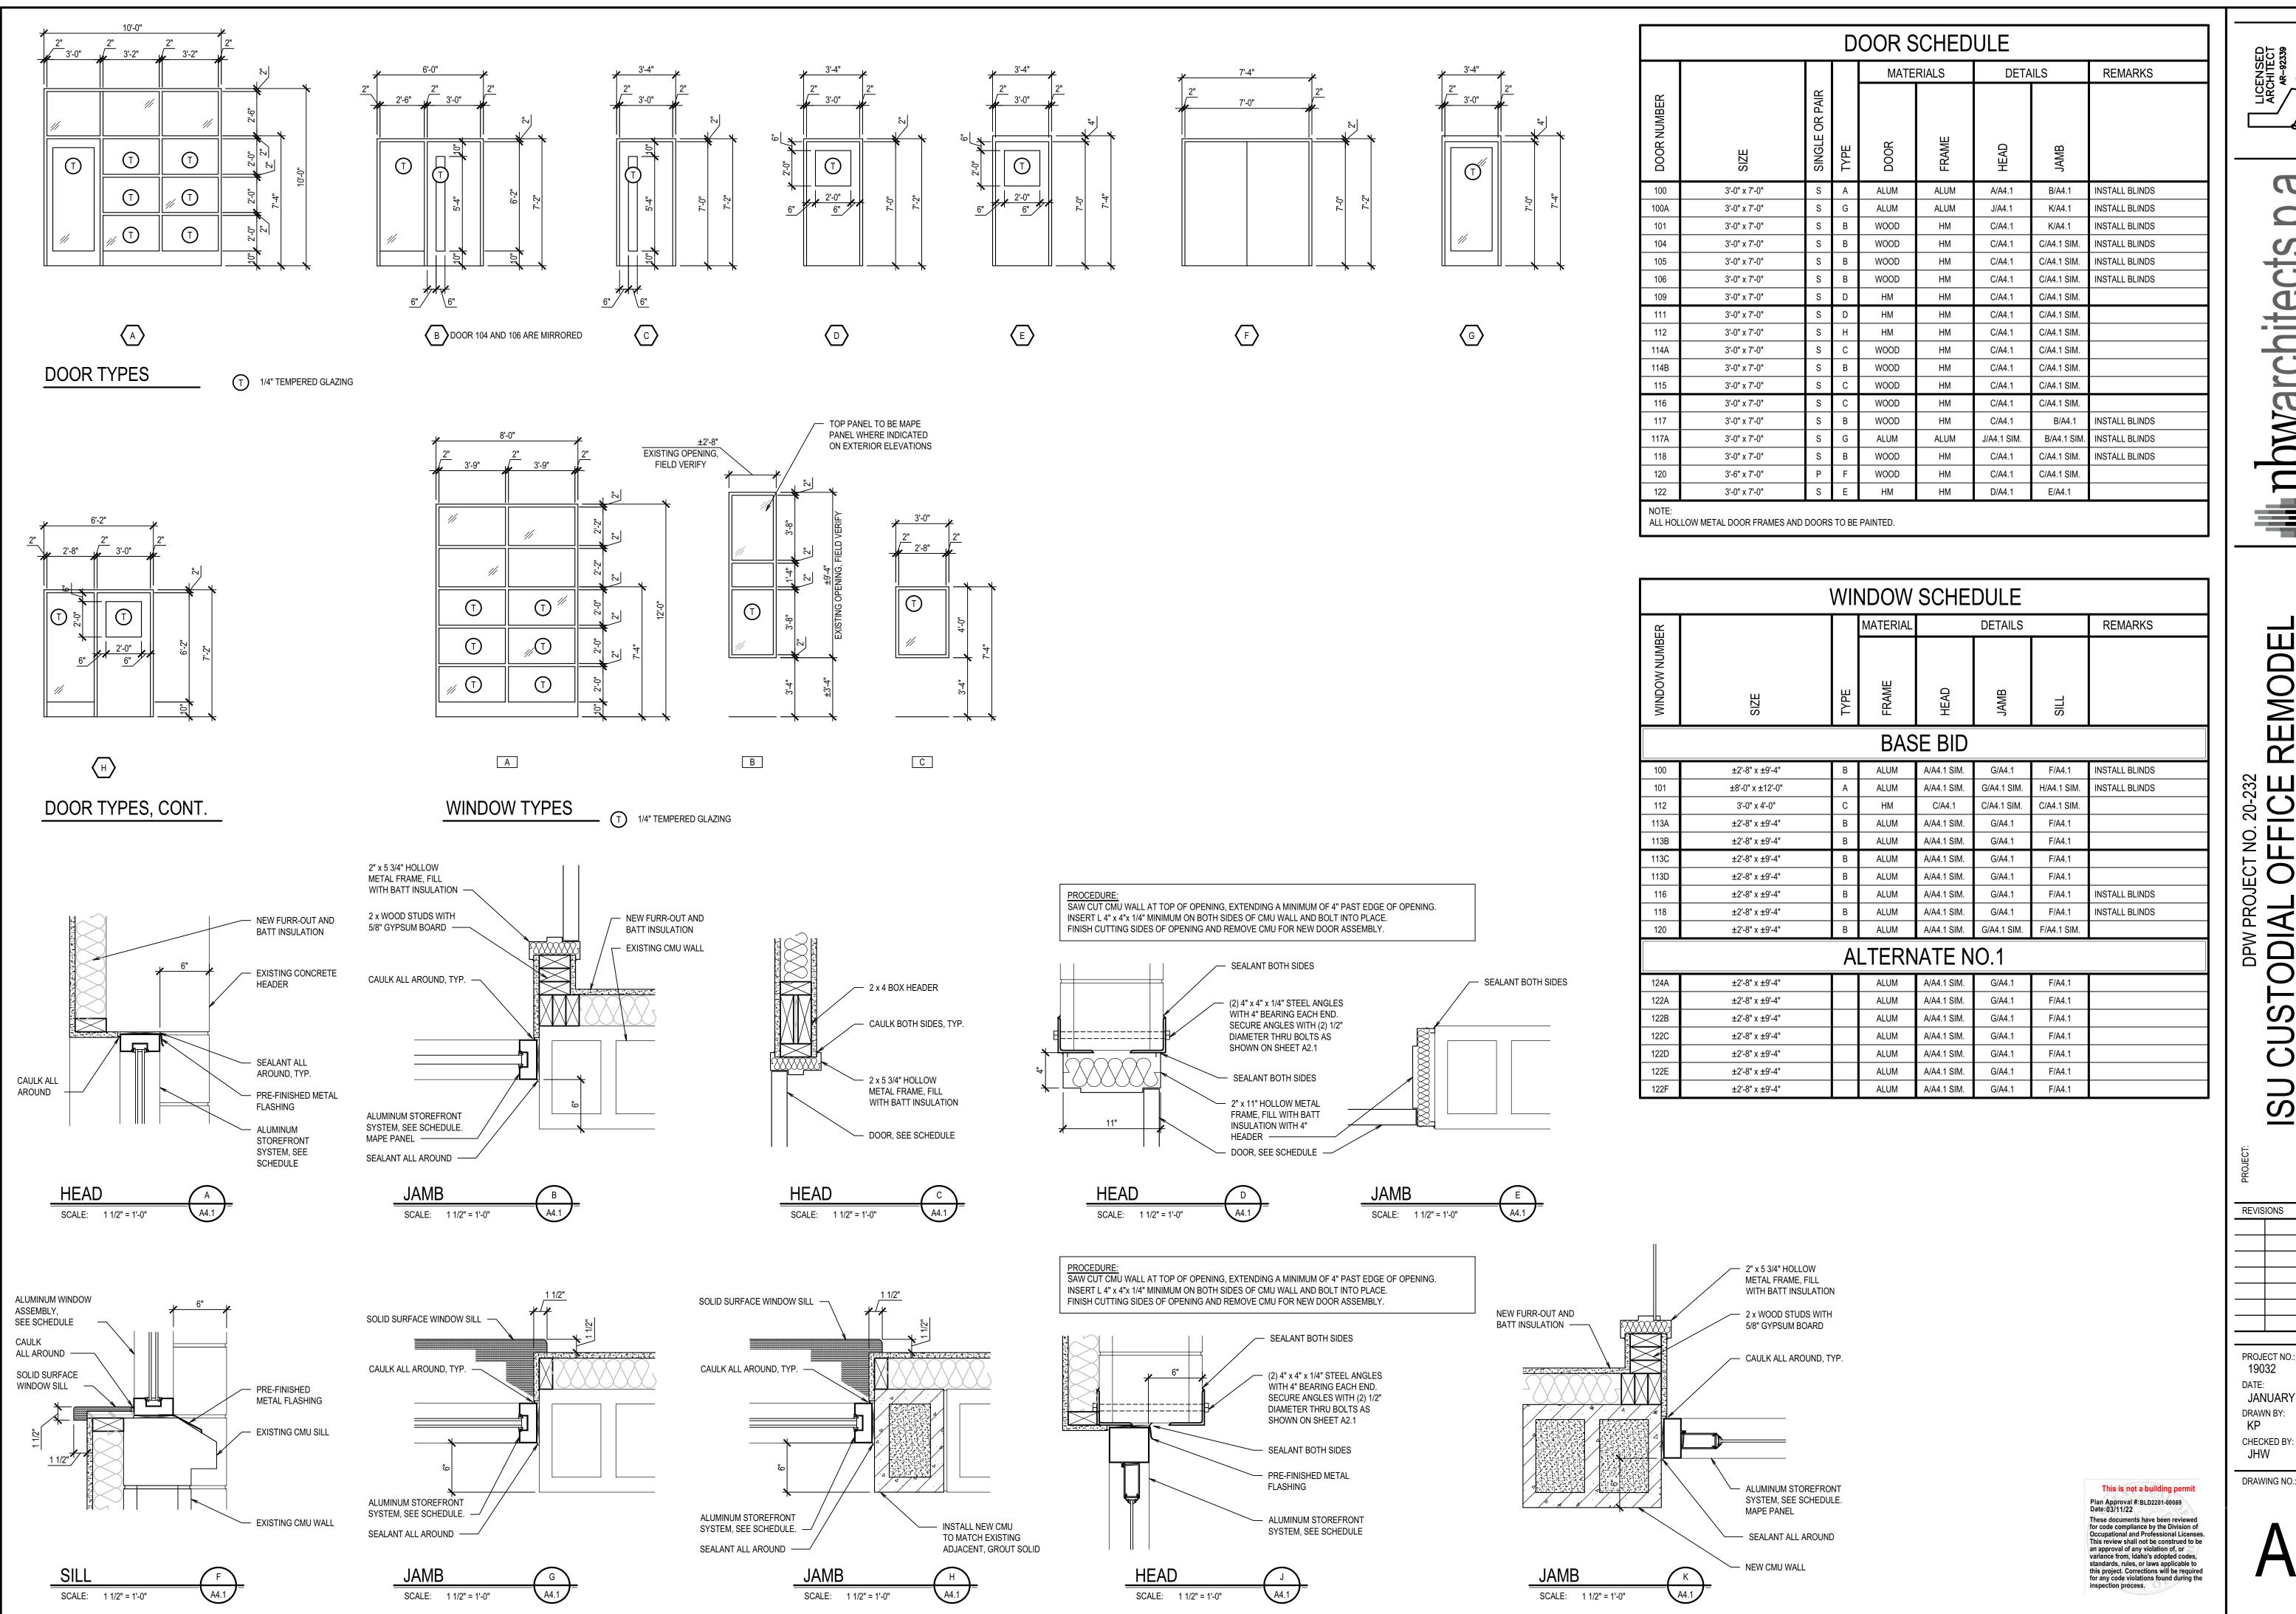
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REVISIONS PROJECT NO.: 19032

DATE: JANUARY 2022 DRAWN BY: KP CHECKED BY:




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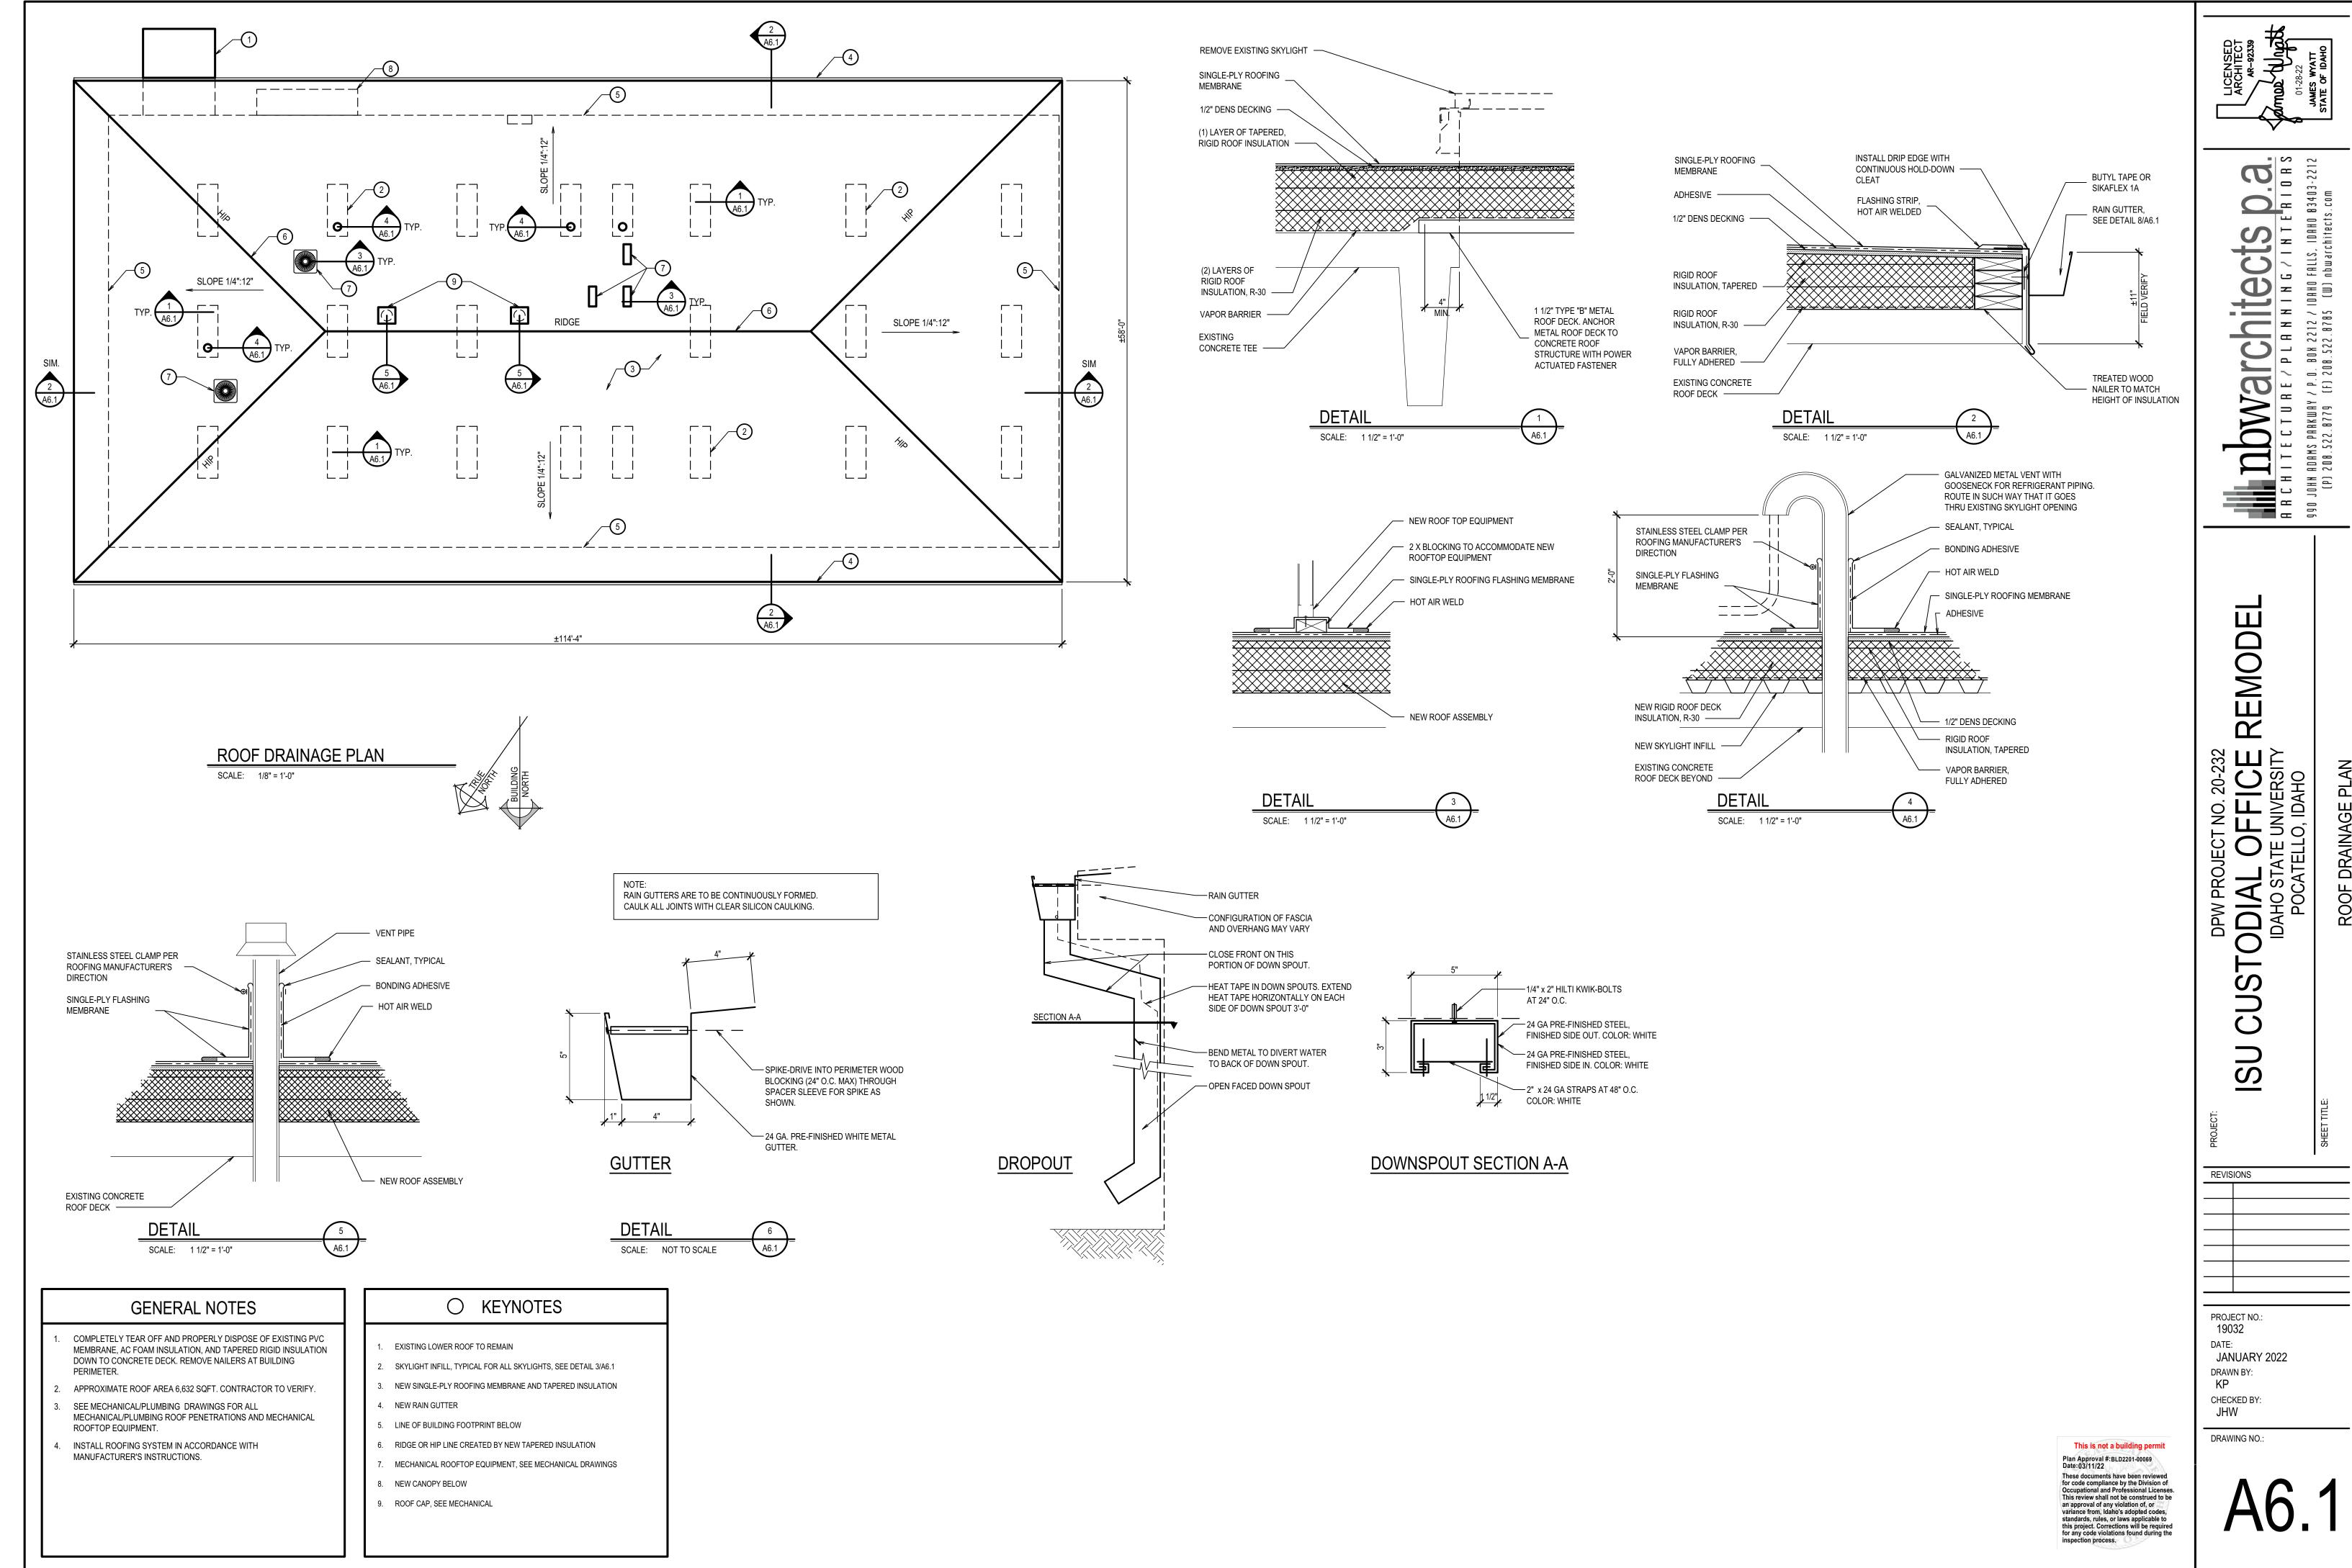
A DWarchitects D. a. GROUND BOX 2212 / IDAHO B3403-2212 (P) 208.522.8779 (F) 208.522.8785 (W) nbwarchitects.com


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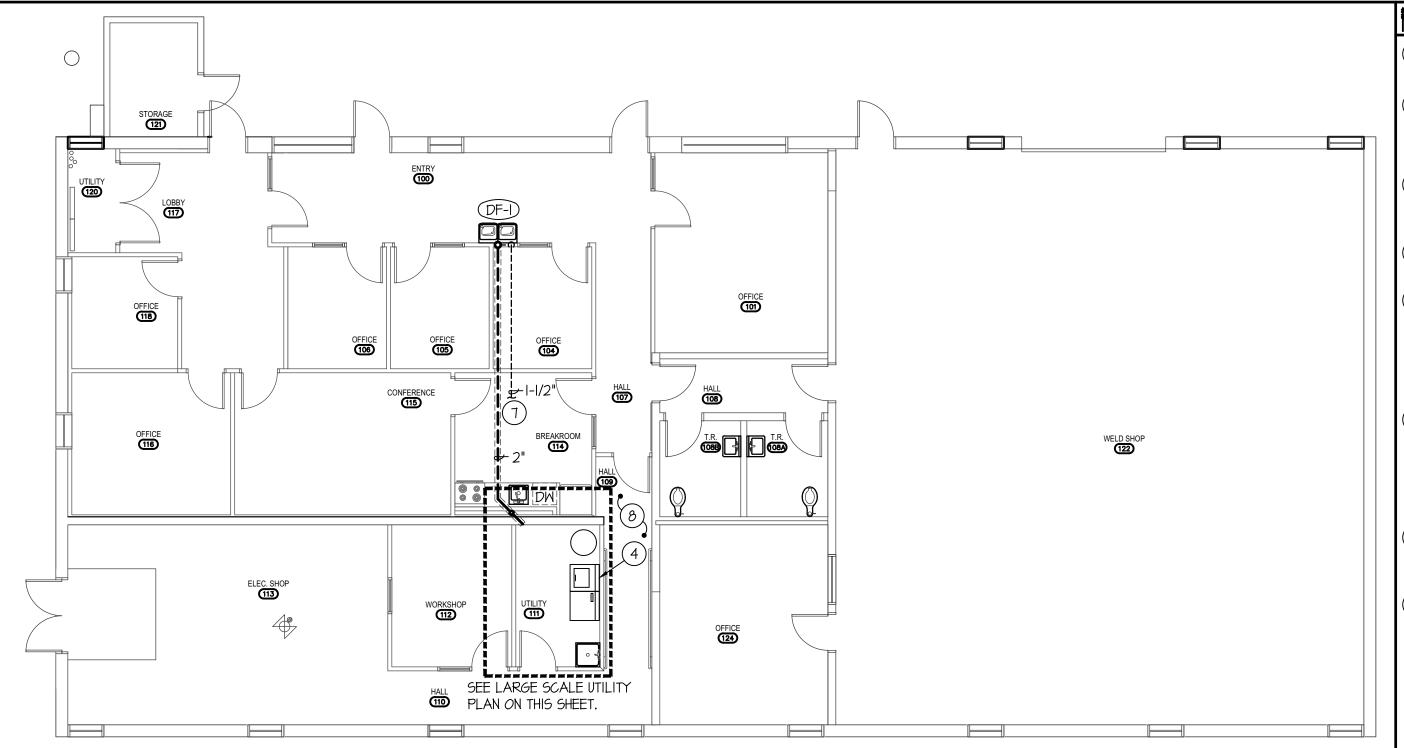
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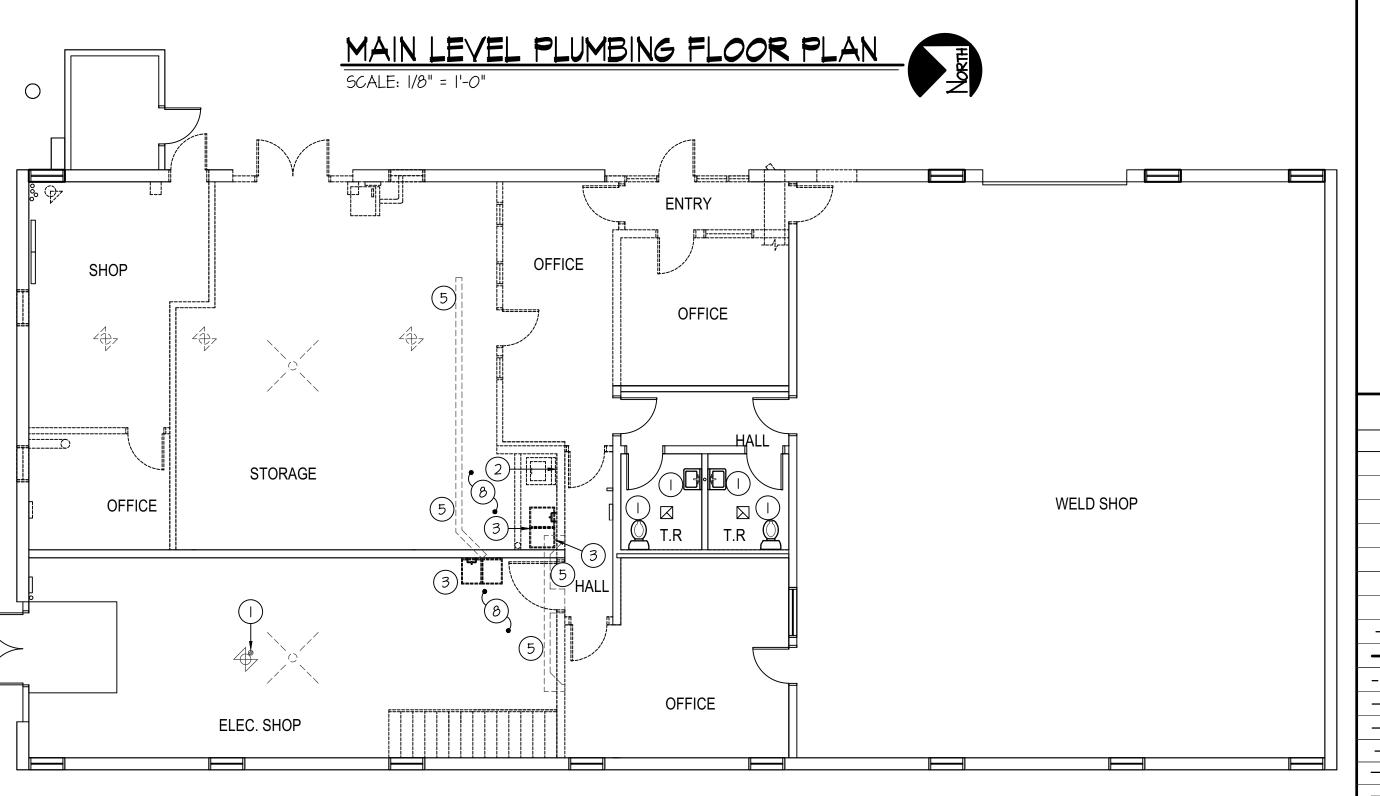
JANUARY 2022 CHECKED BY:







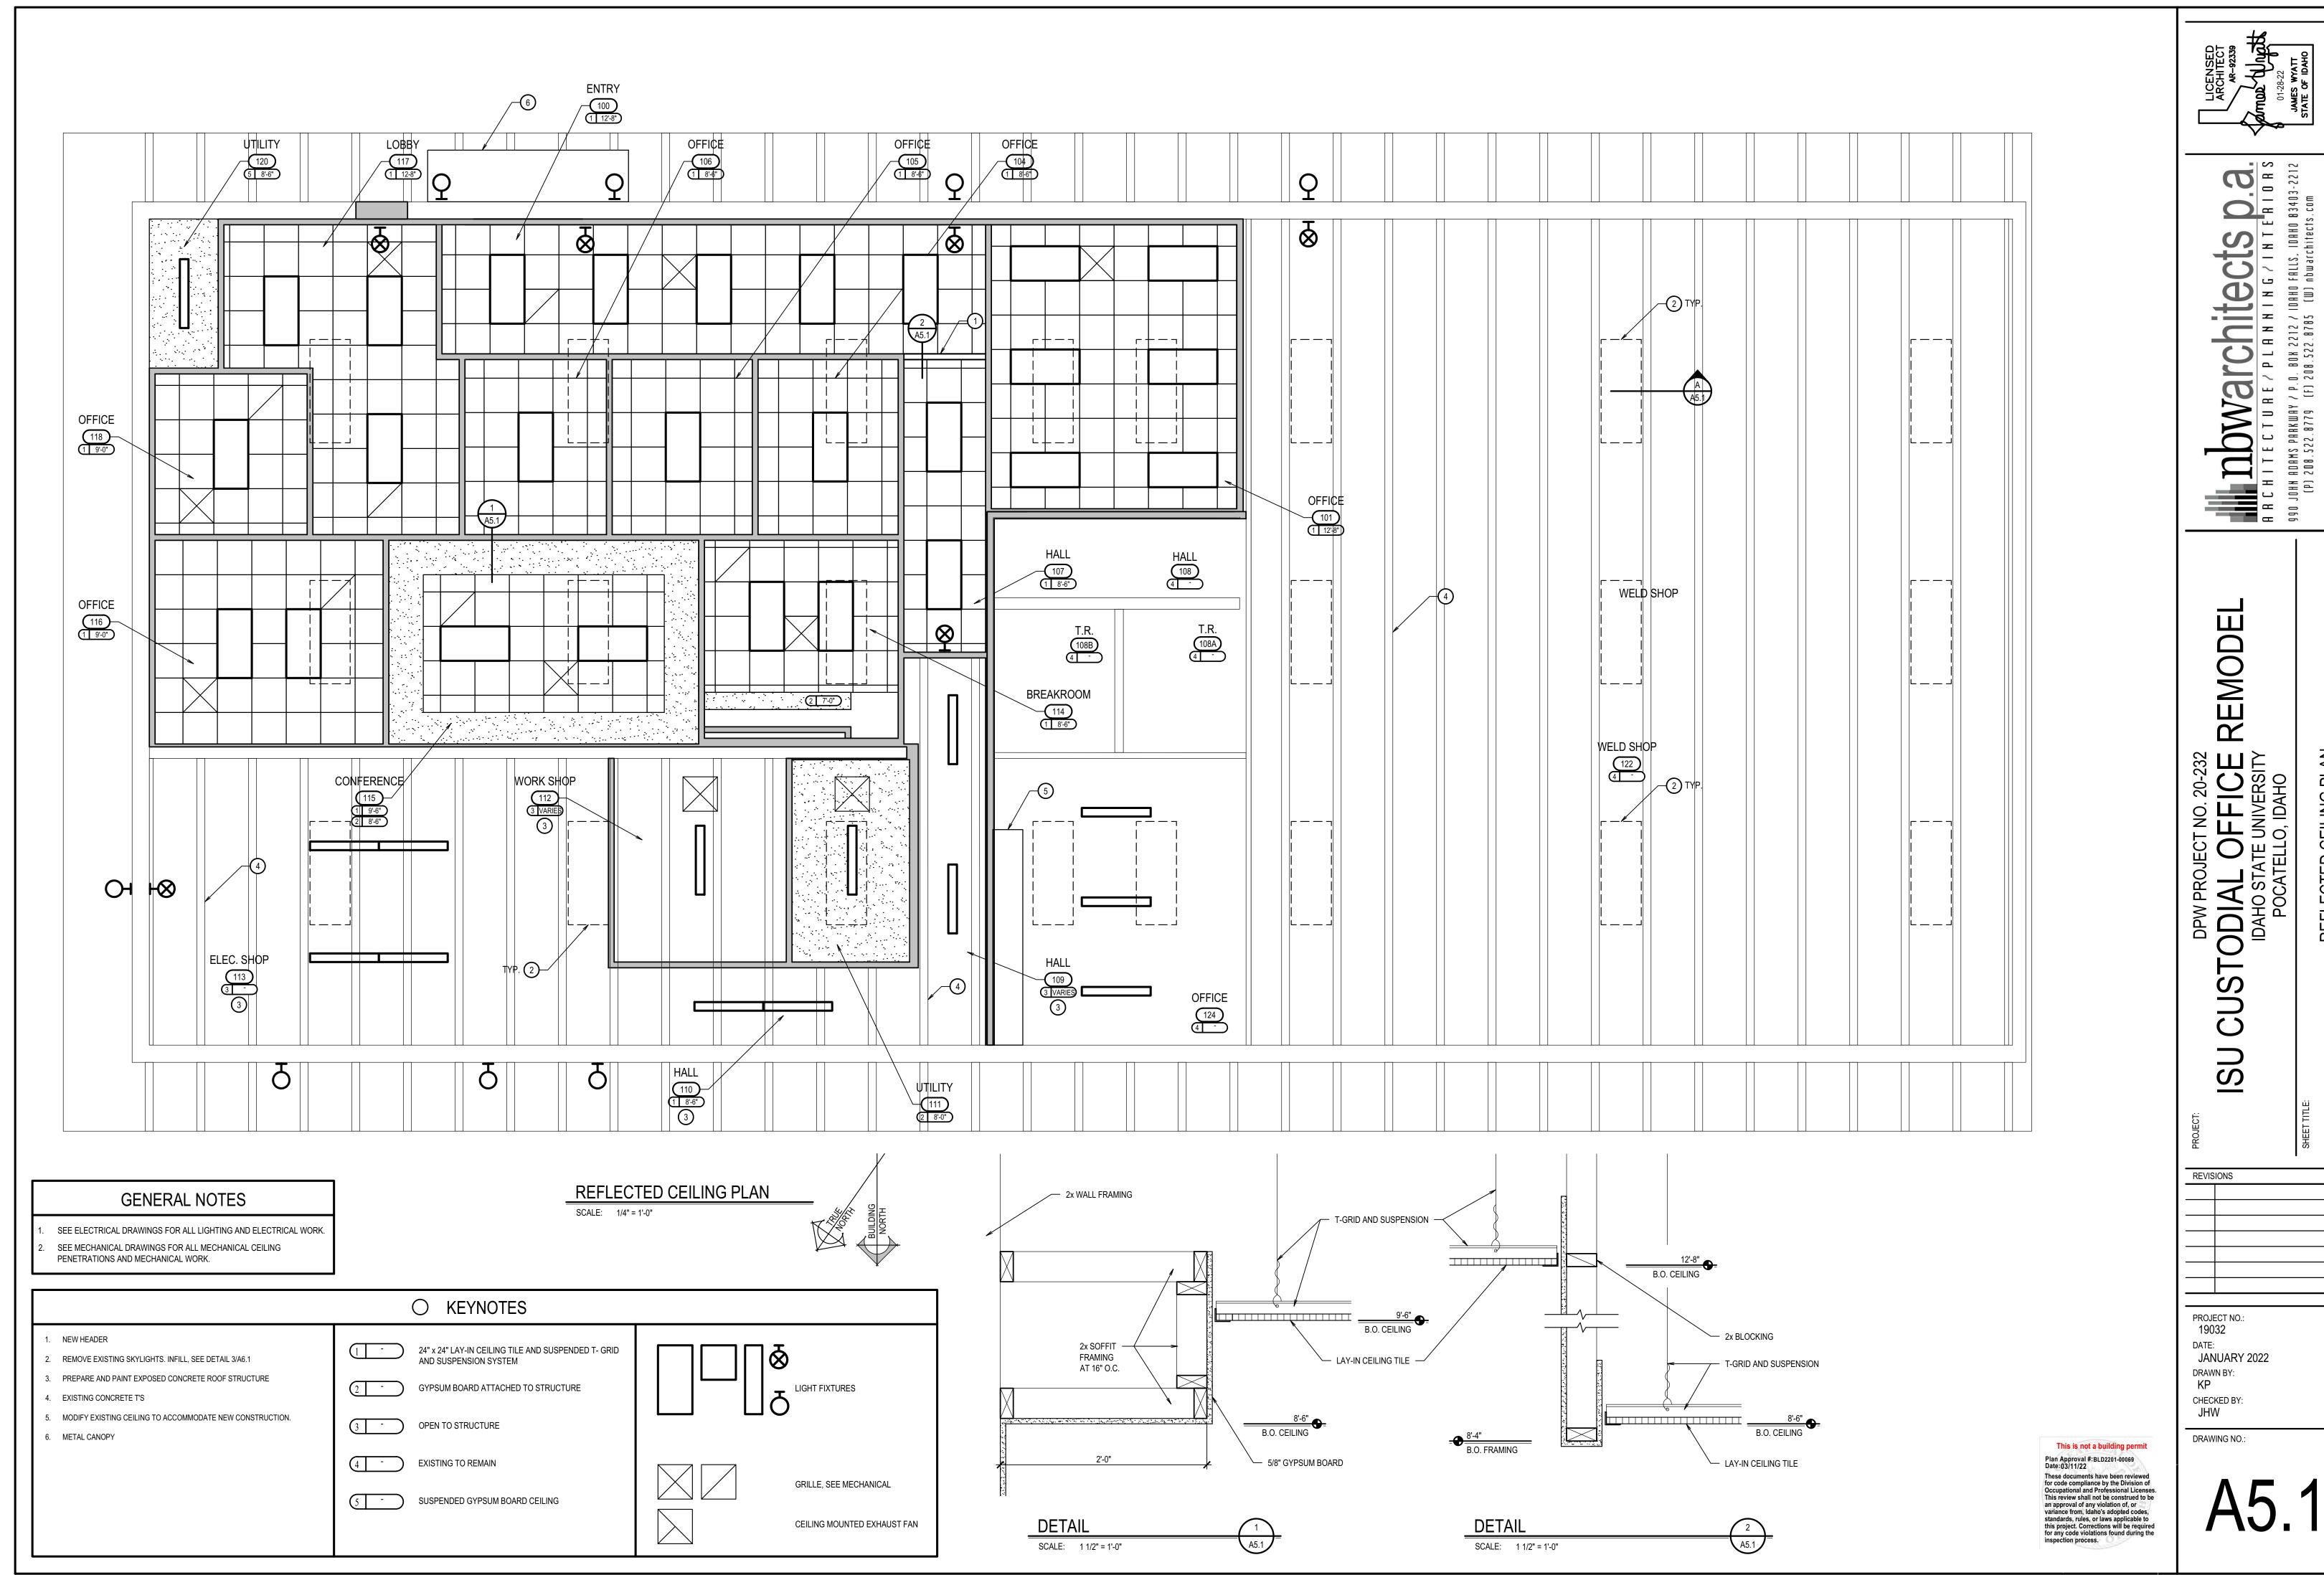

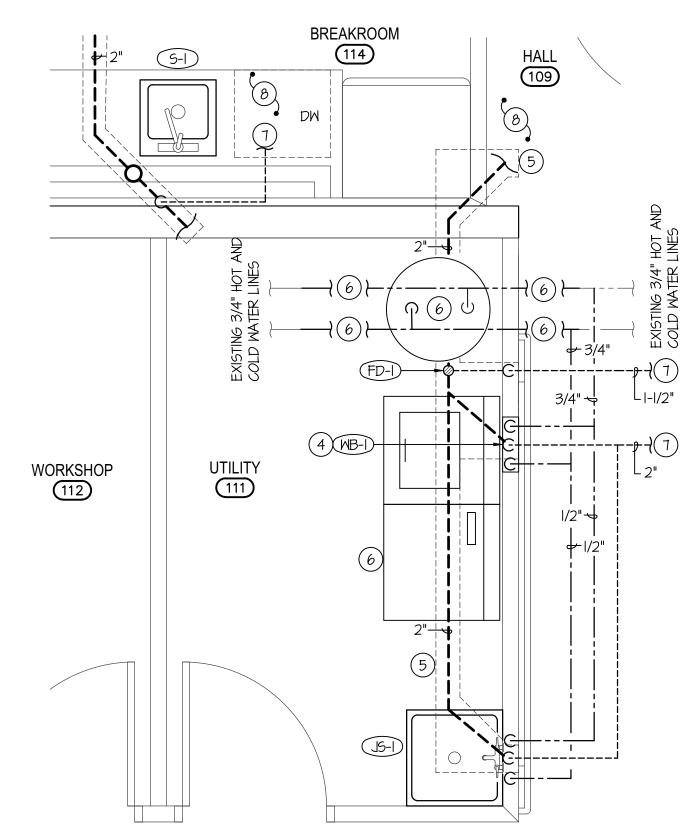

MAIN LEVEL DEMO PLUMBING FLOOR PLAN SCALE: 1/8" = 1'-0"



GENERAL NOTES:

- A- THE CONTRACTOR SHALL CHECK AND VERIFY ALL DIMENSIONS AND CONNECTIONS ON THE JOB SITE. ALL WORK SHALL BE EXECUTED FROM MEASUREMENTS TAKEN AT THE SITE.
- B- THE MECHANICAL CONTRACTOR SHALL BE RESPONSIBLE TO INSURE PROPER CODE CLEARANCES FOR ELECTRICAL AND MECHANICAL ACCESS WHEN INSTALLING ANY EQUIPMENT SUPPLIED BY THE MECHANICAL CONTRACTOR.
- C- IT IS CRITICAL THAT THIS CONTRACTOR COORDINATE EQUIPMENT LOCATIONS WITH PIPING, DUCTWORK, ELECTRICAL CONDUIT AND BUILDING STRUCTURE TO INSURE CODE COMPLIANCE.
- D- CEILING DIFFUSERS ARE SHOWN IN APPROXIMATE LOCATIONS. REFER TO LIGHTING PLANS AND REFLECTED CEILING PLAN FOR EXACT LOCATIONS.
- E- DUCT DIMENSIONS CALLED OUT ON DRAWINGS ARE INSIDE FREE AREA DIMENSIONS. ACOUSTICAL DUCT LINER ARE TO BE ADDED TO OVERALL MEASUREMENTS.
- ALL DUCTWORK AND PIPING WHICH PASSES THRU FIRE RATED WALLS TO BE FIRE STOPPED WITH APPROVED FOAM OR SEALANT. REFER TO SPECIFICATIONS FOR APPROVED MANUFACTURES.

	PL	AN	NO	TES
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) EXISTING FIXTURE TO REMAIN. PROTECT DURING CONSTRUCTION.

UNDER SLAB AND ABANDON.

- 2) EXISTING WASH BOX TO BE REMOVED AND DISPOSED OF. EXISTING WATER AND VENT TO BE REMOVED AND CAPPED IN CEILING SPACE. CAP WASTE BELOW SLAB
- AND ABANDON. (3) EXISTING SINK TO BE REMOVED AND DISPOSED OF.

CAP WASTE, WATER AND VENT IN CEILING SPACE OR

D. 20. 1 E R 1 D R S HD 83403-2212


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- (4) INSTALL NEW WASH BOX IN THIS LOCATION. SEE DETAILS ON SHEET P2.1
- (5) SAW CUT FLOOR IN LOCATION AS SHOWN ON PLANS FOR NEW 2" WASTE LINE AND FLOOR DRAIN. MODIFY CUT AS REQUIRED FOR EXISTING WASTE LINE LOCATION AND ROUTE. COORDINATE WITH GENERAL CONTRACTOR FOR PATCHING AFTER WORK IS COMPLETE.
- (6) RELOCATE EXISTING WATER HEATER IN MEZZANINE SPACE ABOVE TO LOCATION AS SHOWN ON PLANS. RELOCATE CW & HW LINES IN MEZZANINE SPACE TO BELOW FOR NEW LOCATION. WATER LINES AS SHOWN ON PLANS ARE FOR CLARITY, RUN IN NEW CEILING SPACE AS MUCH AS POSSIBLE.
- 7) RUN NEW VENT LINE IN CEILING SPACE TO NEAREST EXISTING 2" OR LARGER. FIELD VERIFY NEAREST 2" LOCATION OR LARGER.
- (8) SCOPE EXISTING WASTE LINE SIZES, ROUTES AND ELEVATIONS BELOW SLAB PRIOR TO CONSTRUCTION AND FIELD VERIFY BEST SAW CUTS AND NEW WASTE

PLUMB	ING LEGEND	
SYMBOL	DESCRIPTION	
V	VENT) E
VTR	VENT THRU ROOF	8 0 8 0 8 0 8 0 8 0 8 0 8 0 8 0 8 0 8 0
CO	CLEANOUT	— Б Н О Н О Н
MCO	WALL CLEANOUT	⇒ — —
COTG	CLEANOUT TO GRADE	
e	PIPE DROP	
0	PIPE RISE	
—-Ф	BALL TYPE ISOLATION VALVE	
	SOIL OR WASTE PIPING	
	VENT LINE PIPING	ت ا
	DOMESTIC COLD WATER PIPING	
	DOMESTIC HOT WATER PIPING	
	HOT WATER RECIRC. PIPING	
<u>——</u> 6——	GAS PIPING	
CD	CONDENSATE DRAIN PIPING	16.01
	ROOF DRAIN PIPING	R 0 J
	ROOF OVERFLOW DRAIN PIPING	۵ .



	Engineered Systems Associates	
1355 E	AST CENTER	
POCATELLO), IDAHO 8320 ⁻	1

PHONE: (208) 233-0501 (208) 233-0529 ||EMAIL: esa@engsystems.com ESA JOB NUMBER: 19085

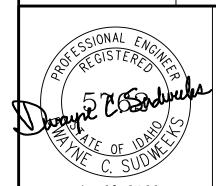
REUISIONS

PROJECT NO, 19085 DATE: JANUARY 2022 DRAWN BY: TDAUIS CHECKED BY:

D S U D W E E K S DRAWING NO.

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inspection process.

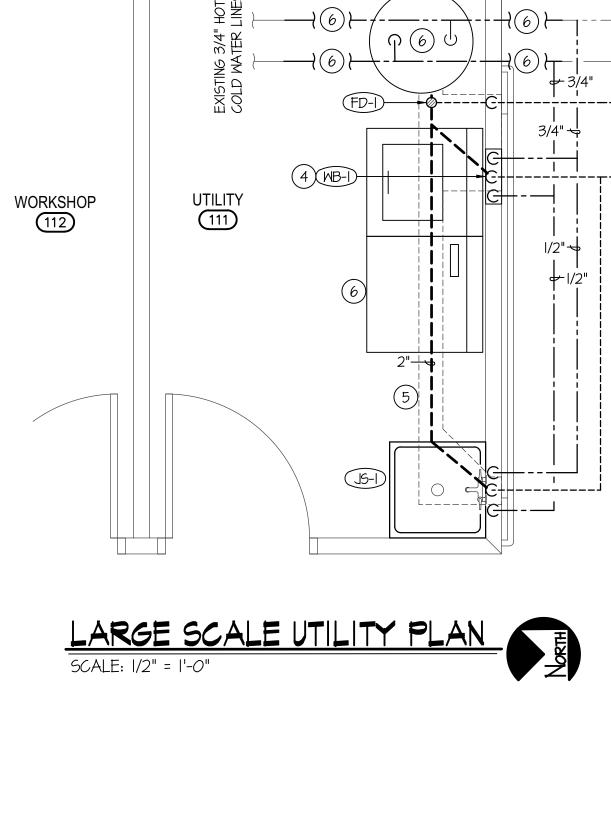

USE ONLY CONTINUOUS LENGTH TUBING (NO FITTINGS) WHEN INSTALLING PEX UNDER OR WITHIN A SLAB. PROTECT PEX TUBING WITH NONMETALLIC SLEEVES WHERE IT PENETRATES A SLAB OR FOUNDATION WALL.

MIN. CLEARANCES

TUBING SIZE	MIN. RADIUS BENDING
3/8"	4"
1/2"	5"
3/4"	7"
["	q"






TUBING AND FITTINGS SHALL BE STORED UNDERCOVER FOR CLEANLINESS AND TO AVOID EXPOSURE TO SUNLIGHT. CONSULT MANUFACTURER FOR RECOMMENDED LIMITS TO OUTSIDE STORAGE.


DO NOTE DRAG TUBING OVER ROUGH TERRAIN, ROCKS, OR ANY SURFACE THAT CAN CUT, PUNCTURE OR DAMAGE TUBING WALL.

PEX PIPE HANDLING DETAILS




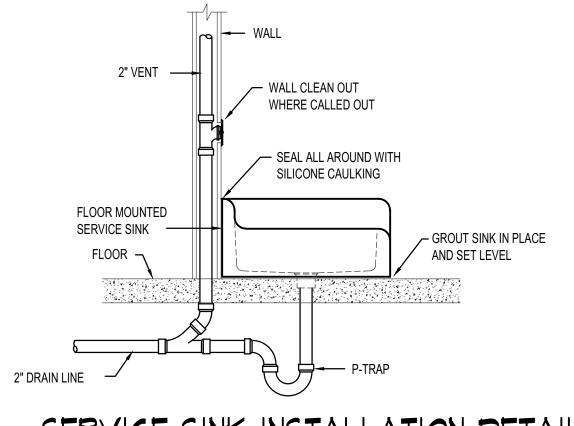

SERVICE SINK INSTALLATION DETAIL

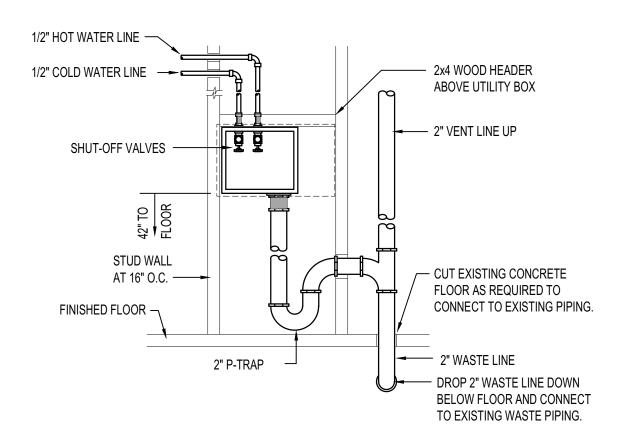

WASHER BOX PIPING DETAIL

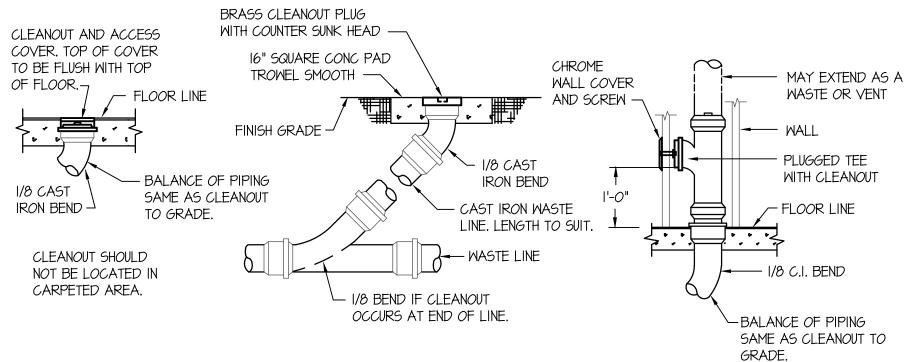


FLOOR CLEANOUT (FCO) CLEANOUT TO GRADE (COTG)

MALL CLEANOUT (MCO)


CLEAN OUT DETAILS

THIS TYPE (COLD EXPANSION) OF FITTING REQUIRES THAT THE PEX PIPING, WITH REIFORCING PEX RING PLACED OVER THE END OF THE END OF THE PIPE, IS EXPANDED BEFORE THE FITTING IS INSERTED INTO THE PIPE END. THE EXPANDED PIPE END IS ALLOWED TO RETRACT ONTO THE FITTING TO FORM THE SEAL. THE MEMORY OF THE PIPE ALLOWS IT TO TIGHTEN OVER THE FITTING. AN EXPANDER TOOL IS REQUIRED TO EXPAND THE PIPE AND THE PEX RING TOGETHER.

ALL JOINTS (TEES. ELBOWS, COUPLINGS, ETC.) ARE JOINTED SIMILARLY.

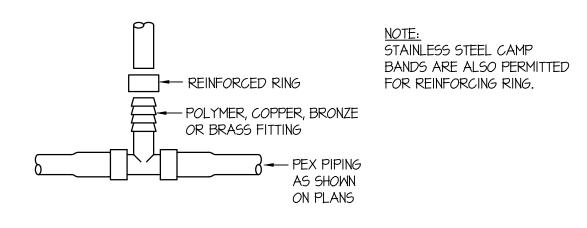


PEX PIPE FITTING DETAILS

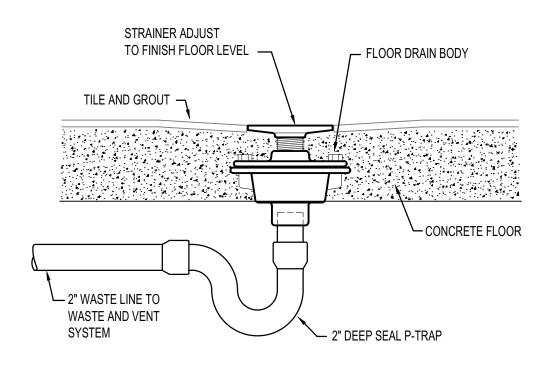


FLOOR DRAIN IN CONCRETE FLOOR

	FIXTURE SCHEDULE				
SYM.	DESCRIPTION	НОТ	COLD	WASTE	VEN
DF-I)	BI-LEVEL DRINKING FOUNTAIN - ELKAY MODEL LZSTL8WSLK WITH BOTTLE FILLER STATION & FILTER FRONT PUSH BAR OPERATORS, I/2" STOP, I-I/2" P-TRAP AND FLEX-GUARD SAFETY BUBBLER VALVE.		1/2"	I-I/2"	1-1/2
FD-I	2" FLOOR DRAIN - ZURN Z-415 WITH 5"Φ NICKEL-BRONZE STRAINER AND 2" DEEP SEAL P-TRAP.			2"	2"
<u>JS-I</u>	FLOOR MOUNTED SERVICE SINK - MUSTEE MODEL 63M (24"x24") MOP SINK WITH 63.600A FAUCET AND 2" DEEP SEAL P-TRAP AND STRAINER	1/2"	1/2"	2"	2"
<u>(5-1)</u>	SINGLE COMPARTMENT SINK - ELKAY MODEL LR-2219 WITH 18 GA TYPE 304 STAINLESS STEEL CONSTRUCTION, I-HOLE FAUCET DRILLINGS, ELKAY LKIOOOCR FAUCET, GARBAGE DISPOSAL, LK-99 STRAINER, I-I/2" P-TRAP AND I/2" BALL TYPE STOP VALVES.	1/2"	1/2"	I-I/2"	I-I/2'
(MB-I)	<u>MASH BOX</u> - OATEY POLY MASHER BOX WITH I/2" HW AND CW STOP VALVES 2" STANDPIPE WITH P-TRAP.	1/2"	1/2"	2"	2"

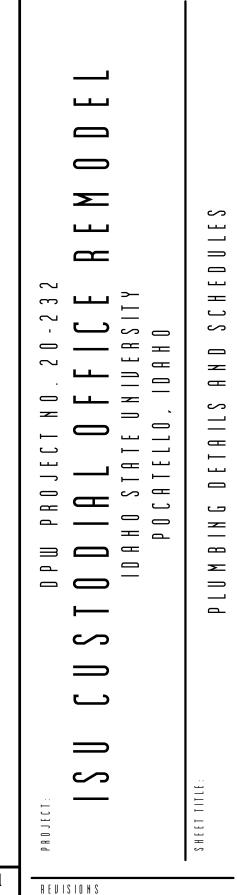

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(208) 233-0501 (208) 233-0529 ||EMAIL: esa@engsystems.com ESA JOB NUMBER: 19085

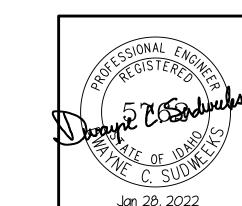
> PROJECT NO, 19085 DATE: JANUARY 2022 DRAWN BY: TDAVIS CHECKED BY: D S U D W E E K S

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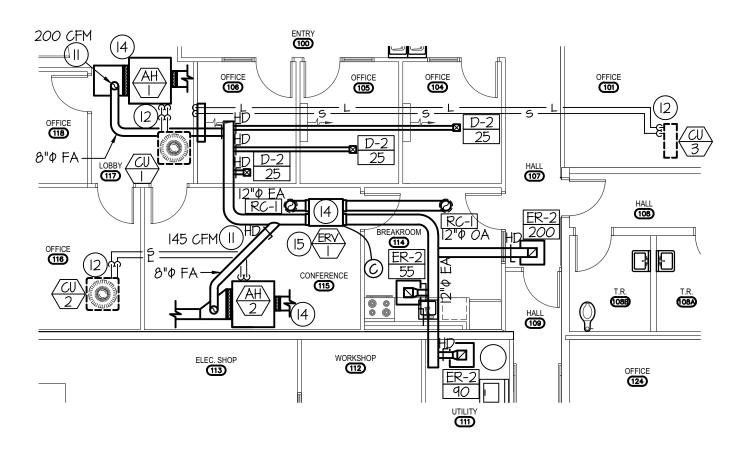
TAKEN AT THE SITE.

B- THE MECHANICAL CONTRACTOR SHALL BE
RESPONSIBLE TO INSURE PROPER CODE CLEARANCES
FOR ELECTRICAL AND MECHANICAL ACCESS WHEN

INSTALLING ANY EQUIPMENT SUPPLIED BY THE

MECHANICAL CONTRACTOR.

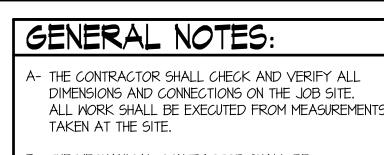- C- IT IS CRITICAL THAT THIS CONTRACTOR COORDINATE EQUIPMENT LOCATIONS WITH PIPING, DUCTWORK, ELECTRICAL CONDUIT AND BUILDING STRUCTURE TO INSURE CODE COMPLIANCE.
- D- CEILING DIFFUSERS ARE SHOWN IN APPROXIMATE LOCATIONS. REFER TO LIGHTING PLANS AND REFLECTED CEILING PLAN FOR EXACT LOCATIONS.
- E- DUCT DIMENSIONS CALLED OUT ON DRAWINGS ARE INSIDE FREE AREA DIMENSIONS. ACOUSTICAL DUCT LINER ARE TO BE ADDED TO OVERALL MEASUREMENTS.
- F- ALL DUCTWORK AND PIPING WHICH PASSES THRU FIRE RATED WALLS TO BE FIRE STOPPED WITH APPROVED FOAM OR SEALANT. REFER TO SPECIFICATIONS FOR APPROVED MANUFACTURES.



MAIN LEVEL ERY & REFRIGERATION FLOOR PLAN

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	FAN COIL SCHEDULE								
SYM.	CFM	CHAR.	FAN WATTS	MCA	WEIGHT	COOLING CAPACITY	CONDENSATE DRAIN	REMARKS	
FC 3	237	FROM CU-3 208/I	30	7	22#	12,000 BTU	3/4"	MITSUBISHI M-SERIES MSY-GLI2NA-UI	

	CONDENSING UNIT SCHEDULE												
	SYM.	BTV	EAT	CHAR.	MCOP	MCA	SEER	REFR.	PIPE :	SIZING SUCTION	REMARKS		
\langle	(U)	24,000	45°F	208/60/1	25	14.7	14.0	R-410A	3/8"	5/8"	LENNOX MODEL MLI4XCI WITH O°F LOW AMBIENT HARD START KIT.		
\langle	(U) 2	18,000	95°F	208/60/1	20	12	14.0	R-410A	3/8"	5/8"	LENNOX MODEL MLI4XCI WITH O°F LOW AMBIENT HARD START KIT.		
\langle	(U) 3	12,000	95°F	208/60/1	15	7	23	8I#	l/4"	3/8"	MITSUBISHI ELECTRIC M-SERIES MODEL MUY-GLI2NA-U2.		


	ENERGY RECOVERY UNIT														
SYM.	TYPE	CFM	MOTOR HP	WATTS	CHAR	CONTROL	REMARKS								
(ERV)	4 DUCT UNIT	425	0.6	335	208/60/1	WORKDAY TIME CLOCK	RENEWAIRE MODEL EV450IN WITH HANGING BRACKET KIT, VIBRATION ISOLATION KIT, & QTY (2) MERV & 14x20x2 FILTERS								


	AIR HANDLER (STEAM)																	
SYM.	TYPE	CFM	CHAR.	MOCP	MCA	H.P.	E.D.R.	E.A.T.	STEAM PRESS	VALVE	TRAP	WEIGHT		AM PIPING CONDENSATE		RIGERANT SUCTION		REMARKS
AH I	STEAM	800	208/60/1	20	12	1/2	90	60	5 PSI	3/4"	3/4"	90#	I-I/2"	l"	3/8"			MAGIC AIR MODEL HCAO8 STANDARD STEAM WITH DX COOLING COIL TO MATCH
AH 2	STEAM	600	208/60/1	15	6.3	1/3	75	60	5 PSI	3/4"	3/4"	90#	I-I/2"	l"	3/8"	3/4"	R-410A	MAGIC AIR MODEL HCAO6 STANDARD STEAM WITH DX COOLING COIL TO MATCH


		E	RILLE	AND	REGIS	TER S	SCHED	ULE		
SYM.	TYPE	SIZE	CFM RANGE	THROW PATTERN	CONSTR.	FINISH	BRANCH DUCT	BALANCING DAMPER	FIRE DAMPER	REMARKS
CD-I CFM	CEILING	6x6	50-125		STEEL	MHITE	6"Ф	YES	NA	PRICE MODEL SMD IN 24x24 LAY-IN CEILING
CD-2 CFM	CEILING	6x6	50-l25		STEEL	MHITE	6"Ф	YES	NA	PRICE MODEL SMD IN 24x24 LAY-IN CEILING
CD-3 CFM	CEILING	9x9	150-285		STEEL	MHITE	8"Ф-I <i>O</i> "Ф	YES	NA	PRICE MODEL SMD IN 24x24 LAY-IN CEILING
SR-I CFM	SIDWALL REGISTER	6xl4	50-125		STEEL	MHITE	6"Ф	YES	NA	PRICE MODEL 510
RG-I	RETURN GRILLE	8x8	125-150	NA	STEEL	WHITE	6"Ф-8"Ф	NA	NA	PRICE MODEL 535 IN 24x24 LAY-IN CEILING
RG-2	RETURN GRILLE	l0xl0	150-350	NA	STEEL	WHITE	8"Ф-IO"Ф	NA	NA	PRICE MODEL 535 IN 24x24 LAY-IN CEILING
RG-3	SIDEWALL RETURN	8x8	125-160	NA	STEEL	WHITE	6"Ф-8"Ф	NA	NA	PRICE MODEL 535
ER-I	CEILING	6x6	50-75	NA	STEEL	WHITE	6Ф	YES	NA	PRICE MODEL 535
ER-2	CEILING	9x9	150-250	NA	STEEL	WHITE	80	YES	NA	PRICE MODEL 535
RC-I	ROOF CAP	12"	420	NA	ALUM	ALUM	NA	NA	NA	TWIN CITY MODEL 634M WITH INSECT SCREEN

Mechanical Plan Review: APPROVED

Final approval shall be based upon HVAC inspection for adherence to the 2018 IMC, 2018 IFGC, Idaho Statute Title 54 Chapter 50, stamped approved plans and manufacturers installation instructions.

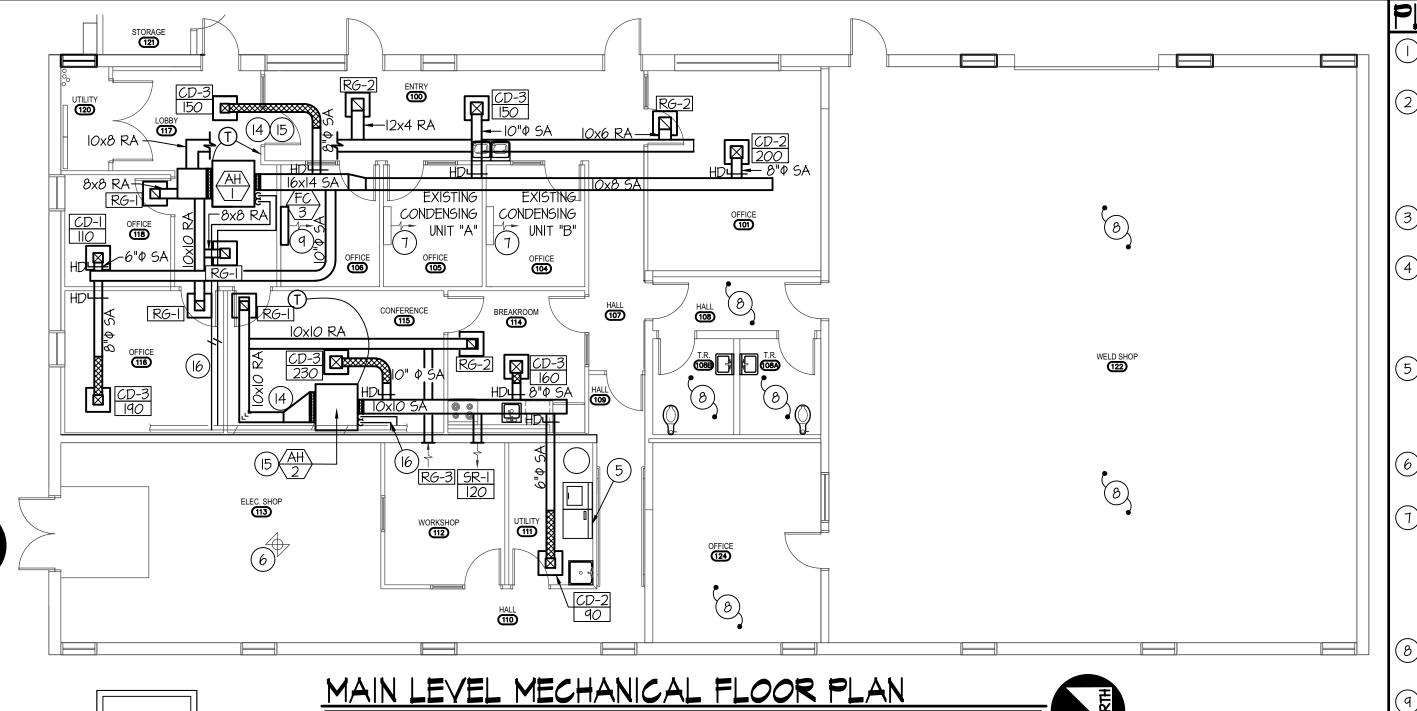

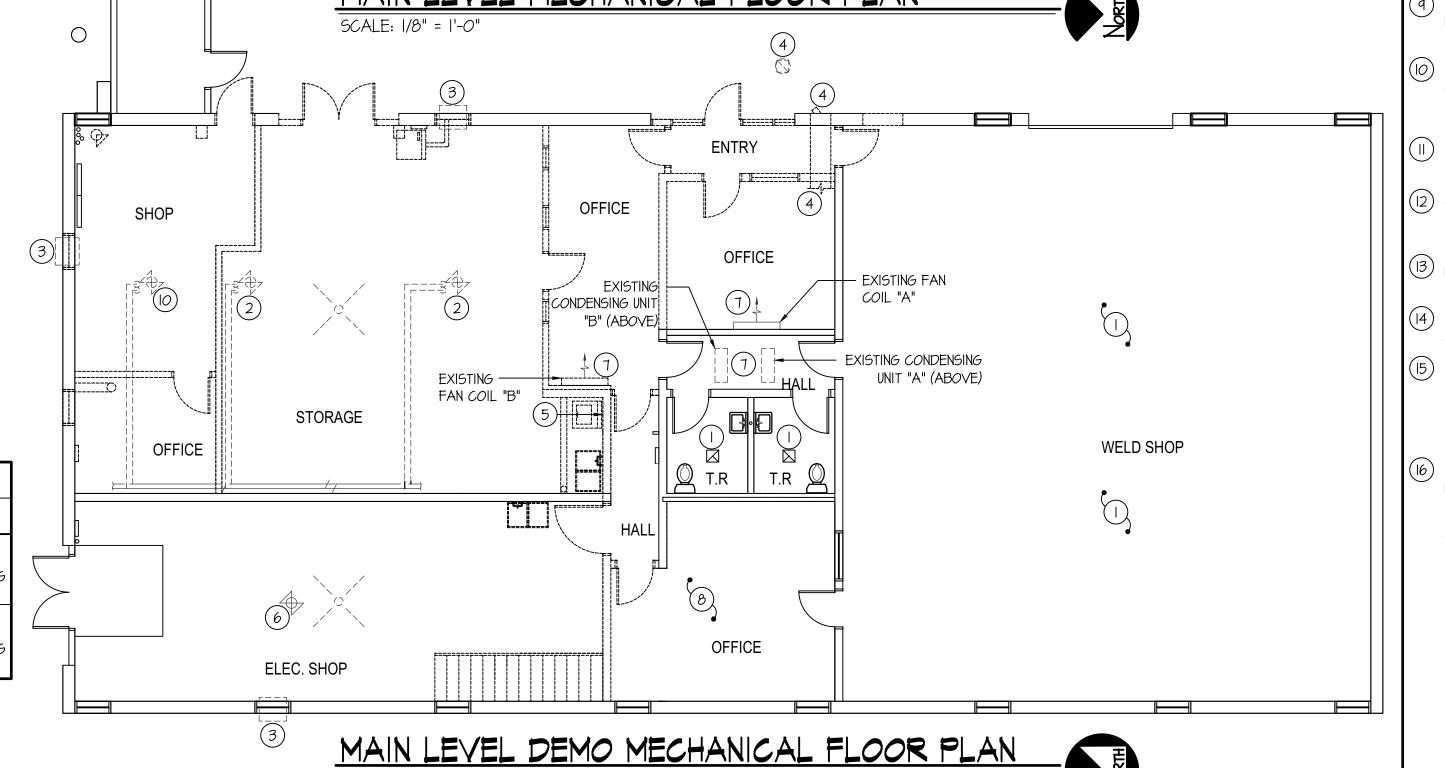

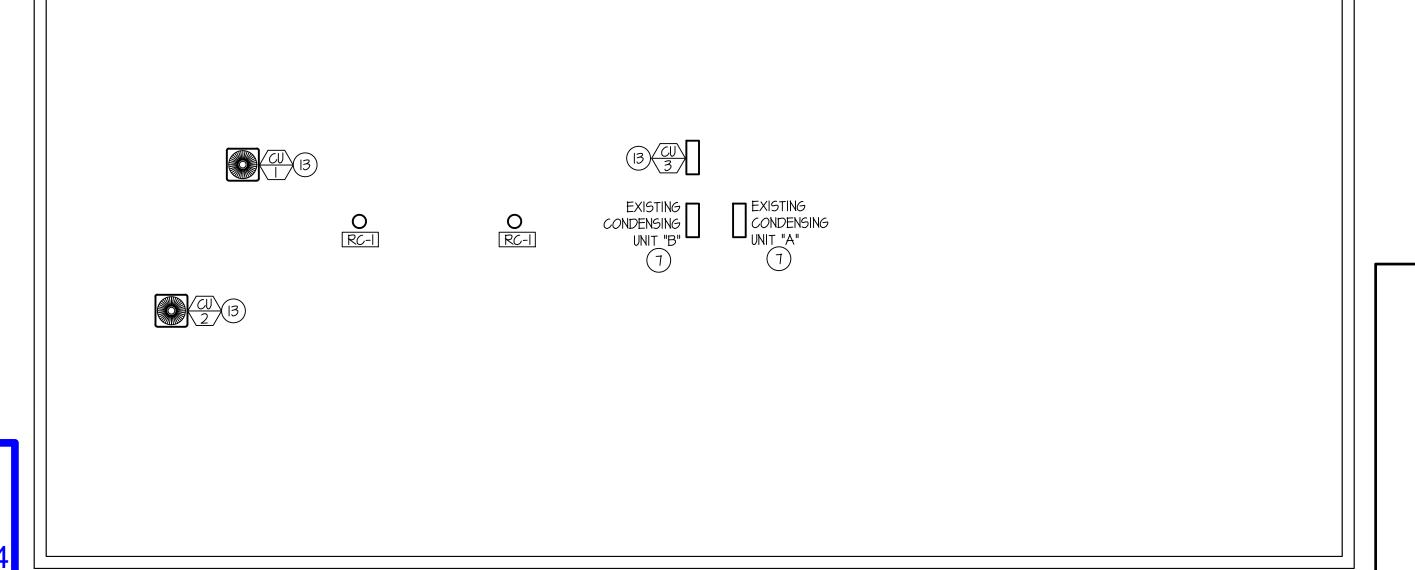

ROOF MECHANICAL PLAN

SCALE: 1/8" = 1'-0"

SCALE: 1/8" = 1'-0"

PLAN NOTES:

- EXISTING EXHAUST FAN TO REMAIN. PROTECT DURING CONSTRUCTION.
- 2 EXISTING STEAM UNIT HEATER TO BE REMOVED & REPLACED WITH NEW STEAM AIR HANDLER. ISOLATE STEAM AND CONDENSATE LINES DURING SWITCH OVER FIELD VERIFY EXACT EXISTING SHUT OFF VALVES AND REPLACE WITH NEW FOR NEW UNIT. SEE STEAM COIL PIPING DIAGRAM ON SHEET SHEET M2.I.
- 3 EXISTING WINDOW AC UNITS TO BE REMOVED AND RETURNED TO OWNER DURING CONSTRUCTION.
- REMOVE AND DISPOSE OF EXISTING DUCT, EXHAUST FAN, AND GRILLE IN THIS LOCATION. ALSO REMOVE CORRESPONDING & ABANDONED DUCTWORK IN CEILING SPACE NOT SHOWN ON PLANS. COORDINATE WITH GENERAL CONTRACTORS FOR PATCHING.

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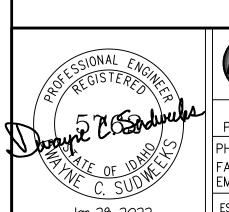
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- REMOVE EXISTING 4" DRYER DUCT IN THIS LOCATION AND BACK TO ROOF CAP FOR NEW DRYER LOCATION. INSTALL NEW DYER DUCTWORK FOR NEW DRYER LOCATION. SEE DYER DUCT CONNECTION ON SHEET M2.1
- 6 EXISTING STEAM UNIT HEATER TO REMAIN. PROTECT DURING CONSTRUCTION.
- EXISTING MINI SPLIT FAN COIL TO BE REMOVED AND RELOCATED. SEE THIS SHEET FOR NEW LOCATION. REMOVE AND RE-INSTALL CONDENSING UNITS ON ROOF FOR NEW ROOFING. FIELD VERIFY EXACT LOCATION OF EXISTING CONDENSING UNIT. REPLACE CONDENSING UNIT'S MOUNTING HARDWARE. SEE MINI-SPLIT DETAILS ON SHEET M2.I FOR RE-INSTALL.
- (8) NO WORK TO BE DONE IN THIS ROOM. PROTECT DURING CONSTRUCTION.
- 9 NEW MINI SPLIT FAN COIL / CONDENSING UNIT TO BE INSTALLED IN THIS LOCATION. SEE TYPICAL INSTALL DETAIL ON SHEET M2.I.
- (IO) EXISTING STEAM UNIT HEATER AND PNEUMATIC CONTROLS TO BE REMOVED AND DISPOSED OF. REMOVE STEAM & CONDENSATE PIPING BACK TO MAINS & CAP.
- BALANCE HAND DAMPER TO CFM AS INIDCATED ON PLANS.
- 12) SEE ROOF PENETRATION & REFRIGERATION SUPPORT DETAILS ON SHEET M2.I. RUN REFRIGERATION LINES AS MUCH AS POSSIBLE IN CEILING SPACE.
- (13) INSTALL OR RE-INSTALL NEW CONDENSING UNITS 10' AWAY FROM EDGE OF BUILDING.
- TIE ALL NEW AIR HANDLERS AND ERV UNITS TO CAMPUS DDC SYSTEM. SEE SPECIFICATION.
- 15) NEW EQUIPMENT TO BE INSTALLED IN CEILING SPACE ABOVE. DUCTWORK TO BE RUN IN CEILING SPACE AS MUCH AS POSSIBLE. RUN 3/4" CONDENSATE DRAINS TO EXISTING MEZZANINE FLOOR DRAIN AND ROUTE AROUND FOOT TRAFFIC.
- (16) RUN NEW STEAM LINES TO NEW STEAM AIR HANDLERS
 IN MEZZANINE SPACE. SEE REQUIRED MIN STEAM LINES
 TO NEW EQUIPMENT ON THE SCHEDULES. SEE SUPPORT
 AND CONNECTION DETAILS FOR NEW STEAM LINES ON
 SHEET M2.I.



Engineered
Systems
Associates

1355 EAST CENTER

POCATELLO, IDAHO 83201
PHONE: (208) 233-0501
FAX: (208) 233-0529
EMAIL: esa@engsystems.com
ESA JOB NUMBER: 19085

PROJECT NO. 19085 DATE: JANUARY 2022 DRAWN BY: TDAUIS CHECKED BY:

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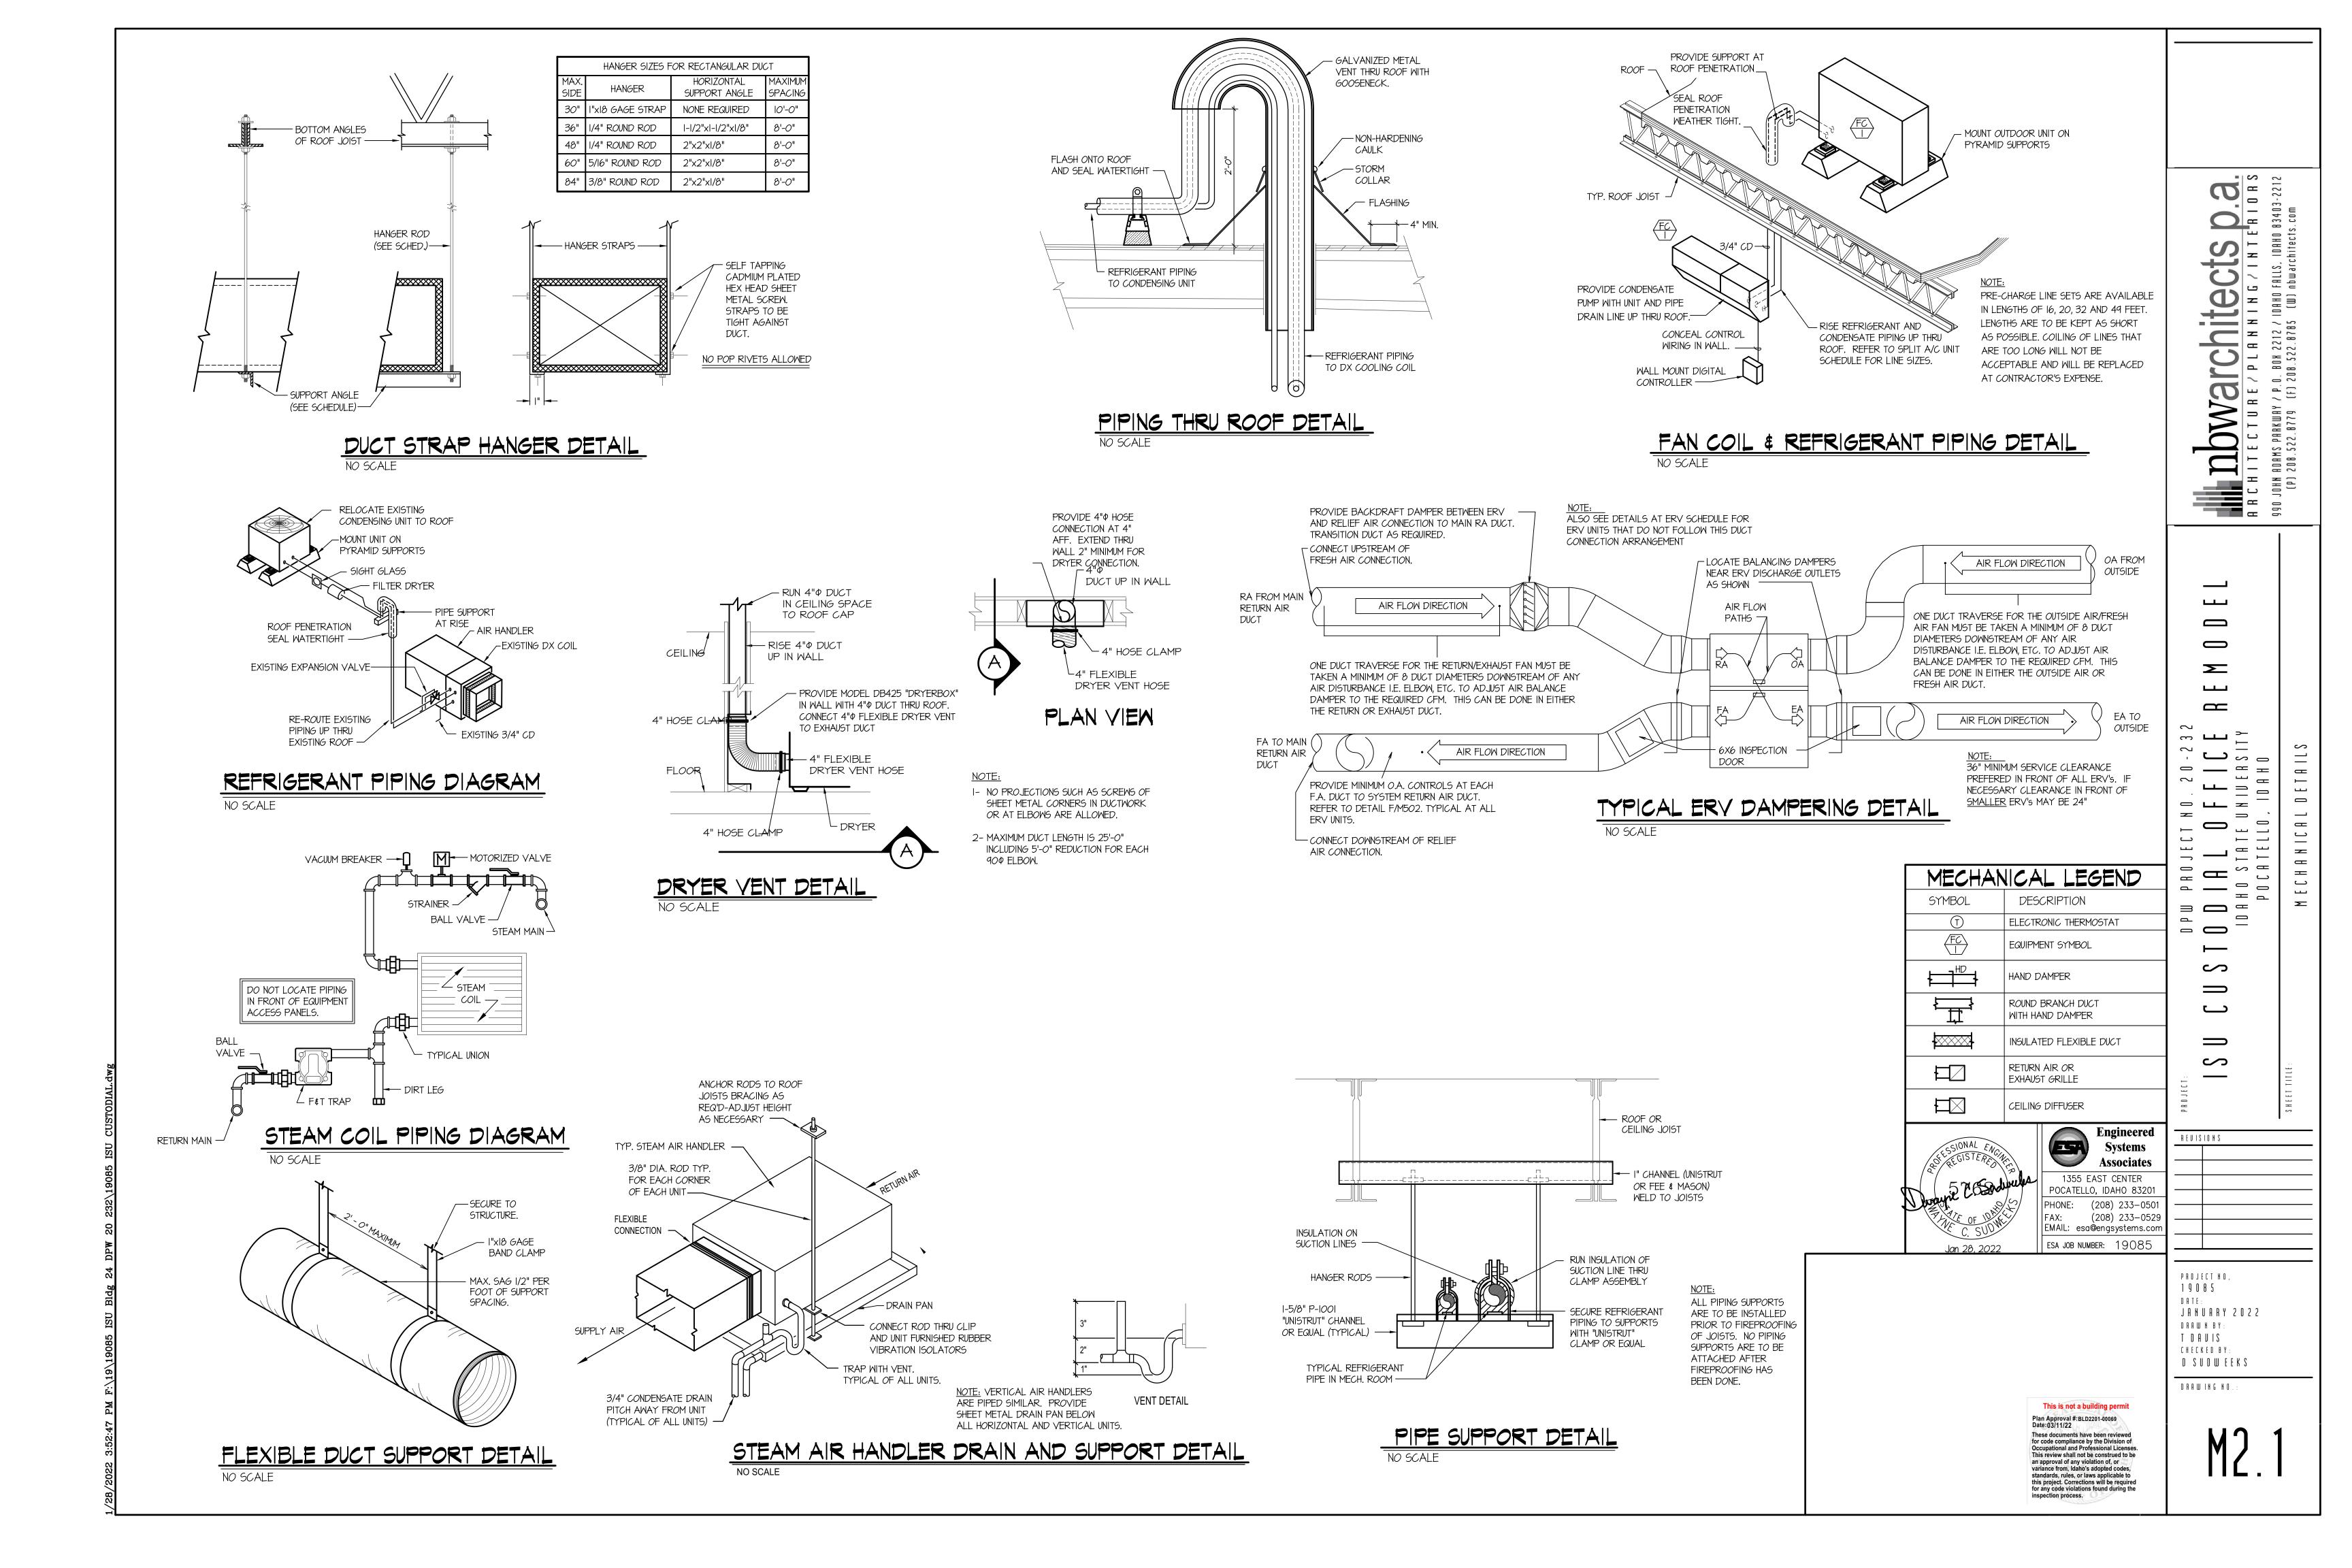
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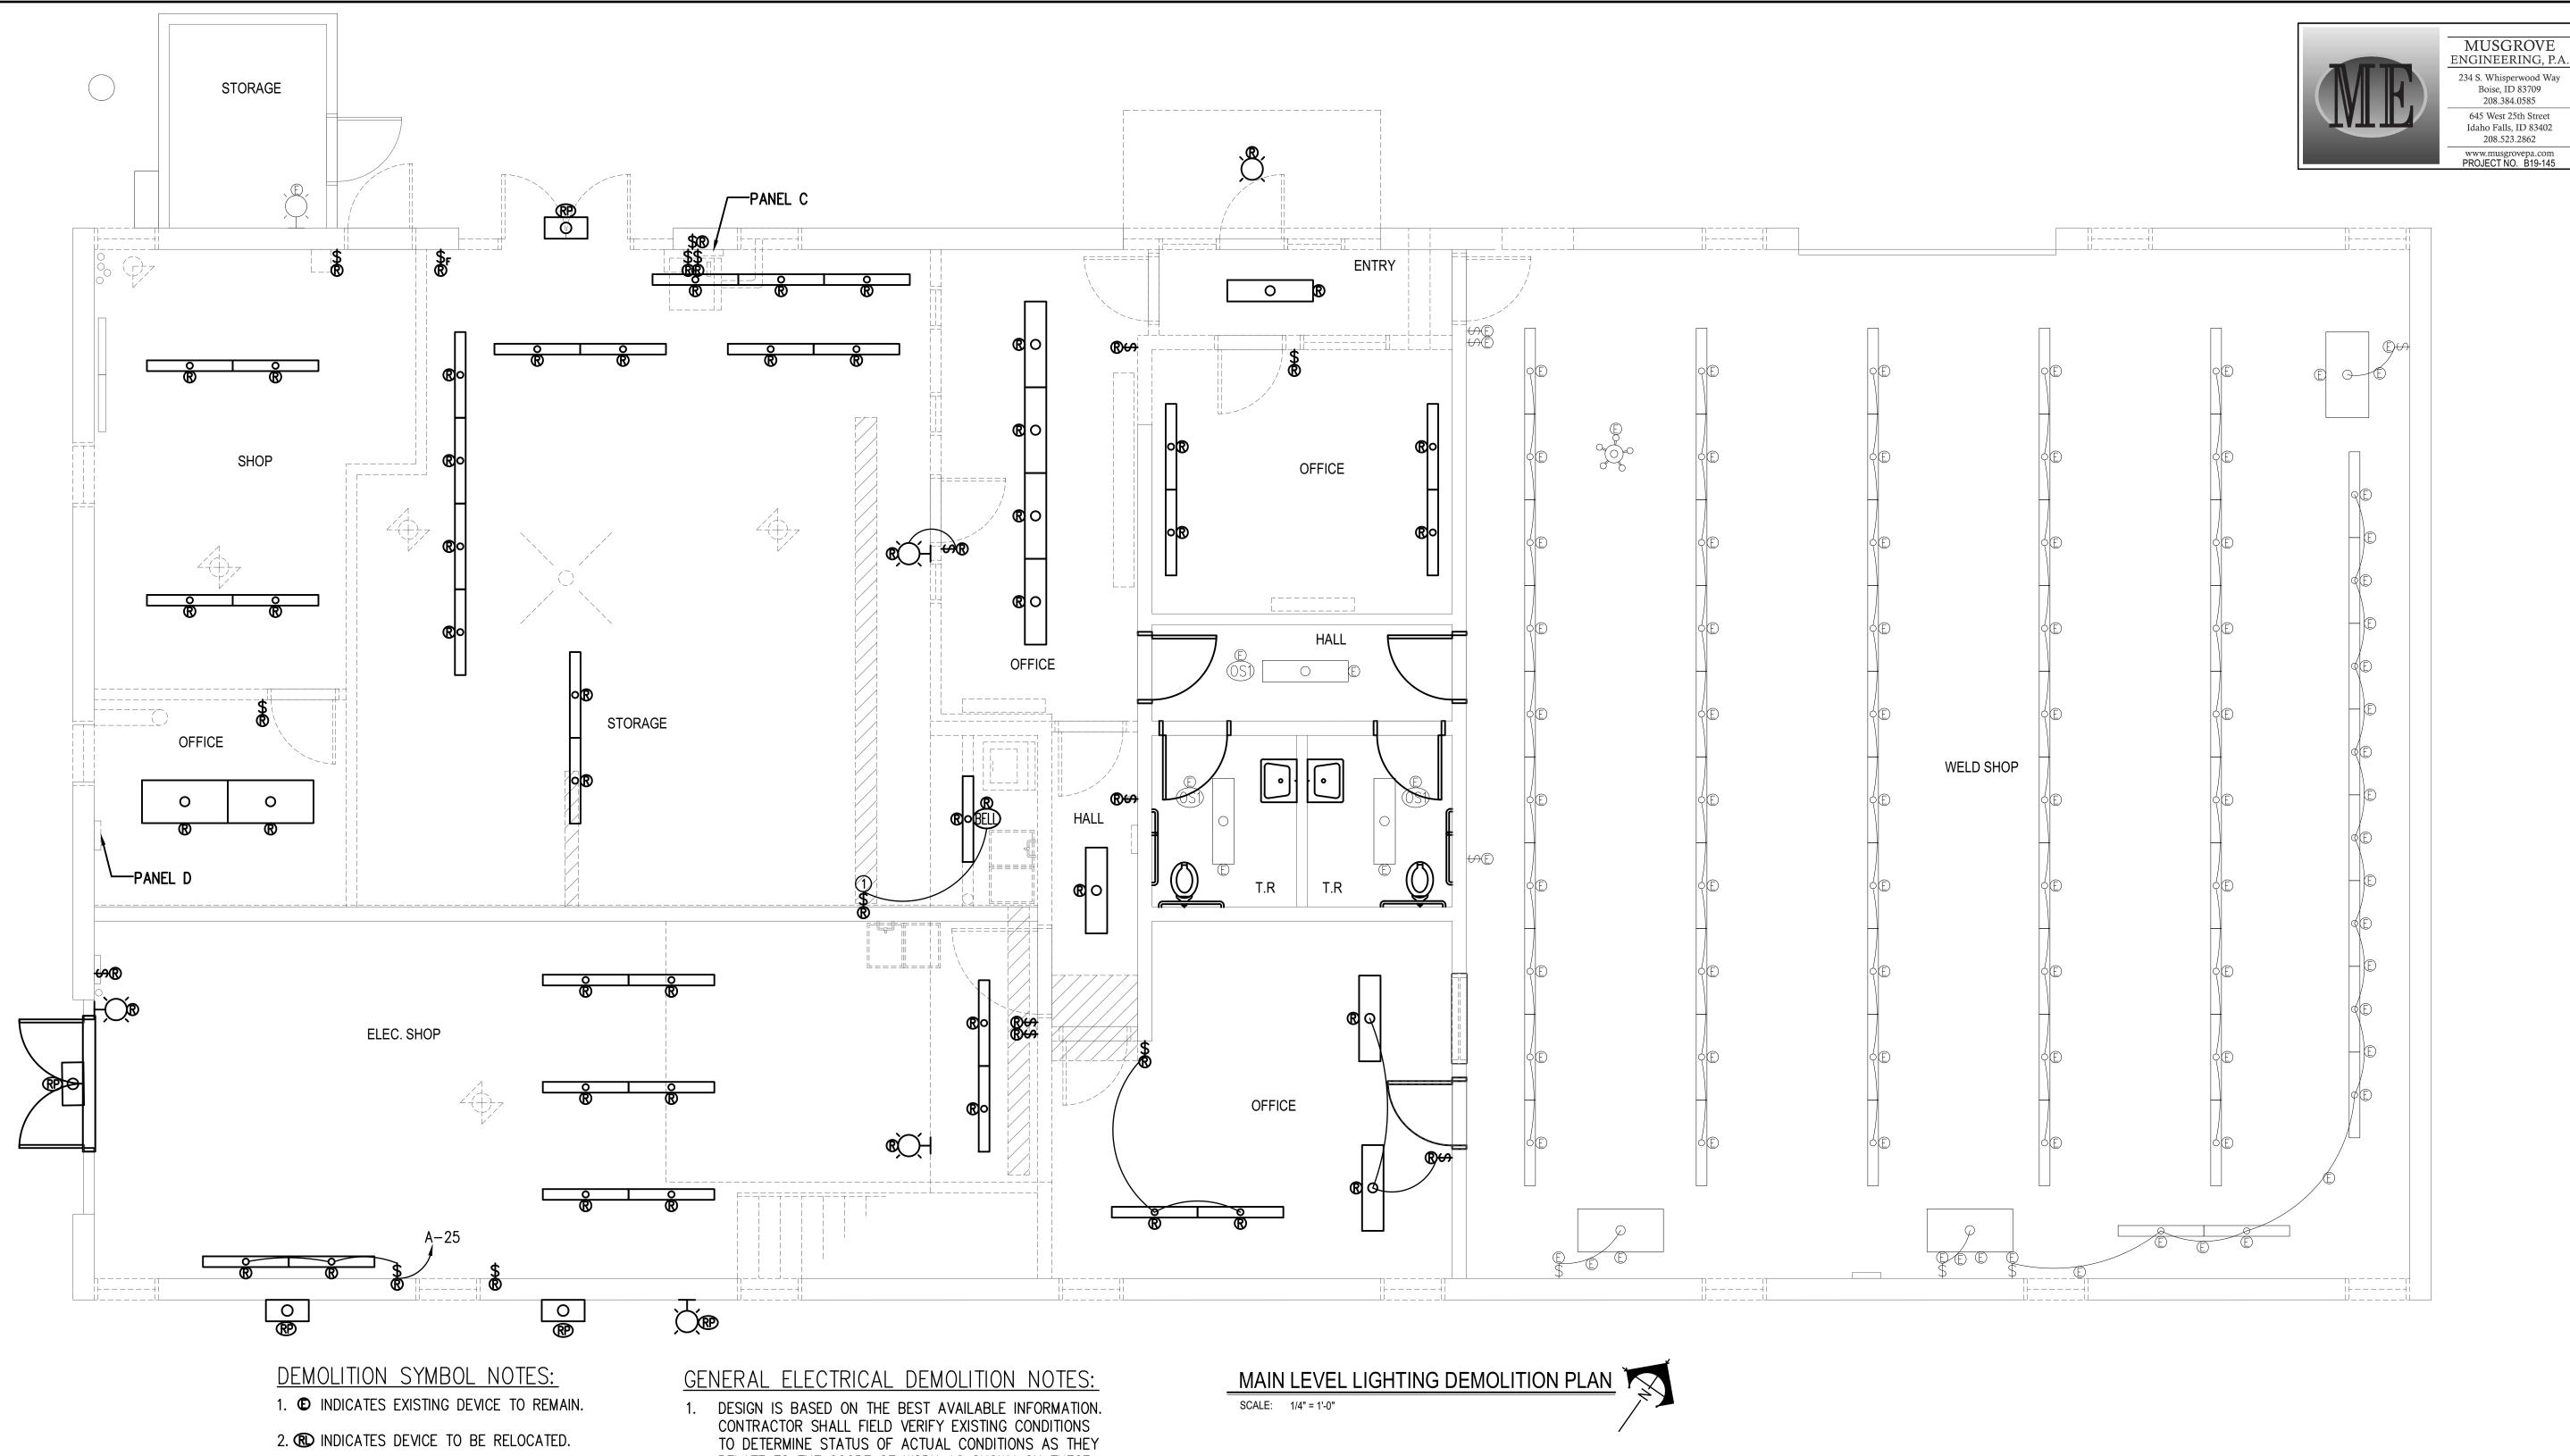
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Date:03/11/22

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M1.1





- 3. RP INDICATES FIXTURE DEVICE TO BE REPLACED IN PLACE. CIRCUITING AND CONDUIT TO REMAIN INTACT. PROTECT DURING CONSTRUCTION.
- 4. R INDICATES ITEMS TO BE REMOVED.

<u>REMOVE</u> DEVICE AND ALL CONDUCTORS PERTAINING TO THE DEVICE. THE ELECTRICAL CONTRACTOR SHALL REMOVE AND DISPOSE OF EQUIPMENT AND PROVIDE COVER PLATES AS REQUIRED.

DEMOLITION KEY NOTES:

① REMOVE SWITCH AND BELL.

- RELATE TO THE SCOPE OF WORK AS SHOWN ON THESE PLANS. LACK OF CONTRACTOR VERIFICATION WILL NOT CONSTITUTE REQUEST FOR CHANGE ORDERS.
- 2. ELECTRICAL CONTRACTOR TO MAINTAIN POWER TO ALL DOWN STREAM DEVICES AND CIRCUITS THAT ARE TO REMAIN DURING COMPLETION OF THE WORK INDICATED ON THESE PLANS.
- 3. ELECTRICAL CONTRACTOR TO COORDINATE ALL WORK WITH RELATED TRADES.
- 4. ELECTRICAL CONTRACTOR SHALL PROVIDE NEW TYPE WRITTEN UPDATED PANEL SCHEDULES FOR ALL PANELS.
- 5. ELECTRICAL CONTRACTOR TO DISPOSE OF ALL REMOVED ELECTRICAL DEVICES AND ALL RELATED ELECTRICAL PARTS BACK TO SOURCE UNLESS NOTED OTHERWISE.
- 6. ELECTRICAL CONTRACTOR HAS THE OPTION TO REUSE EXISTING RACEWAY OR PROVIDE NEW.
- 7. ELECTRICAL CONTRACTOR SHALL VERIFY EXISTING CIRCUITING PRIOR TO ANY WORK.
- 8. REFER TO ANY SPECIFICATIONS PROVIDED FOR MATERIALS AND INSTALLATION INSTRUCTIONS.

208.523.2862

REMODE DPW PROJECT NO. 20-232

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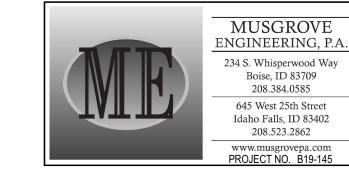
JANUARY 2022 DRAWN BY: CCJ CHECKED BY: MNB


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19032 DATE: JANUARY 2022 DRAWN BY: CCJ CHECKED BY:


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DEMOLITION SYMBOL NOTES:

- 1. D INDICATES EXISTING DEVICE TO REMAIN.
- 2. RD INDICATES DEVICE TO BE RELOCATED.
- 3. RP INDICATES FIXTURE DEVICE TO BE REPLACED IN PLACE. CIRCUITING AND CONDUIT TO REMAIN INTACT. PROTECT DURING CONSTRUCTION.
- 4. R INDICATES ITEMS TO BE REMOVED.


REMOVE DEVICE AND ALL CONDUCTORS PERTAINING TO THE DEVICE. THE ELECTRICAL CONTRACTOR SHALL REMOVE AND DISPOSE OF EQUIPMENT AND PROVIDE COVER PLATES AS REQUIRED.

GENERAL ELECTRICAL DEMOLITION NOTES:

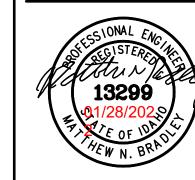- 1. DESIGN IS BASED ON THE BEST AVAILABLE INFORMATION. CONTRACTOR SHALL FIELD VERIFY EXISTING CONDITIONS TO DETERMINE STATUS OF ACTUAL CONDITIONS AS THEY RELATE TO THE SCOPE OF WORK AS SHOWN ON THESE PLANS. LACK OF CONTRACTOR VERIFICATION WILL NOT CONSTITUTE REQUEST FOR CHANGE ORDERS.
- 2. ELECTRICAL CONTRACTOR TO MAINTAIN POWER TO ALL DOWN STREAM DEVICES AND CIRCUITS THAT ARE TO REMAIN DURING COMPLETION OF THE WORK INDICATED ON THESE PLANS.
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MEZZANINE LEVEL LIGHTING DEMOLITION PLAN

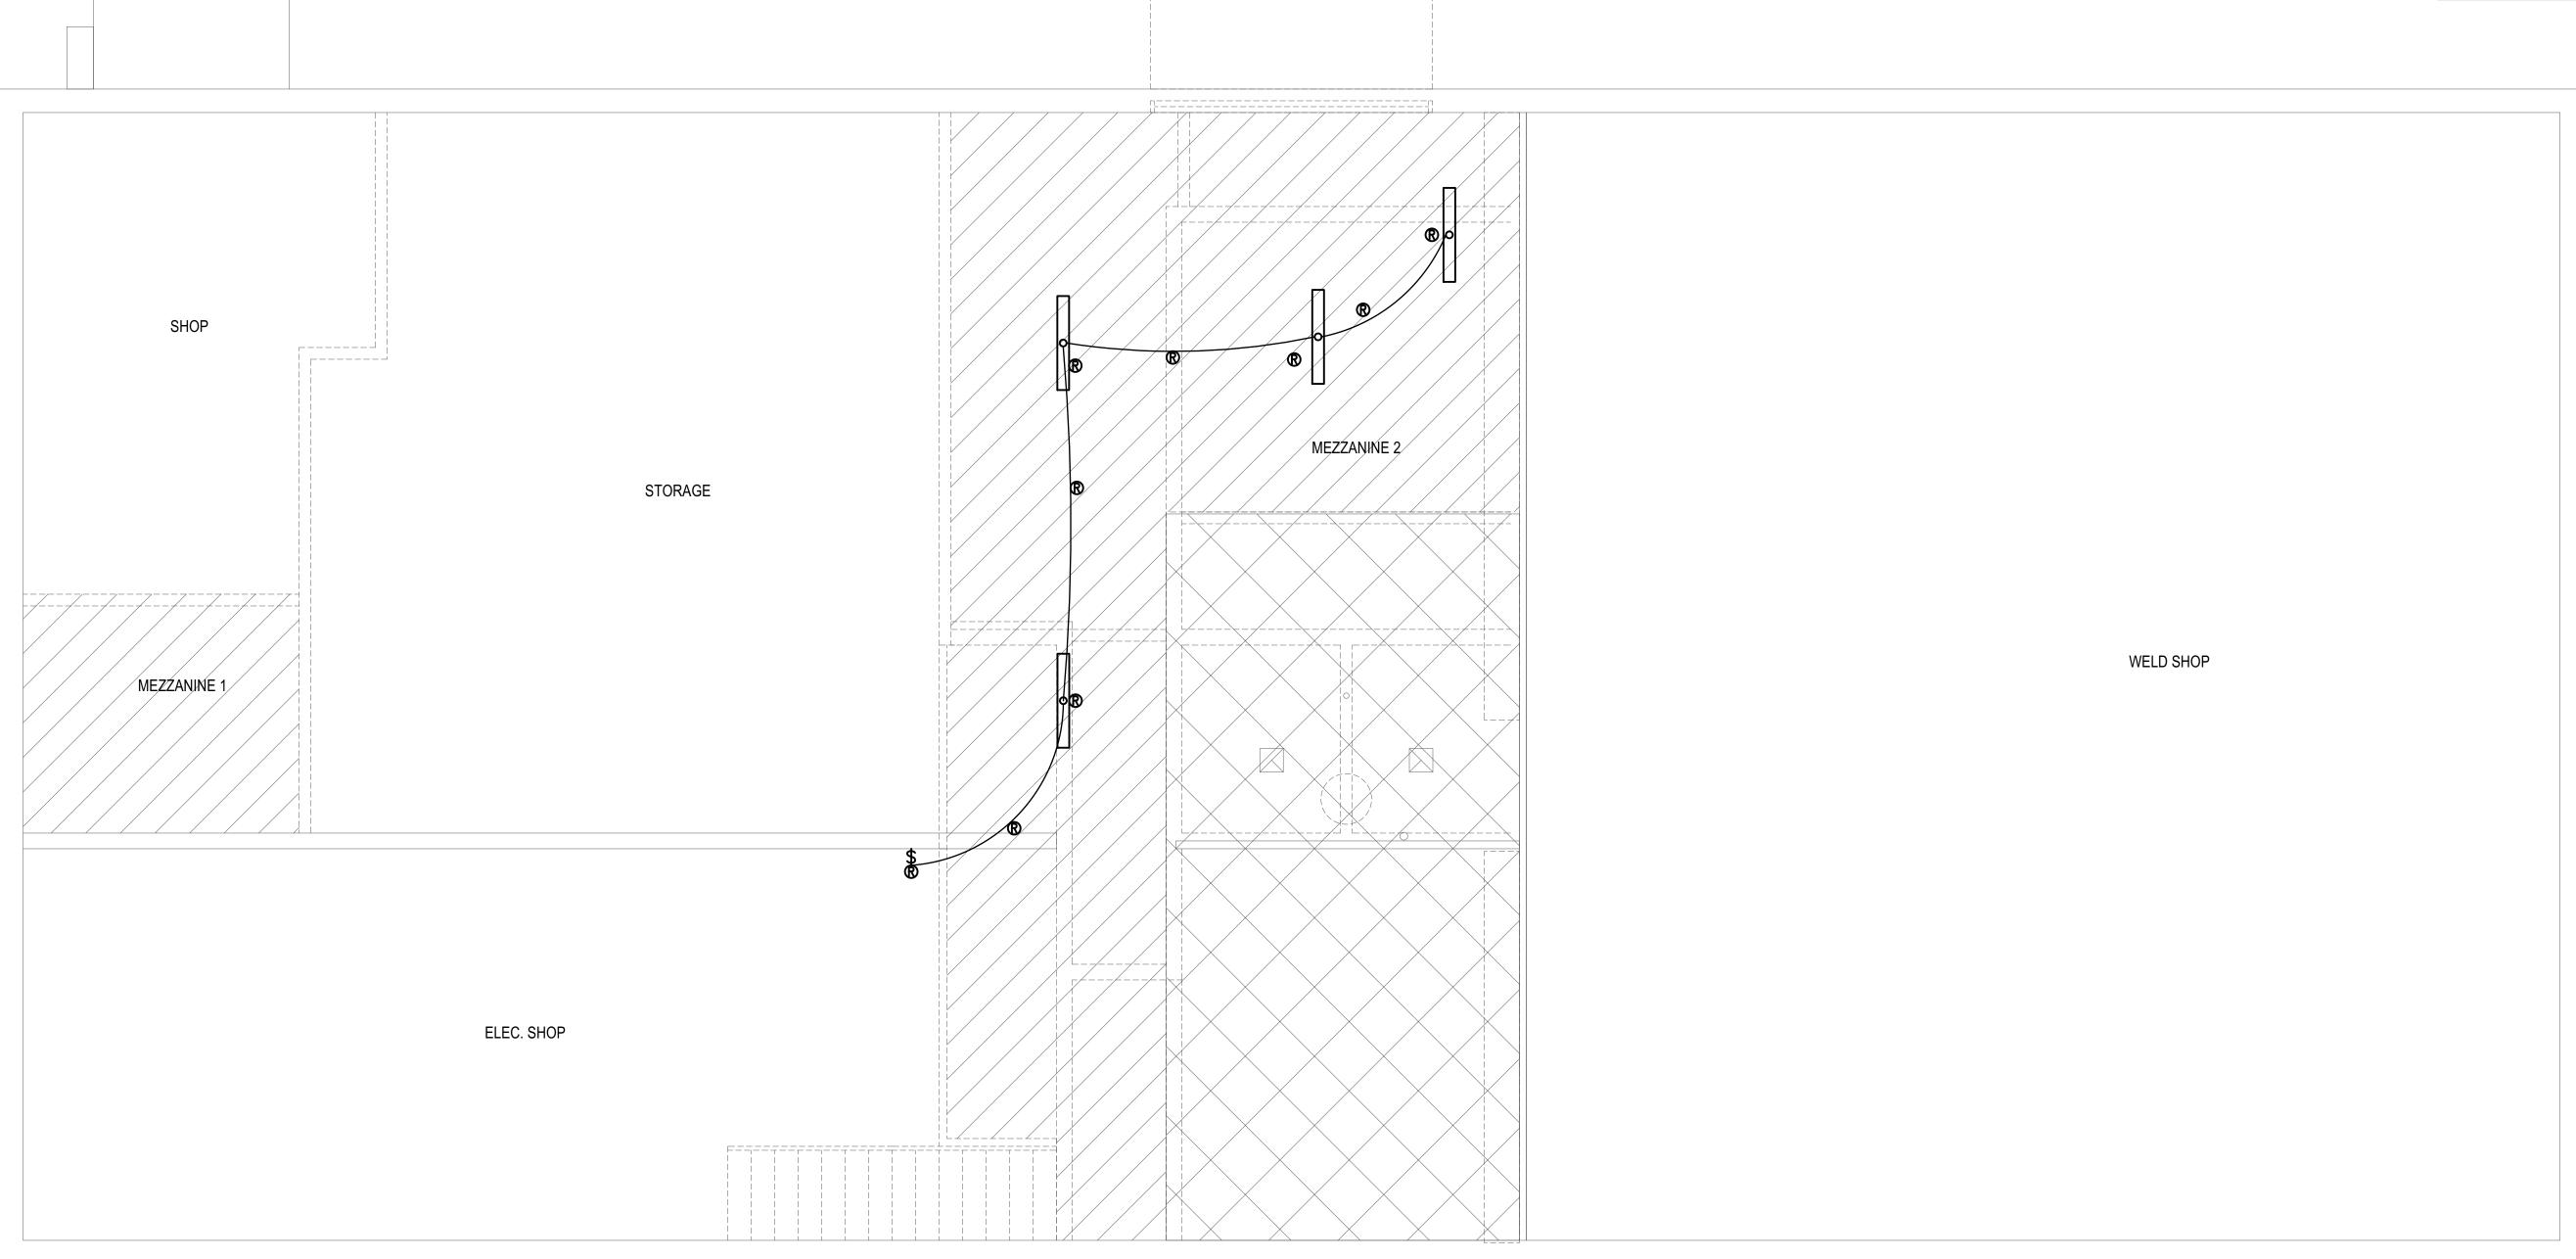SCALE: 1/4" = 1'-0"

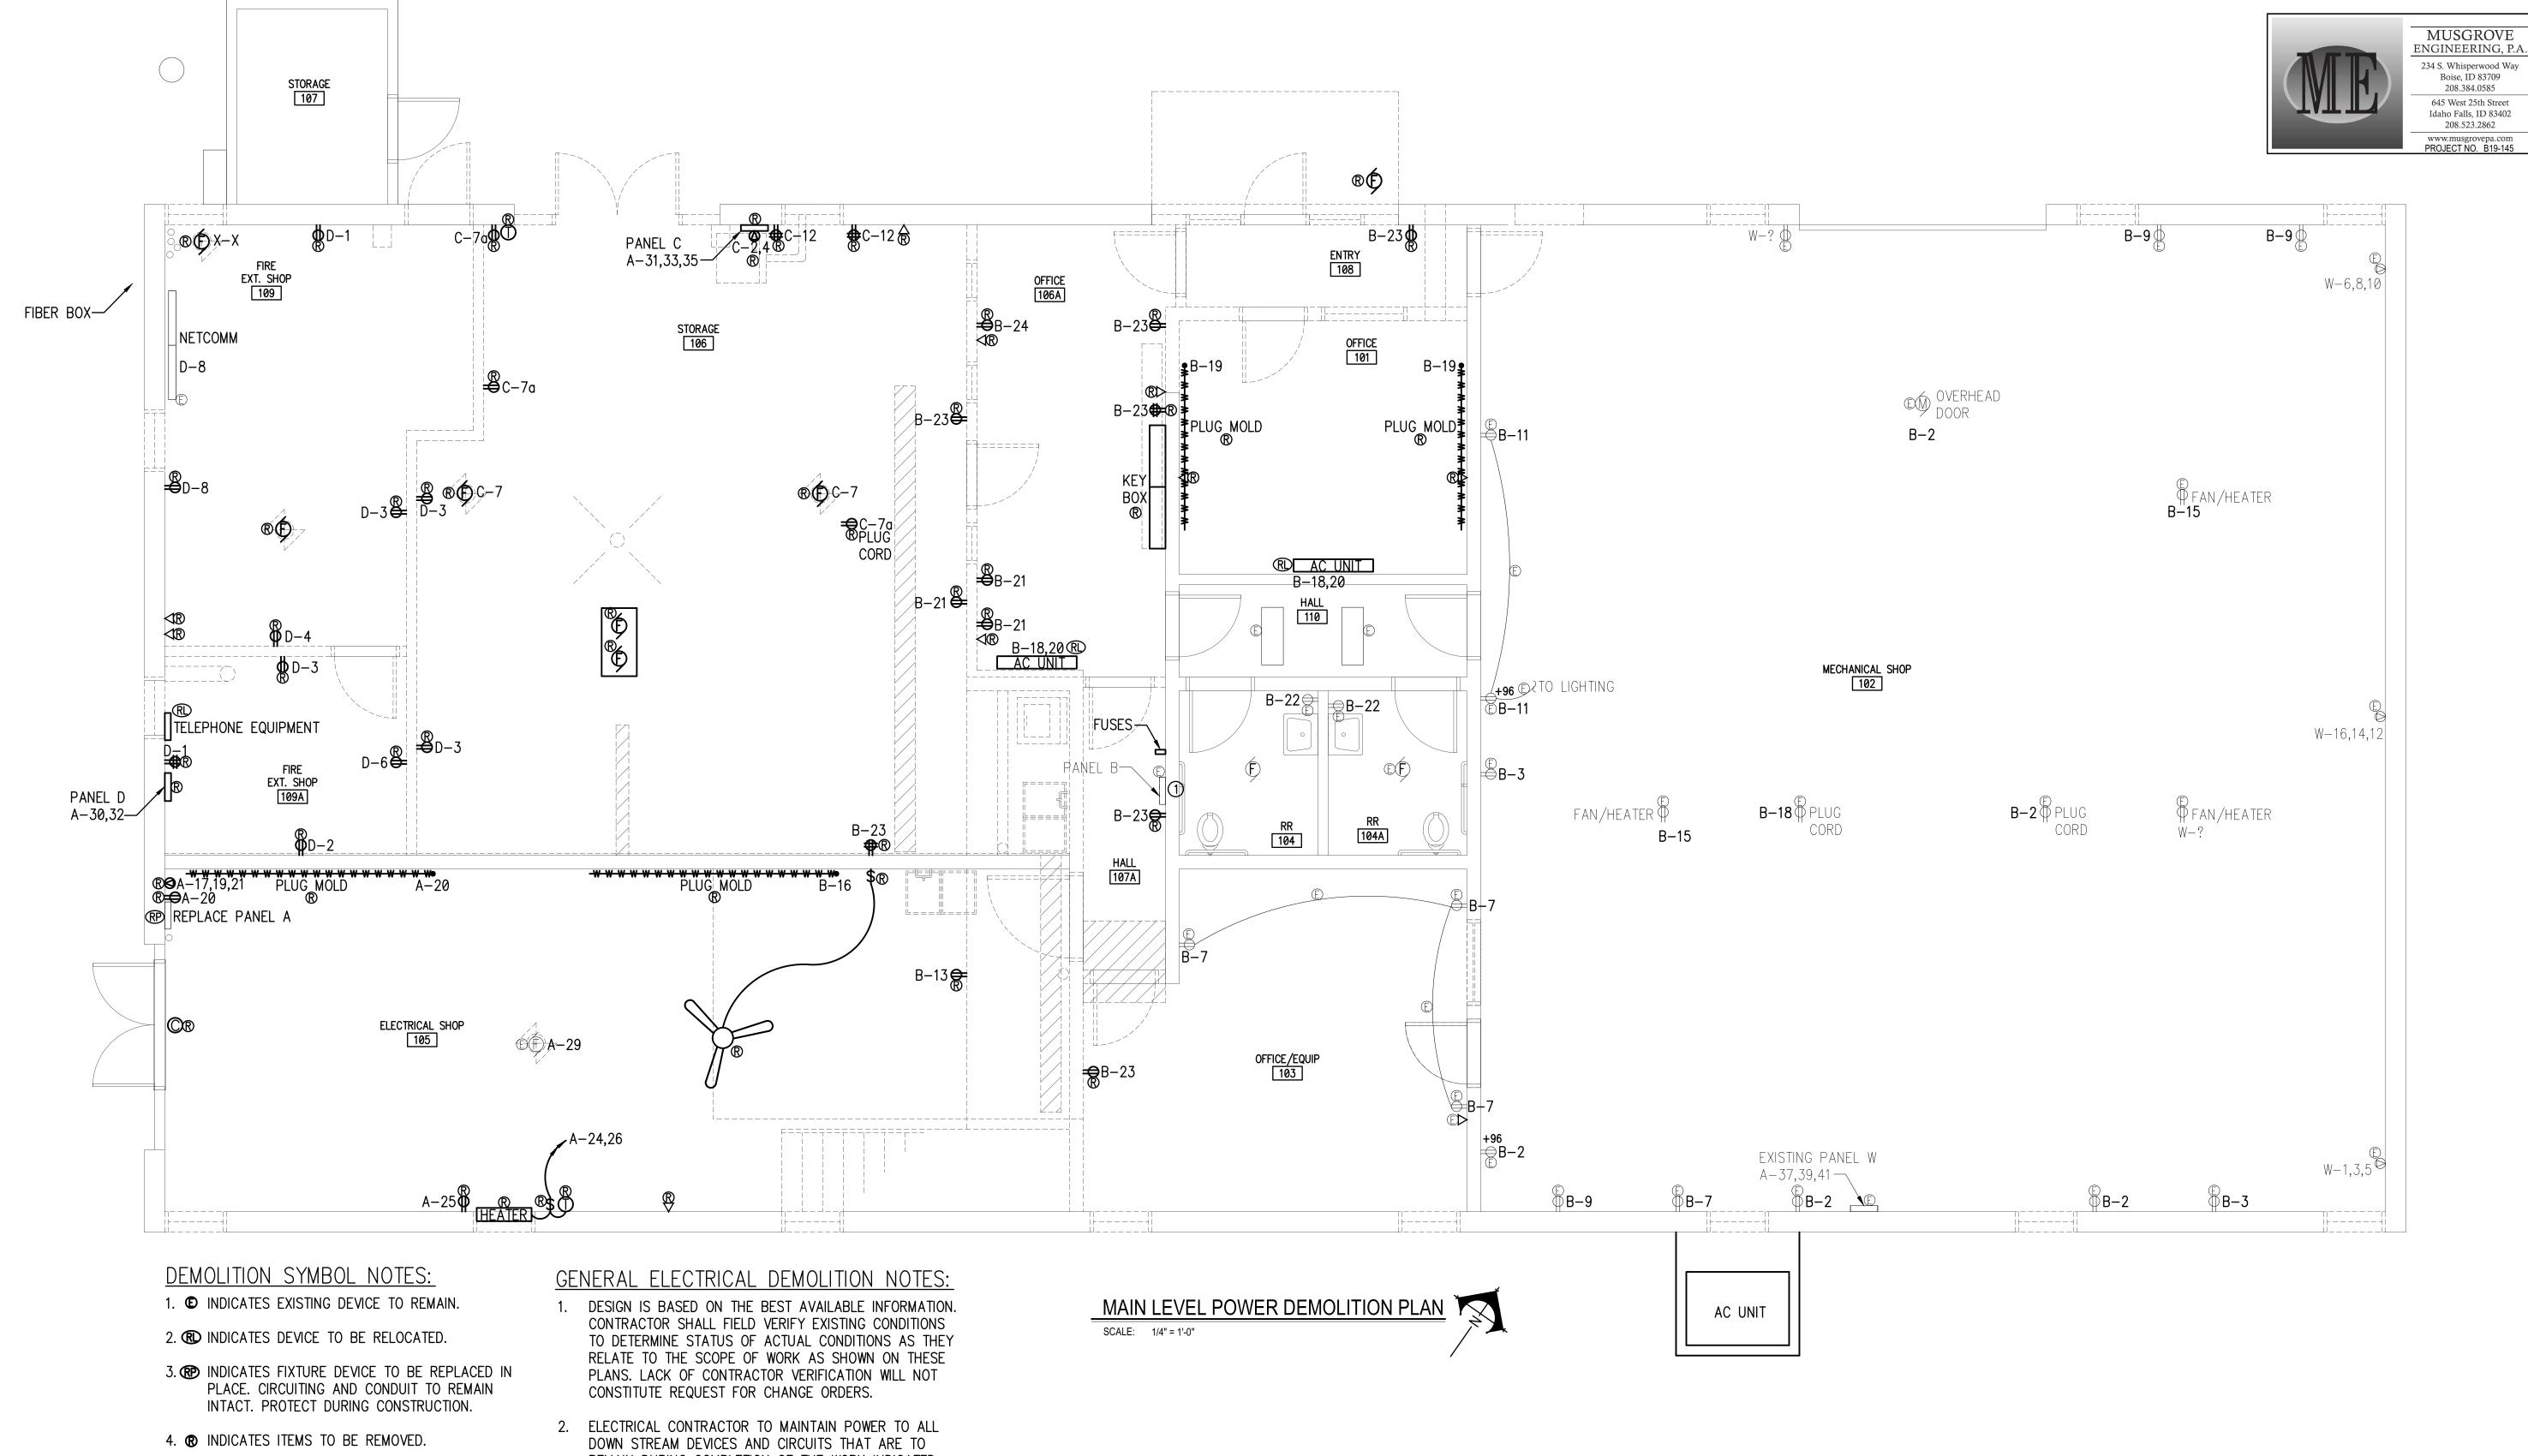

13299

Boise, ID 83709 208.384.0585

208.523.2862

DPW PROJECT NO. 20-232

TODIAL OFFICE REMODEL
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- REMAIN DURING COMPLETION OF THE WORK INDICATED ON THESE PLANS.
- ELECTRICAL CONTRACTOR TO COORDINATE ALL WORK WITH RELATED TRADES.

REMOVE DEVICE AND ALL CONDUCTORS PERTAINING TO

THE DEVICE. THE ELECTRICAL CONTRACTOR SHALL REMOVE AND DISPOSE OF EQUIPMENT AND PROVIDE

1) EXISTING PANEL B TO BE REMOVED. VERIFY ALL

SEE MAIN LEVEL POWER INSTALLATION PLAN

CIRCUITS PRIOR TO WORK. CONDUIT AND WIRING


TO EXISTING DEVICES IN WELD SHOP CONNECTED

TO EXISTING PANEL B ARE TO REMAIN FOR REUSE.

COVER PLATES AS REQUIRED.

DEMOLITION KEY NOTES:

- 4. ELECTRICAL CONTRACTOR SHALL PROVIDE NEW TYPE WRITTEN UPDATED PANEL SCHEDULES FOR ALL PANELS.
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VER DEMOLITION PLAN

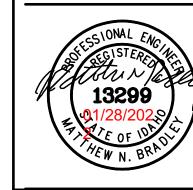SHOP MEZZANINE 2 STORAGE WELD SHOP MEZŹANINE 1 ELEC. SHOP

DEMOLITION SYMBOL NOTES:

- 1. © INDICATES EXISTING DEVICE TO REMAIN.
- 2. (R) INDICATES DEVICE TO BE RELOCATED.
- 3. P INDICATES FIXTURE DEVICE TO BE REPLACED IN PLACE. CIRCUITING AND CONDUIT TO REMAIN INTACT. PROTECT DURING CONSTRUCTION.
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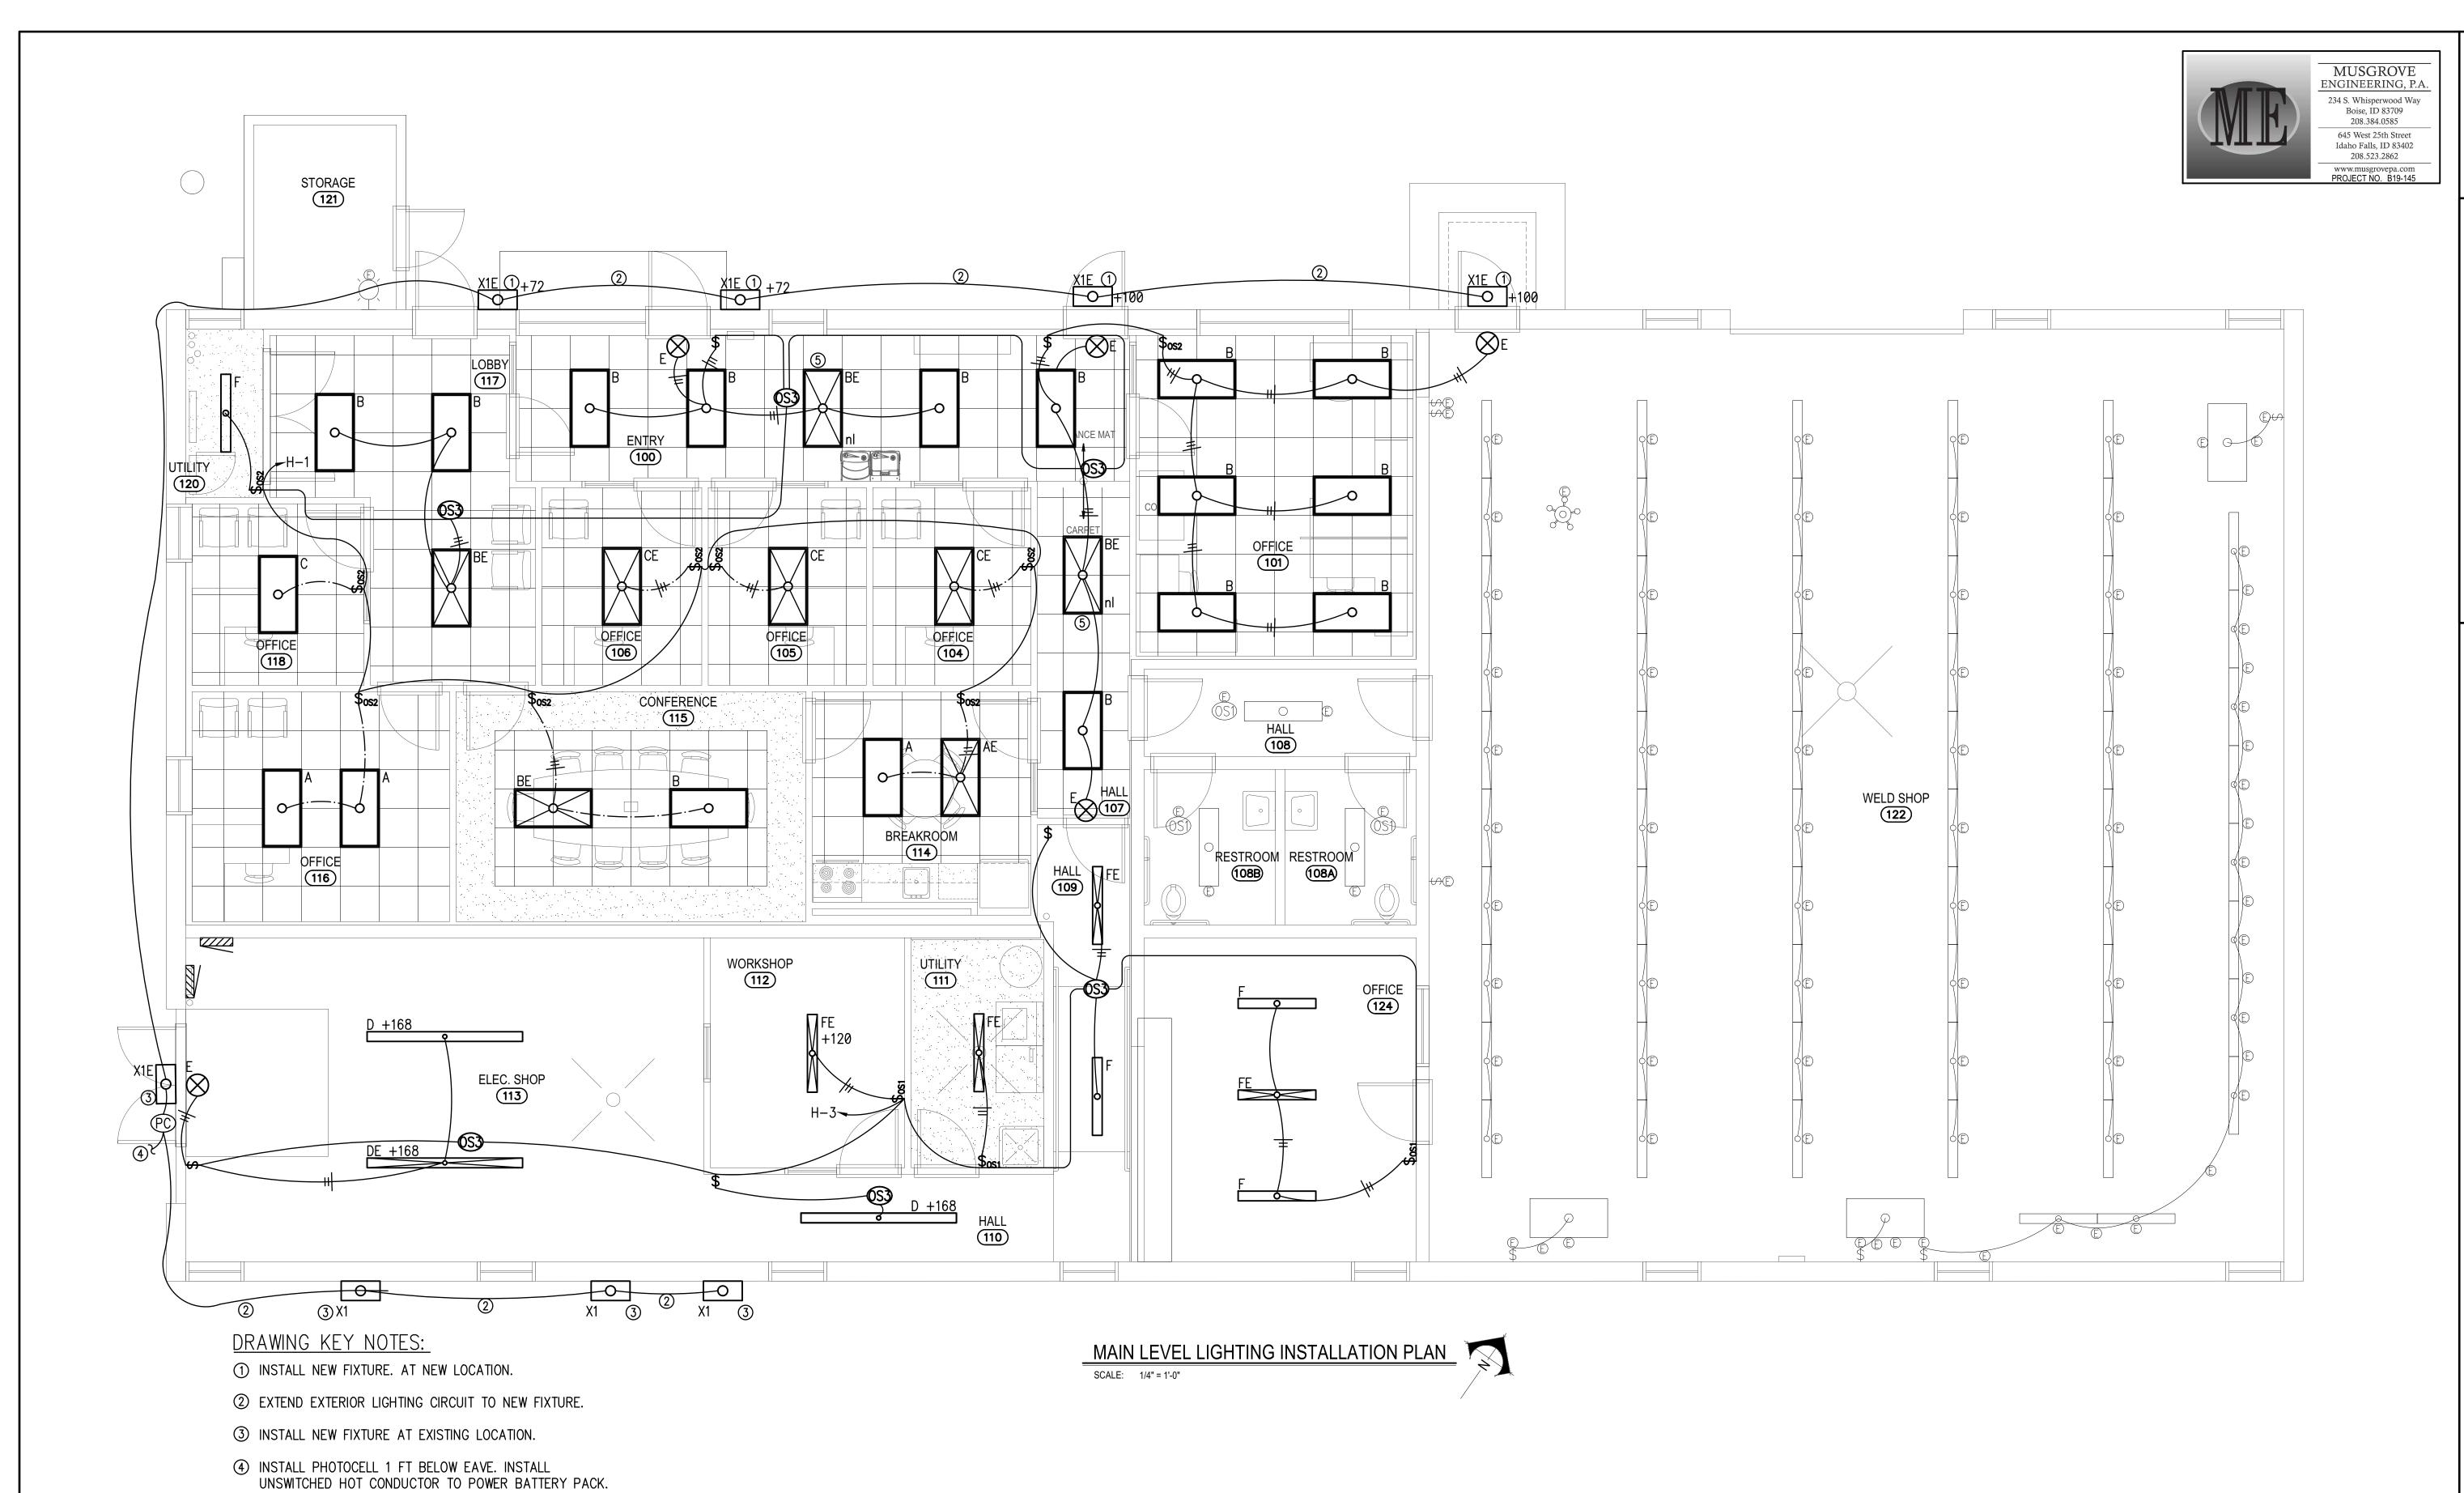
MEZZANINE LEVEL POWER DEMOLITION PLAN

SCALE: 1/4" = 1'-0"



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IDAHO STATE UNIVERSITY
POCATELLO, IDAHO

CNS.

ISU REVISIONS

PROJECT NO.: 19032 JANUARY 2022 DRAWN BY: CCJ CHECKED BY: MNB

DRAWING NO.:

This is not a building permit


These documents have been reviewed for code compliance by the Division of Occupational and Professional Licenses. This review shall not be construed to be an approval of any violation of, or variance from, Idaho's adopted codes, standards, rules, or laws applicable to this project. Corrections will be required for any code violations found during the inspection process.

Plan Approval #:BLD2201-00069 Date:03/11/22

CIRCUIT LEGEND

(5) CONNECT LIGHT UNSWITCHED FOR CONTINUOUS OPERATION.

O-10 DIMMING LINE VOLTAGE LIGHTING CONDUCTORS AND 0-10V (GREY, PURPLE) DIMMING CONDUCTORS

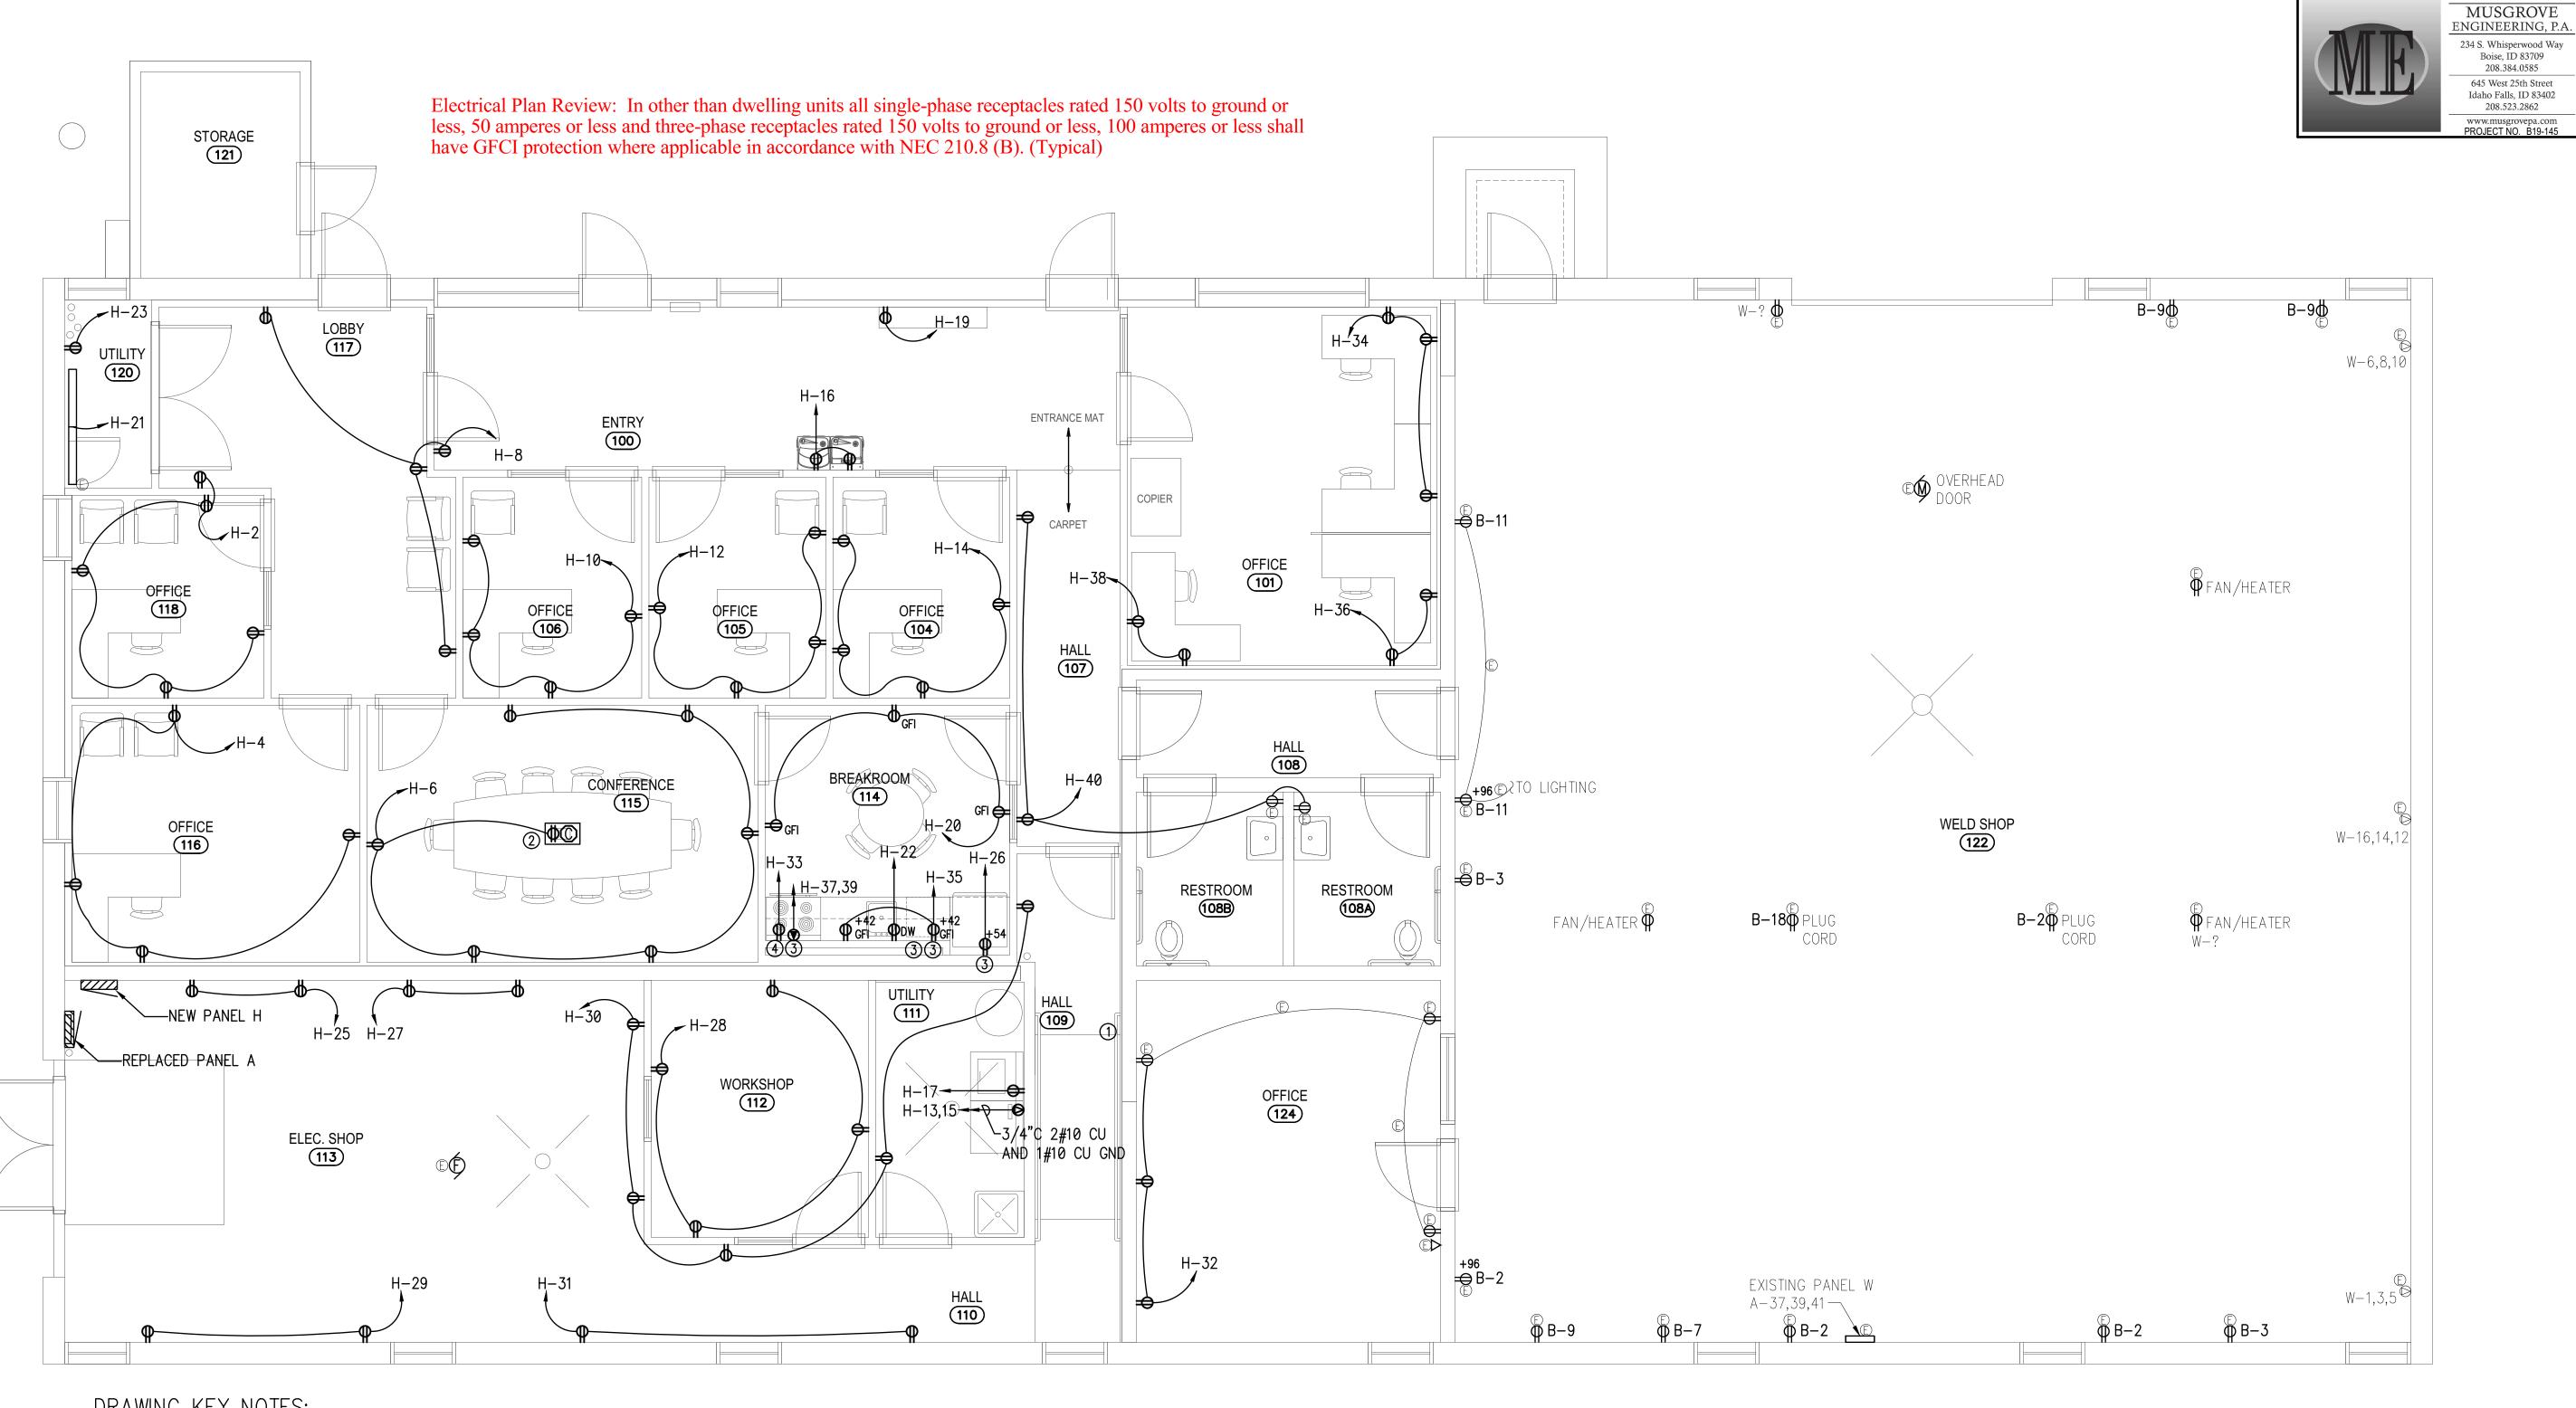

DRAWING KEY NOTES:

- ① PROVIDE JUNCTION BOX IN CEILING FOR RECONNECTION OF EXISTING WELD SHOP CIRCUITS TO NEW PANEL. SEE DEMO DRAWINGS
- ② COORDINATE SAW CUTTING OF CONCRETE TO INSTALL FLOOR BOX AND CONDUIT. SEE DETAIL ON DRAWING E4.1.
- 3 GFCI RECEPTACLE INSTALLED IN PANEL SEE DRAWING E5.1.
- 4 VERIFY RECEPTACLE HEIGHT AND LOCATION WITH MICROWAVE SUBMITTAL PRIOR TO INSTALLATION



645 West 25th Street Idaho Falls, ID 83402

208.523.2862 www.musgrovepa.com PROJECT NO. B19-145

REMODEL

DPW PROJECT NO. 20-232

CODIAL OFFICE I

IDAHO STATE UNIVERSITY
POCATELLO, IDAHO COS S

REVISIONS


19032 DATE: JANUARY 2022 DRAWN BY: CCJ CHECKED BY: MNB

DRAWING NO.:

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Plan Approval #:BLD2201-00069 Date:03/11/22



13299

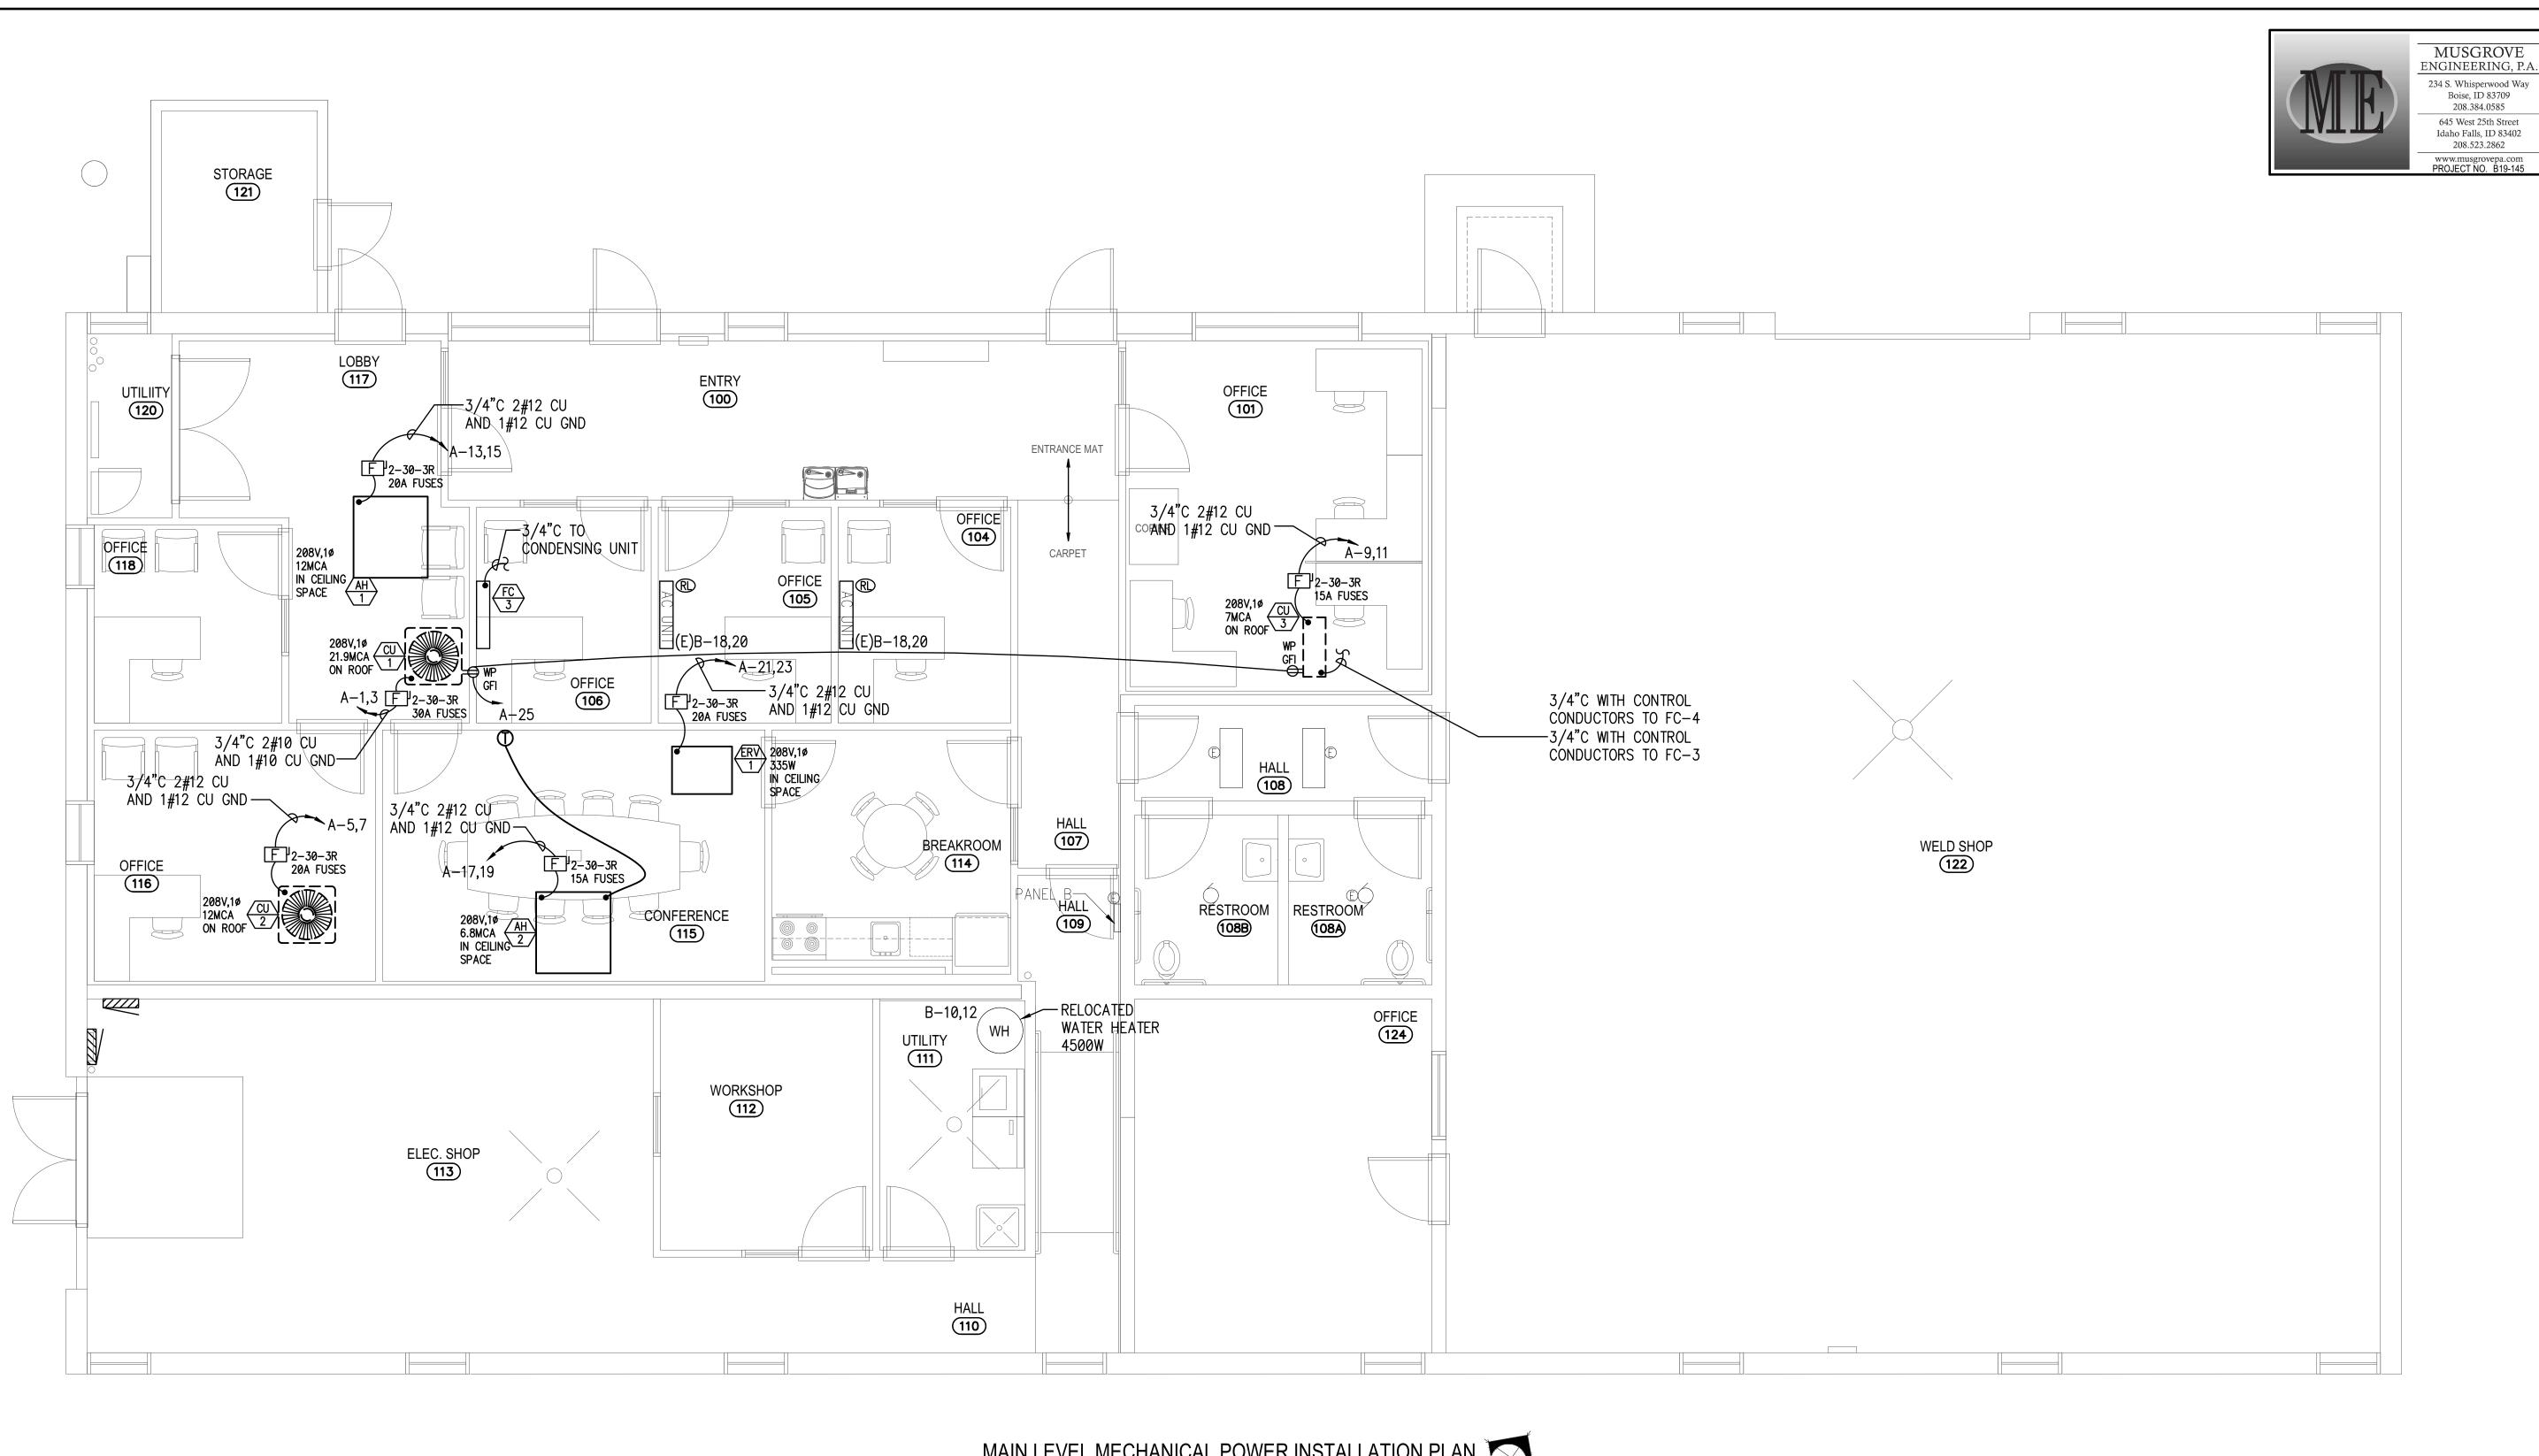III DDWarchitects D.a. BRCHITECTURE/PLANNING/INTERIORS

DPW PROJECT NO. 20-232

TODIAL OFFICE REMODEL
IDAHO STATE UNIVERSITY
POCATELLO, IDAHO

CNS. ISU

REVISIONS

PROJECT NO.: 19032 DATE:

JANUARY 2022 DRAWN BY: CCJ CHECKED BY: MNB

DRAWING NO.:


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Plan Approval #:BLD2201-00069 Date:03/11/22

MAIN LEVEL MECHANICAL POWER INSTALLATION PLAN

SCALE: 1/4" = 1'-0"



DRAWING KEY NOTES:

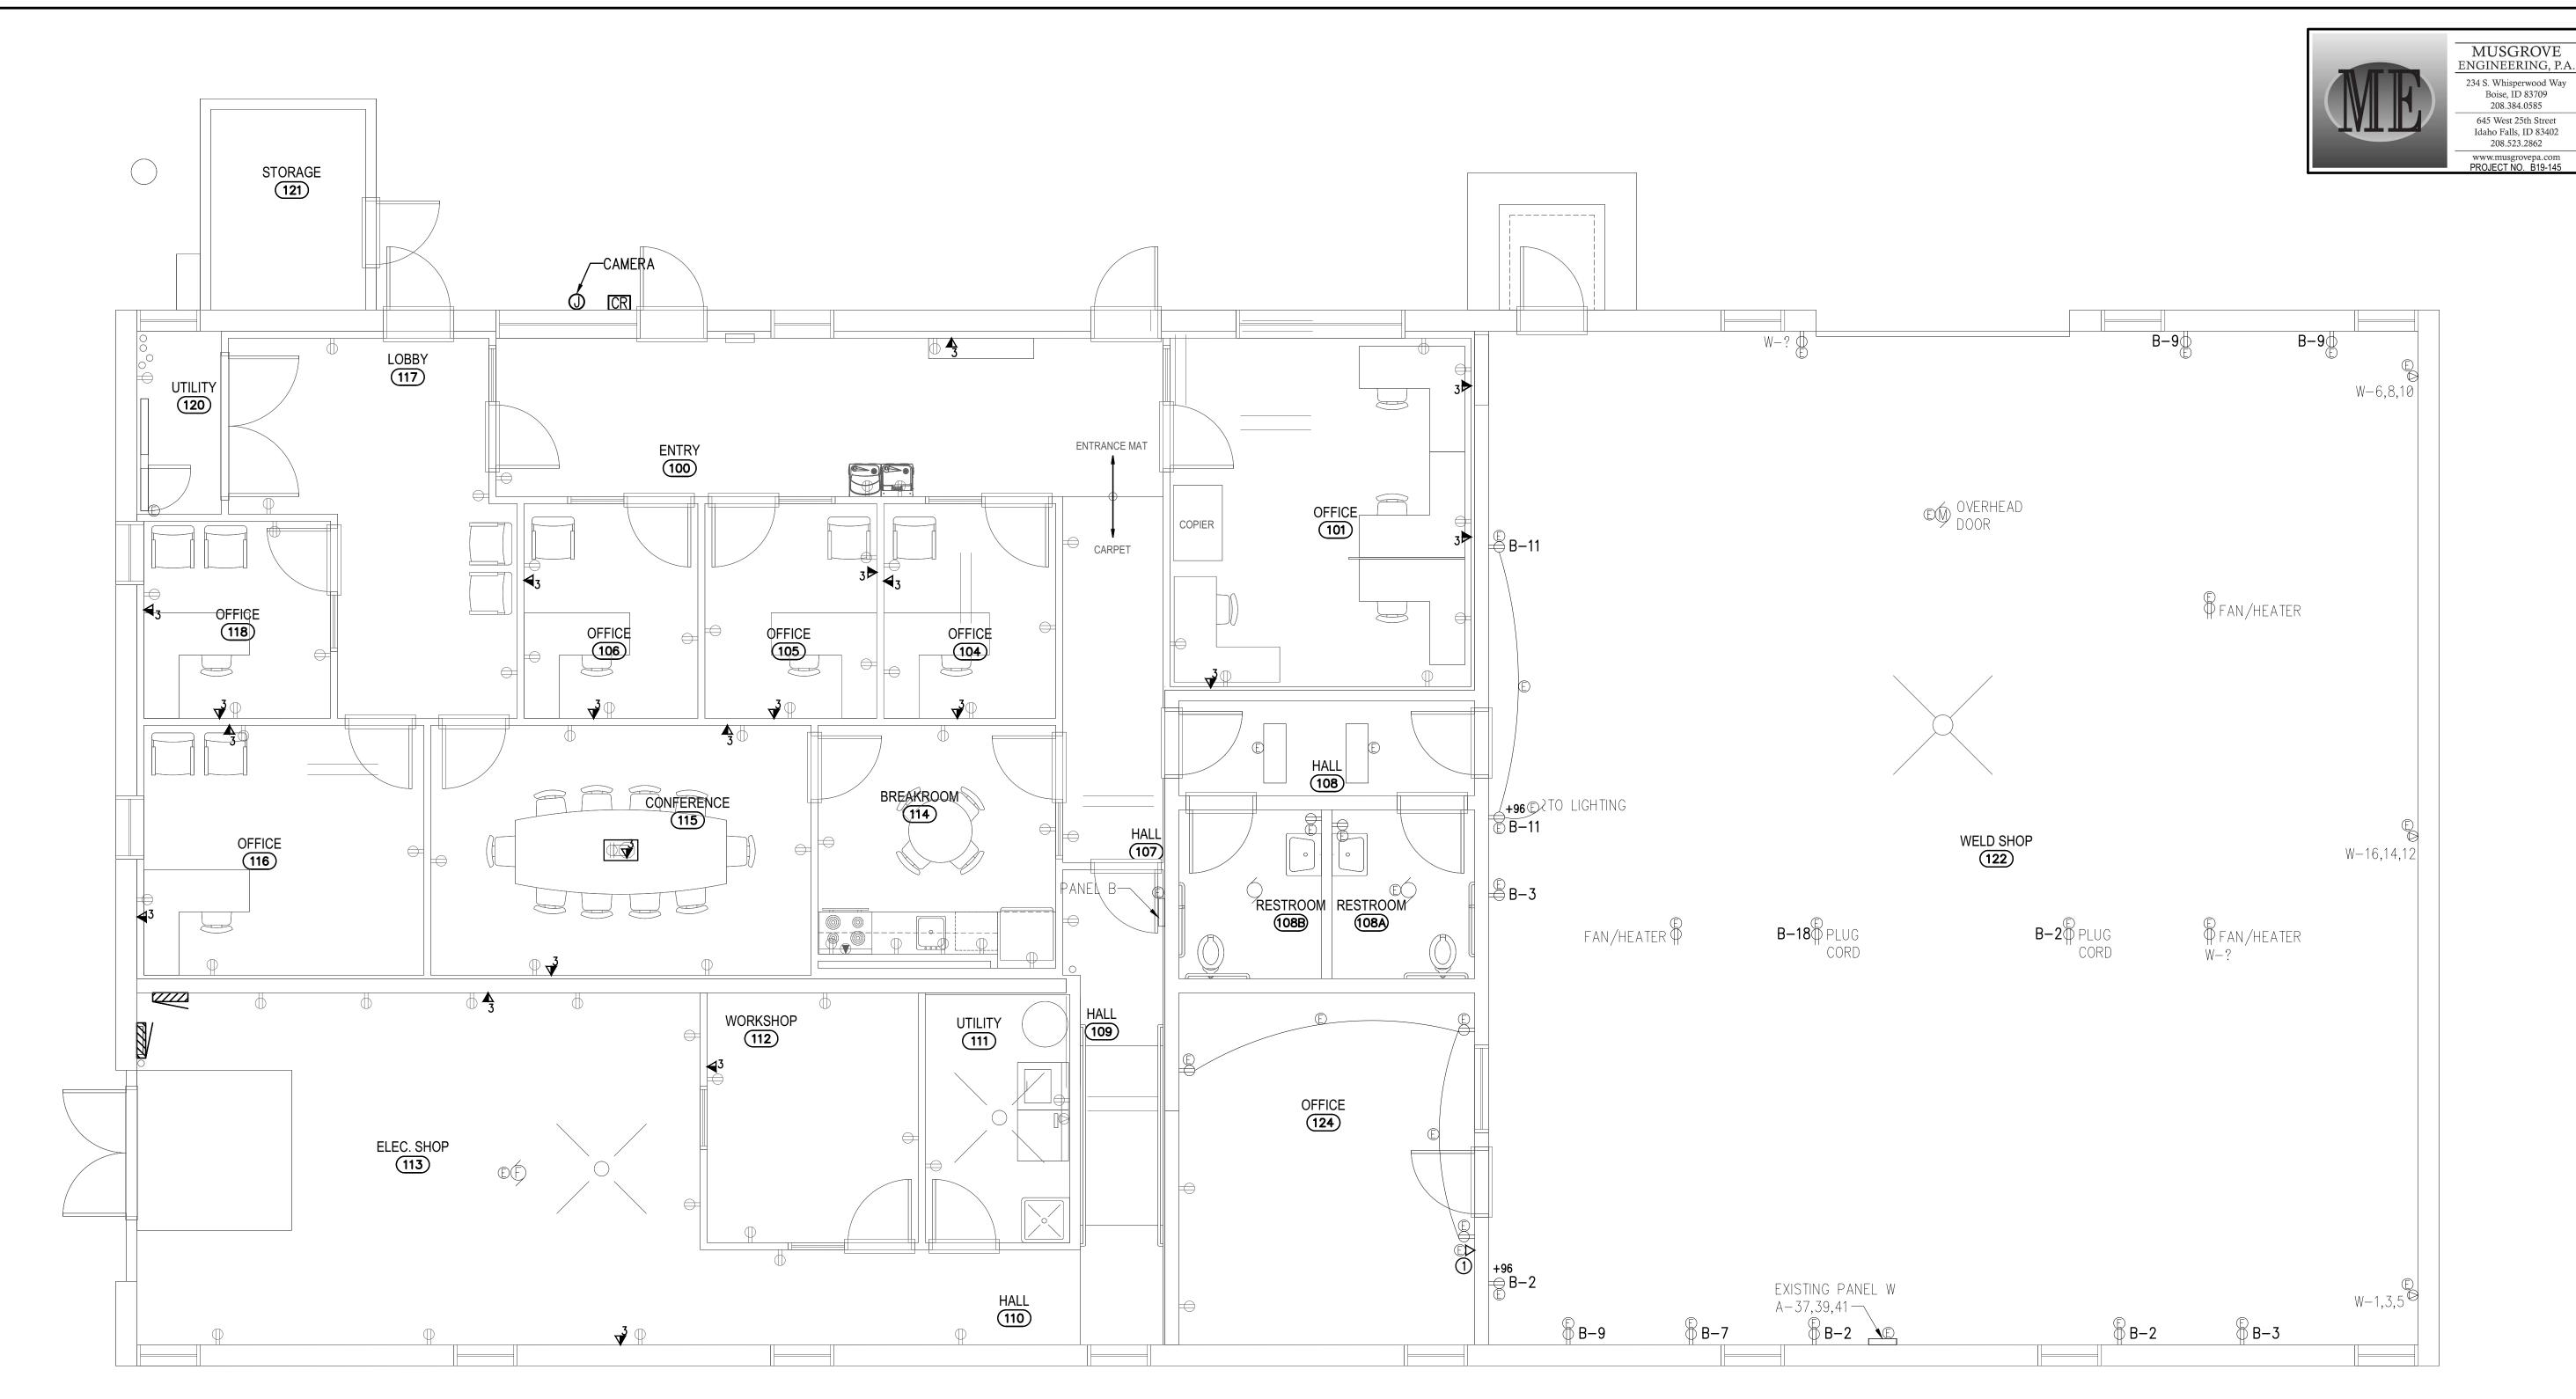① PROVIDE CATSE CABLE FROM RELOCATED COPPER HEAD END TO EXISTING DATA OUTLET.

MAIN LEVEL SPECIAL SYSTEMS INSTALLATION PLAN SCALE: 1/4" = 1'-0"

> This is not a building permit Plan Approval #:BLD2201-00069 Date:03/11/22 These documents have been reviewed for code compliance by the Division of Occupational and Professional Licenses. This review shall not be construed to be an approval of any violation of, or variance from, Idaho's adopted codes, standards, rules, or laws applicable to this project. Corrections will be required for any code violations found during the inspection process.

13299

III DDWarchitects D.a. BR CHITECTURE / PLANNING / INTERIORS 990 JOHN RDAMS PARKWAY / P.O. BOX 2212 / IDAHO FALLS, IDAHO B3403-2212 (P) 208.522.8779 (F) 208.522.8785 (W) nbwarchitects.com


DPW PROJECT NO. 20-232

TODIAL OFFICE REMODEL
IDAHO STATE UNIVERSITY
POCATELLO, IDAHO S INSTALLATION PLAN


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REVISIONS

PROJECT NO.: 19032 DATE: JANUARY 2022 DRAWN BY: CCJ CHECKED BY: MNB

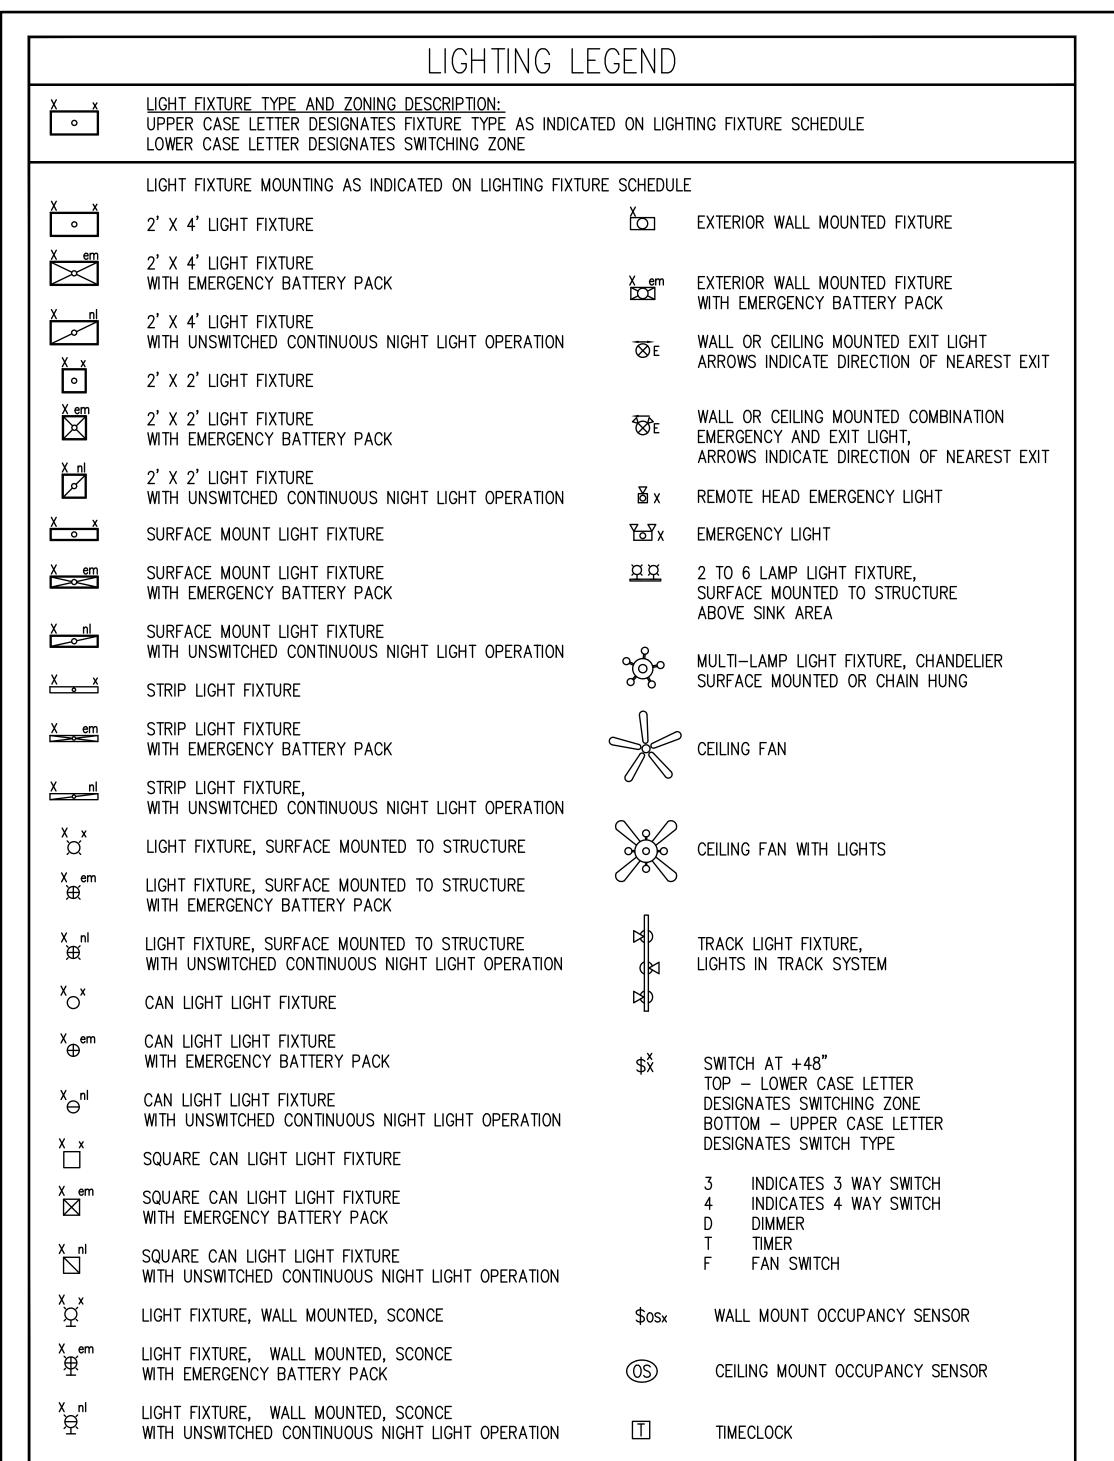

NOTE: ALL SYMBOLS MAY NOT BE USED ON THIS PROJECT

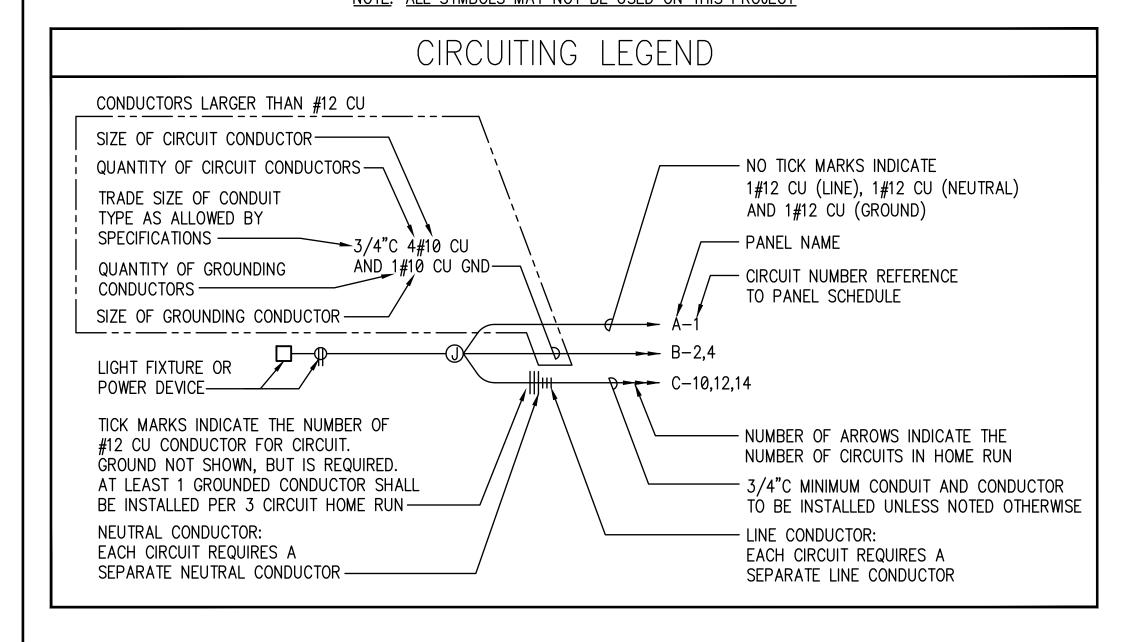

	POWER LEGEND
\$ <u>e</u>	MANUAL MOTOR STARTER SWITCH
	TIMECLOCK
C	CONTACTOR
IC	IRRIGATION CONTROL PANEL
DSI XP-XA-X	DISCONNECT SWITCH POLES, AMPS, AND NEMA ENCLOSURE TYPE AS NOTED
T XP-XA-X XA FUSES	FUSED DISCONNECT SWITCH POLES, AMPS, NEMA ENCLOSURE TYPE, AND FUSE SIZE AS NOTED
\Box	THERMOSTAT, AT +48 INCHES
∅	MOTOR F INDICATES FAN (FRACTIONAL HORSEPOWER) # INDICATES MOTOR SIZE (IN HORSEPOWER)
0	CLOCK
0	JUNCTION BOX
\$	RECESSED AUDIO SPEAKER
\bigvee	VOLUME CONTROL, AT +48 INCHES
	ELECTRICAL PANEL
—w—	SURFACE RACEWAY
GFI C ⇒ SPD WP	DUPLEX RECEPTACLE AT +18 INCHES UNLESS NOTED OTHERWISE GFI GROUND FAULT INTERRUPTER C MOUNTED ON CEILING SPD SURGE SUPPRESSION WP IN-USE WEATHERPROOF RATED COVER WITH WEATHER RESISTANT GFI RECEPTACLE
GFI C SPD WP	DOUBLE DUPLEX RECEPTACLE AT +18 INCHES UNLESS NOTED OTHERWISE GFI GROUND FAULT INTERRUPTER C MOUNTED ON CEILING SPD SURGE SUPPRESSION WP IN-USE WEATHERPROOF RATED COVER WITH WEATHER RESISTANT GFI RECEPTACLE
Φ©	DATA/COMM/POWER FLOOR BOX
REB	RECESSED ENTERTAINMENT BOX
CR	CARD READER BOX
⟨TV⟩	TELEVISION DUPLEX RECEPTACLE AND CABLE JUNCTION BOX LOCATION
\times	30A, 250V SPECIAL PURPOSE RECEPTACLE VERIFY NEMA PLUG TYPE REQUIRED PRIOR TO INSTALLATION
•	50A, 250V SPECIAL PURPOSE RECEPTACLE VERIFY NEMA PLUG TYPE REQUIRED PRIOR TO INSTALLATION
	ELECTRICAL METER
СТ	CURRENT TRANSFORMER CABINET SIZE AS INDICATED ON DRAWINGS
_~-	UNIT HEATER SIZE AS INDICATED ON DRAWINGS
-	FAN FORCED WALL HEATER SIZE AS INDICATED ON DRAWINGS
WH	WATER HEATER SIZE AND TYPE AS INDICATED ON DRAWINGS
	ELECTRIC BASEBOARD HEATER SIZE AND TYPE AS INDICATED ON DRAWINGS
X #	MECHANICAL EQUIPMENT CALLOUT

NOTE: ALL SYMBOLS MAY NOT BE USED ON THIS PROJECT

ONE-LINE LEGEND NON-FUSED SWITCH (OPEN) NON-FUSED SWITCH (CLOSED) FUSED SWITCH (OPEN) **₽** FUSED SWITCH (OPEN) START BUTTON STOP BUTTON CIRCUIT BREAKER \mathcal{O} OVER LOAD HEATER NORMALLY OPEN SWITCH \longrightarrow **→**// NORMALLY CLOSED SWITCH \mathcal{L} TRANSFORMER \sim •——• FUSE HAND/OFF/AUTO SWITCH ΑО CURRENT TRANSFORMER \equiv GROUND (EARTH GROUND) $\langle X \rangle$ INDICATES FAN (FRACTIONAL HORSEPOWER) INDICATES MOTOR SIZE (IN HORSEPOWER) PANEL X X00A 208/120V ELECTRICAL PANEL PACKAGED EQUIPMENT SIZE b HP, KW, KVA COMBINATION STARTER WITH CONTROL PANEL POWER TRANSFORMER CIRCUIT BREAKER DISCONNECT, TYPE AS NOTED STARTER TYPE NEMA STARTER SIZE OVERLOAD HEATERS

NOTE: ALL SYMBOLS MAY NOT BE USED ON THIS PROJECT

DATA/COMMUNICATIONS LEGEND

	1717 0011111011101110110 2202110
⋖ #	DATA JACK, +18" UNLESS NOTED OTHERWISE # INDICATES QUANTITY OF STRUCTURED CABLES TERMINATING ON RJ45 JACK(S) AT FACEPLATE.
→ #	DATA/COMM QUANTITY OF STRUCTURED CABLES TERMINATING ON RJ45 JACK(S) AT FACEPLATE.
< #	COMMUNICATIONS JACK, +18" UNLESS NOTED OTHERWISE # INDICATES QUANTITY OF STRUCTURED CABLES TERMINATING ON RJ45 JACK(S) AT FACEPLATE.
©	ROUGH-IN JUNCTION BOX AT +18", UNLESS NOTED OTHERWI (ROUGH IN ONLY, NO CABLES)
-w-	SURFACE RACEWAY
ФО	DATA/COMM/POWER FLOOR BOX
	19" 4 POST NETWORK RACK
中	19" 2 POST NETWORK RACK

NOTE: ALL SYMBOLS MAY NOT BE USED ON THIS PROJECT

WALL MOUNTED NETWORK RACK



ABBREVIATIONS

AMERICAN WIRE GAUGE

CURRENT TRANSFORMER

ELECTRICAL METALLIC TUBING

GROUND FAULT INTERRUPTER

INTERMEDIATE METALLIC CONDUIT

HIGH PRESSURE SODIUM

KILOWATT VOLT AMPS

MINIMUM CIRCUIT AMPS

MOTOR CONTROL CENTER

NATIONAL ELECTRIC CODE

THOUSAND CIRCULAR MIL(S)

AMPERE INTERRUPTING CAPACITY

AMPERE(S)

ALUMINUM

CONDUIT

DISCONNECT

FUSIBLE SWITCH

GENERATOR

HORSEPOWER

INCANDESCENT

KILOVOLT

KILOWATT(S)

MAIN LUG ONLY

NORMALLY CLOSED

NOT IN CONTRACT

POLYVINYL CHLORIDE

RIGID GALVANIZED STEEL

UNLESS NOTED OTHERWISE

UNINTERRUPTED POWER SYSTEM

NOT TO SCALE

SWITCHBOARD

TRANSFORMER

UNDERGROUND

TYPICAL

VOLT(S)

VOLTAMP(S)

WEATHER PROOF

PANEL

NORMALLY OPEN

GROUND

DRAWING

CB

CKT

CU

DWG

GEN

GFI

GND

HP

IMC

INC

K۷

KVA

ΚW

KCMIL

MCA

MCC

MLO

NC

NO

NEC

NIC

NTS

PNL

PVC

RGS

SWBD

XMFR

TYP

BARE COPPER

CIRCUIT BREAKER





T

FREQUENCY IN CYCLES PER SECOND

ELECTRICAL DRAWING LIST

E0.1 ELECTRICAL TITLE SHEET DE1.1 MAIN LEVEL LIGHTING DEMOLITION PLAN DE1.2 MEZZANINE LEVEL LIGHTING DEMOLITION PLAN

DE2.1 MAIN LEVEL POWER DEMOLITION PLAN DE2.2 MEZZANINE LEVEL POWER DEMOLITION PLAN SE1.1 ELECTRICAL SITE PLAN

E1.1 MAIN LEVEL LIGHTING INSTALLATION PLAN E2.1 MAIN LEVEL POWER INSTALLATION PLAN E3.1 MAIN LEVEL MECHANICAL POWER INSTALLATION PLAN

E4.1 MAIN LEVEL SPECIAL SYSTEMS INSTALLATION PLAN E5.1 PANEL SCHEDULES AND SINGLE LINE DIAGRAM E6.1 ELECTRICAL DETAILS

E7.1 LIGHTING DETAILS

Electrical Plan Review: The stamped documentation has been Reviewed for Compliance in accordance with the 2017 NEC as adopted by the State of Idaho by an Electrical Plan Review. This shall not be construed as an approval of any violation of, or variance from Idaho adopted codes, laws, standards, or rules. Final approval will be based upon on-site electrical inspections to field verify compliance. Additional Electrical Plan Review Notes can be found on additional Electrical Drawing Sheets.


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9 H ≧ 0 .

19032 JANUARY 2022 DRAWN BY: CCJ CHECKED BY: MNB DRAWING NO.:



POWER RISER SCALE: NTS

			ELE	CIRIC	AL LO	AD SU	IMIMAR	KY (PAI	VEL A)					
FEEDER	VOLTAGE				CONNE	CTED LOA	D (KVA)					TAL TED LOAD		TAL D LOAD
, LLDLIX	VOLINGE	LIGHTING	RECEP	MOTORS	KITCHEN	HVAC	ELEC HEAT	WATER HEAT	MISC	EXIST	KVA	AMPS	KVA	AMPS
EXISTING LOAD	120/208Y									21.0	21.0	58.3	21.0	58.3
25% ADDITIONAL LOAD	120/208Y									5.3	5.3	14.6	5.3	14.6
NEW LOAD	120/208Y									61.0	61.0	169.5	61.0	169.5
LOAD REMOVED	120/208Y									-49.0	-49.0	-136.1	-49.0	-136.1
TOTAL	120/208Y	0.0	0.0	0.0	0.0	0.0	0.0	0.0	0.0	38.3	38.3	106.3	38.3	106.3

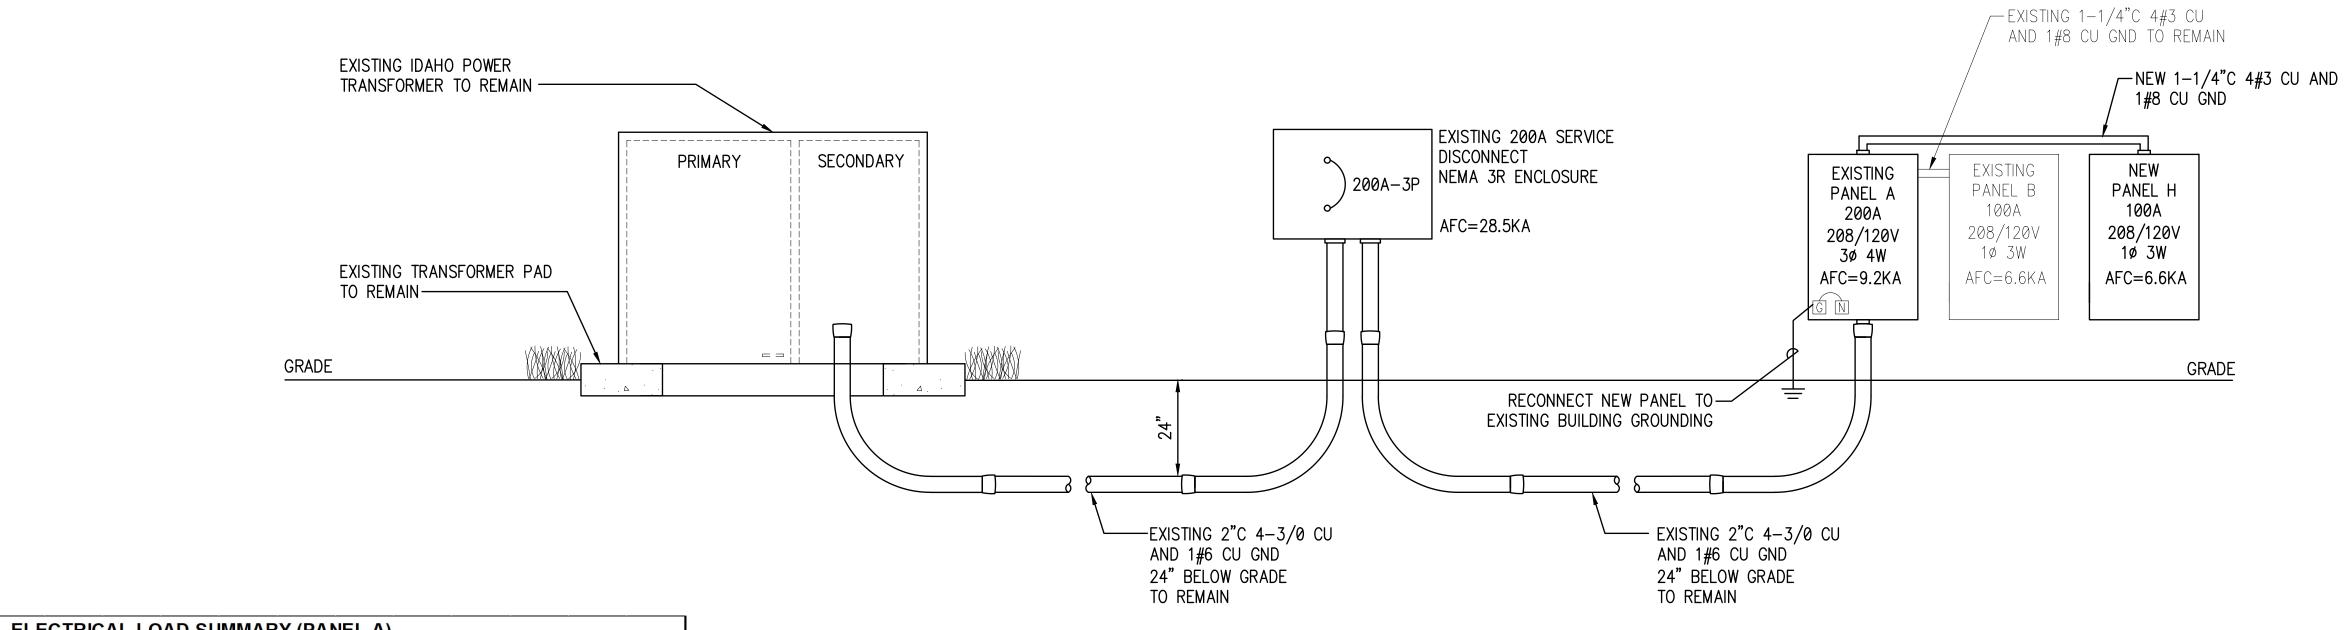PANEL	A (EXIS	TII	NG)										
VOLTAGE: 208/120V	3PHASE DELT	ΆВ	PHASE I	HIGH L	EG	DIMEN	SION:	PER NEC				LO	CATION: ELEC SHOP
PANEL AMP RATING:	225A W	/ITH	200A	СВ		MOUNT	ΓING:	SURFACE	•			NEI	MA ENCLOSURE: 1
WIRES: 3	PHASE: 3		FEED:	вотт	ОМ	TYPE:		SQUARE	D QO	LOAD (ENTER		
LOAD DESCR	IPTION	PH	LOAD	BKR	СКТ		LOAD		СКТ	BKR	LOAD	РН	LOAD DESCRIPTION
			WATT	AMPS	NO	Α	В	С	NO	AMPS	WATT		
SPACE		Α			1	0			2			Α	SPACE
SPACE		В			3		0		4			В	SPACE
SPACE		С			5			0	6			С	SPACE
SPACE		Α			7	0			8			Α	SPACE
SPACE		В			9		0		10			В	SPACE
SPACE		C			11			0	12			С	SPACE
LIGHTS AND HEATER		Α		20	13	0			14	30		Α	TRASH COMPACTOR
SPACE		В			15		0		16	**		В	
WELDING RECEPT		O		15	17			0	18	**		С	3 POLE
		Α		**	19	0			20	20		Α	EXTERIOR LIGHTING
	3 POLE	В		**	21		0		22	15		В	EAST OS OUT & IN RECEPT
SPARE		С		15	23			0	24	40		С	A/C UNITS
LIGHTS + BENCH		Α		20	25	0			26	**		Α	2 POLE
SPACE		В			27		0		28			В	SPACE
NOISY FAN		С		20	29			0	30	40		С	PANEL D
PANEL C (KEY SHOP)		Α		50	31	0			32	**		Α	2 POLE
		В		**	33		0		34			В	SPACE
	3 POLE	С		**	35			0	36	40		С	PANEL B
PANEL W (WELD SHOP)		Α		100	37	0			38	**		Α	2 POLE
		В		**	39		0		40			В	SPACE
	3 POLE	С		**	41			0	42	20		С	MAINTENANCE LIGHTS
FEEDER BREAKER	TOTAL LO	AD I	PER PHA	SE-W	ATTS	0	0	0		FEED	FROM:		SERVICE
RATING: 200A	TOTAL L	OAD	PER PH	IASE-A	MPS	0	0	0		PANEL	AIC RA	TING	G: 10,000
WIRE SIZE: 4#3/0 CU &	1#6 CU GND				,				-	COND	UIT SIZE	:	2 1/2"C

PANEL B (EXIS	TII	NG)										
VOLTAGE: 208/120V 3					DIMEN	SION:	PER NEC				LO	CATION: HALL WAY
PANEL AMP RATING: 125A W	/ITH	125A	СВ		MOUNT	ΓING:	SURFACE	E			NE	MA ENCLOSURE: 1
WIRES: 3 PHASE: 3		FEED:	вотт	ОM	TYPE:		SQUARE	D QO	LOAD	CENTER		
LOAD DESCRIPTION	РН	LOAD WATT	BKR AMPS	CKT NO	Α	LOAD B	С	CKT NO		LOAD WATT	PH	LOAD DESCRIPTION
MECH - N WALL	Α		20	1	0			2	20		Α	OVERHEAD DOOR
LIGHTS AND HEATER	В		20	3		0		4	20		В	TOILET AND HALL LIGHTS
FAN OUTLET WEST	С		20	5			0	6	20		С	OFFICE LIGHTS
MECH PLUGS AND LIGHTS	Α		20	7	0			8	20		Α	BLANK
ROOF FAN	В		20	9		0		10	20		В	WATER HEATER
FIRST ROW SHOP LIGHTS	С		20	11			0	12	**		С	2 POLE
SECOND ROW SHOP LIGHTS	Α		20	13	0			14	20		Α	ELECT SHOP
FAN EXHAUST	В		20	15		0		16	20		В	EXISTING
OFFICE PLUGS	С		20	17			0	18	20		С	OFFICE AC
EAST SHOP	Α		20	19	0			20	**		Α	2 POLE
PLUMB LIGHTS 3 POLE	В		20	21		0		22	20 A/B		В	BATHROOM / BATHROOM
WATER COOLER	С		20	23			0	24	20		С	BLANK
FEEDER BREAKER TOTAL LO	ADI	PER PH/	SE-W/	TTS	0	0	0		FEED	FROM:		PANLE A
RATING: 100A TOTAL L	OAD	PER PH	IASE-A	MPS	0	0	0		PANE	L AIC RA	TIN	G: 10,000
WIRE SIZE: 4#3 CU & 1#8 CU GND									COND	UIT SIZE	:	1 1/4"C

	A (REV	IOL	ן ט											
VOLTAGE: 208/120V	3 PHASE					DIMEN	SION:	PER NEC				LO	CATION: ELEC SHOP	
PANEL AMP RATING: 225	5A V	VITH	200A	СВ		MOUN	ΠNG:	SURFACE	≣			NEMA ENCLOSURE: 1		
WIRES: 4 P	HASE: 3		FEED:	вотт	ОМ	TYPE:		SQUARE	D QO	LOAD	CENTER			
LOAD DESCRIP	TION	PH		BKR	СКТ		LOAD		СКТ	BKR		PH	LOAD DESCRIPTION	
			WATT	AMPS	NO	Α	В	С	NO	AMPS	WATT			
CU-1		A	1594	30	1	1594			2	20		Α	BLANK	
	2 POLE	В	1594	**	3		1594		4	20		В	BLANK	
CU-2		С	874	20	5			874	6	20		С	BLANK	
	2 POLE	Α	874	**	7	874			8	20		Α	EXTERIOR LIGHTING	
CU-3		В	510	15	9		510		10	20		В	EAST OS OUT & IN RECEPT	
	2 POLE	С	510	**	11			510	12	20		С	SPARE	
AH-1		Α	655	15	13	655			14	30		Α	TRASH COMPACTOR	
	2 POLE	В	655	**	15		655		16	**		В		
AH-2		С	218	15	17			218	18	**		С	3 POLE	
	2 POLE	Α	218	**	19	218			20	20		Α	SPARE	
ERV-1		В	168	20	21		168		22	20		В	SPARE	
	2 POLE	С	168	**	23			168	24	20		С	SPARE	
RECEPT - ROOF TOP		Α	360	20	25	360			26	20		Α	SPARE	
SPARE		В		20	27		0		28	20		В	SPARE	
SPARE		С		20	29			0	30	20		С	SPARE	
SPARE		Α		20	31	0			32	20		Α	SPARE	
SPARE		В		20	33		0		34	40		В	PANEL B	
SPARE		С		20	35			0	36	**		С	2 POLE	
PANEL W (WELD SHOP)		Α	8400	100	37	18985			38	100	10585	Α	PANEL H	
		В	8400	**	39		17599		40	**	9199	В		
	3 POLE	С	8400	**	41			14820	42	**	6420	С	3 POLE	
FEEDER BREAKER	TOTAL LO	OAD	PER PHA	SE-W	ATTS	22687	20526	16590		FEED	FROM:		SERVICE	
RATING: 200A	TOTAL	LOAD	PER PH	IASE-A	MPS	189	171	138	1	PANEI	L AIC RA	TING	G: 10,000	

PANEL B (N	IEW)											
VOLTAGE: 208/120V 3					DIMEN	SION:	PER NEC				LO	CATION: HALL WAY
PANEL AMP RATING: 125A	WITH	125A	СВ		MOUNT	ING:	SURFACE				NEI	MA ENCLOSURE: 1
WIRES: 3 PHASE: 3		FEED:	вотто	MC	TYPE:		SQUARE	D QO	LOAD	CENTER		
LOAD DESCRIPTION	PH	LOAD WATT		CKT NO	Α	LOAD B	С	CKT NO	BKR AMPS	LOAD WATT	РН	LOAD DESCRIPTION
MECH - N WALL	Α		20	1	0			2	20		Α	OVERHEAD DOOR
LIGHTS AND HEATER	В		20	3		0		4	20		В	TOILET AND HALL LIGHTS
FAN OUTLET WEST	С		20	5			0	6	20		С	OFFICE LIGHTS
MECH PLUGS AND LIGHTS	Α		20	7	0			8	20		Α	BLANK
ROOF FAN	В		20	9		0		10	20		В	WATER HEATER
SHOP PLUGS	С		20	11			0	12	**		С	2 POLE
SPARE	Α		20	13	0			14	20		Α	SPARE
FAN EXHAUST	В		20	15		0		16	20		В	SPARE
SPARE	С		20	17			0	18	20		С	OFFICE AC
SPARE	Α		20	19	0			20	**		Α	2 POLE
SPARE	В		20	21		0		22	20		В	SPARE
SPARE	С		20	23			0	24	20		С	BLANK
FEEDER BREAKER TO	TAL LOAD	PER PHA	SE-WA	TTS	0	0	0		FEED	FROM:		PANLE A
RATING: 100A T	OTAL LOAD	PER PH	IASE-A	MPS	0	0	0		PANE	L AIC RA	TIN	G: 10,000
WIRE SIZE: 4#3 CU & 1#8 CU GND									COND	UIT SIZE		1 1/4"C

PANEL	Н												
VOLTAGE: 208/120V					DIMEN	DIMENSION: PER NEC			LOCATION: ELECTRICAL SHOP				
PANEL AMP RATING: 100A WITH 100A CB				MOUNT	MOUNTING: SURFACE			NEMA ENCLOSURE: 1					
WIRES: 4	PHASE: 3		FEED:	вотто	ОМ	TYPE:		SQUARE D NQ				IN LIGEOGRE.	
LOAD DESCRIPTION		РН	LOAD	BKR	СКТ		LOAD		СКТ	BKR	LOAD	РН	LOAD DESCRIPTION
			WATT	AMPS	NO	Α	В	С	NO	AMPS	WATT		
LIGHTING		Α	1025	20	1	1925			2	20	900	Α	RECEPTS - RM 116, 117
LIGHTING		В	679	20	3		1399		4	20	720	В	RECEPTS - RM 114
EH-1		С	750	20	5			2010	6	20	1260	С	RECEPTS - RM 113
	2 POLE	Α	750	**	7	1470			8	20	720	Α	RECEPTS - RM 100, 115
EH-2		В	750	20	9		1470		10	20	720	В	RECEPTS - RM 101
	2 POLE	С	750	**	11			1470	12	20	720	С	RECEPTS - RM 102
DRYER		Α	750	30	13	1470			14	20	720	Α	RECEPTS - RM 103
		В	750	**	15		930		16	20	180	В	DRINKING FOUNTAIN
WASHER		С	600	20	17			600	18	20		С	SPARE
KEY DISPENSER		Α	400	20	19	940			20	20	540	Α	RECEPTS - RM, 112
NETWORK CABINET		В	200	20	21		380		22	20	180	В	DISHWASHER
NETWORK RECEPT		С	180	20	23			540	24	20	360	С	RECEPTS - RM 112
RECEPTS - RM 111		Α	360	20	25	540			26	20	180	Α	FRIDGE
RECEPTS - RM 111		В	360	20	27		1080		28	20	720	В	RECEPTS - RM 110
RECEPTS - RM 111		С	360	20	29			1080	30	20	720	С	RECEPTS - RM 111
RECEPTS - RM 111		Α	360	20	31	1380			32	20	1020	Α	RECEPTS - RM 106
MICROWAVE		В	360	20	33		720		34	20	360	В	RECEPTS - RM 104
DISPOSAL		С	360	20	35			720	36	20	360	С	RECEPTS - RM 104
RANGE		Α	2500	50	37	2860			38	20	360	Α	RECEPTS - RM 104
	2 POLE	В	2500	**	39		3220		40	20	720	В	RECEPTS - 105, BATHROOMS
SPARE		С		20	41			0	42	20		С	SPARE
FEEDER BREAKER	TOTAL LO	AD	PER PHA	SE-WA	TTS	10585	9199	6420 FEED FROM: PANEL A					
RATING: 100A	TOTAL L	OAE	PER PH	IASE-A	MPS	89	77	7 54 PANEL AIC RATING: 22,000					
WIRE SIZE: 4#3 CU &	1#8 CU GND									COND	UIT SIZE	:	1 1/4"C

1) PROVIDE AND INSTALL GROUND FAULT INTERUPTER TYPE CIRCUIT BREAKER

This is not a building permit Plan Approval #:BLD2201-00069 Date: 03/11/22 These documents have been reviewed for code compliance by the Division of Occupational and Professional Licenses. This review shall not be construed to be an approval of any violation of, or variance from, Idaho's adopted codes, standards, rules, or laws applicable to this project. Corrections will be required for any code violations found during the inspection process. 13299

MUSGROVE ENGINEERING, P.A.

234 S. Whisperwood Way

Boise, ID 83709 208.384.0585

645 West 25th Street Idaho Falls, ID 83402 208.523.2862

www.musgrovepa.com PROJECT NO. B19-145


REMODE STODIAL OFFICE FIDAHO STATE UNIVERSITY POCATELLO, IDAHO

NGLE LINE DIAGRAM

REVISIONS

19032 JANUARY 2022 CHECKED BY:



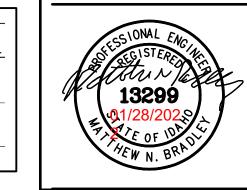

Dbwarchitects D.a.

DPW PROJECT NO. 20-232

FODIAL OFFICE REMODE
IDAHO STATE UNIVERSITY
POCATELLO, IDAHO

ISO COS

REVISIONS

PROJECT NO.:
19032
DATE:
JANUARY 2022
DRAWN BY:
CCJ


MNB
DRAWING NO.:


This is not a building permit

These documents have been reviewed for code compliance by the Division of Occupational and Professional Licenses. This review shall not be construed to be an approval of any violation of, or variance from, Idaho's adopted codes, standards, rules, or laws applicable to this project. Corrections will be required for any code violations found during the inspection process

Plan Approval #:BLD2201-00069 Date:03/11/22 CHECKED BY:

E6.1

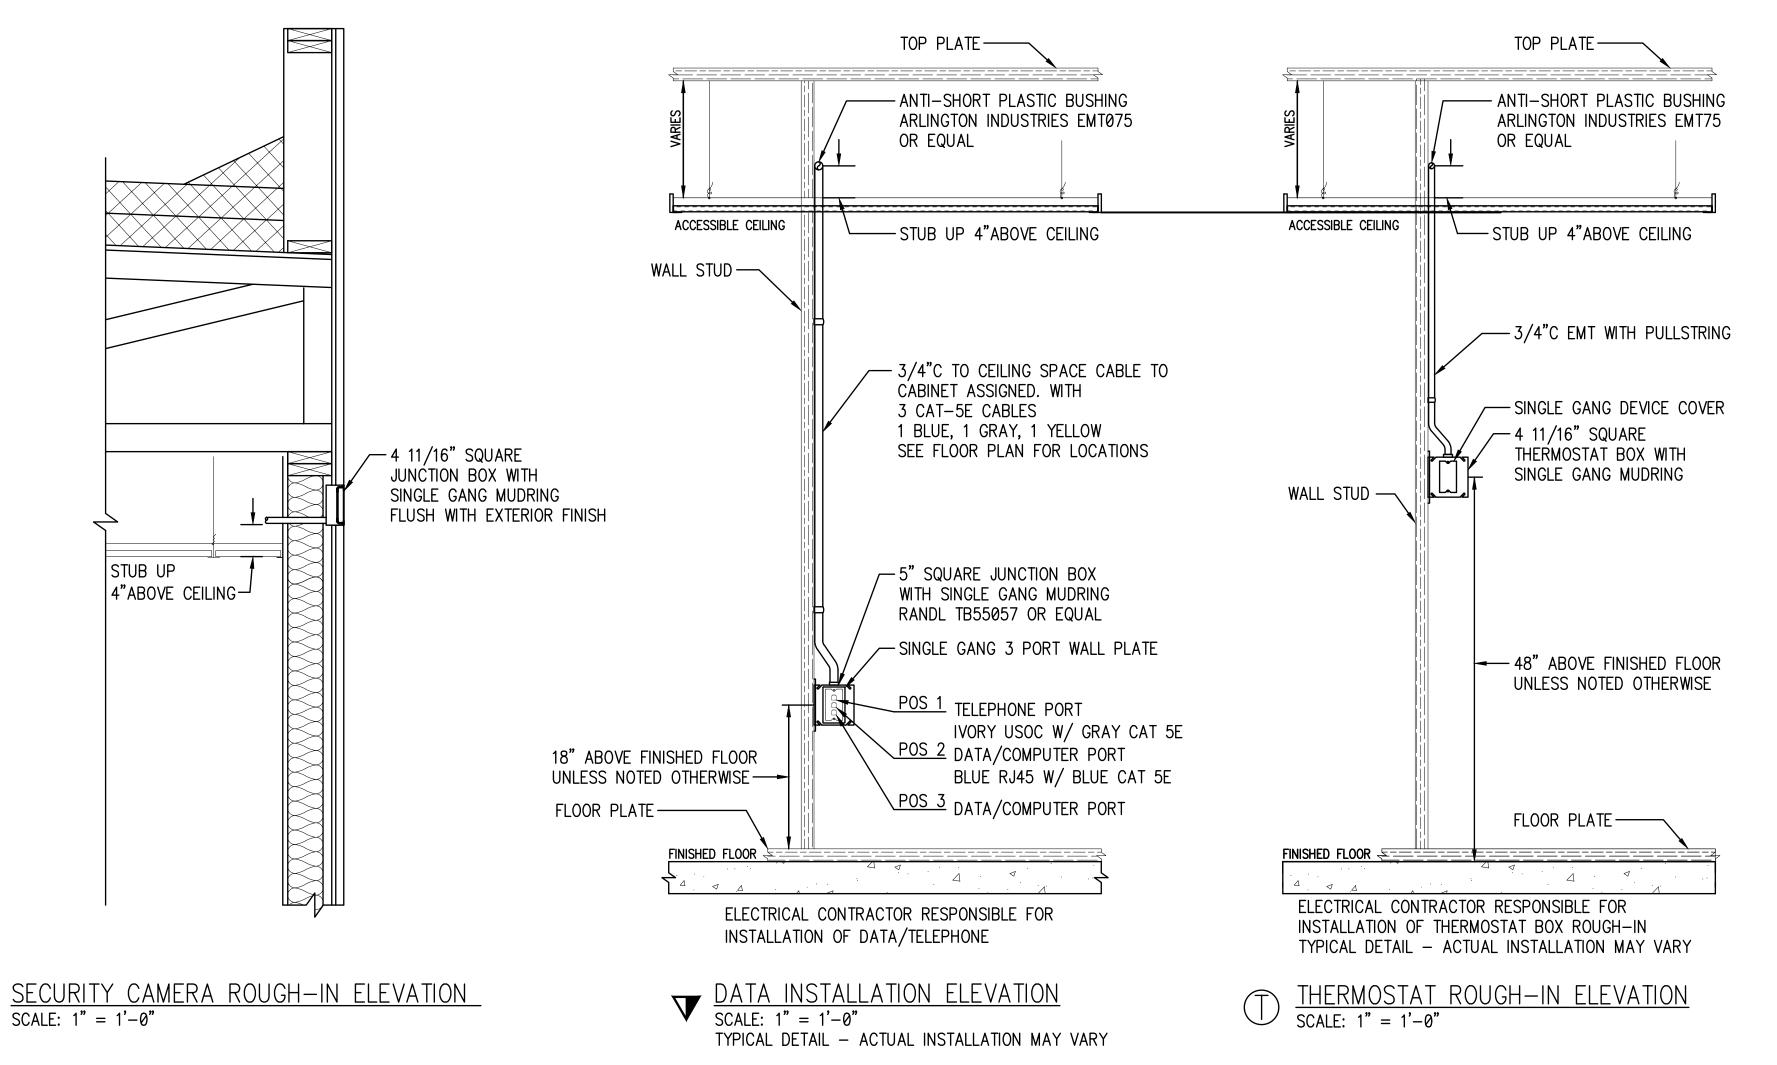

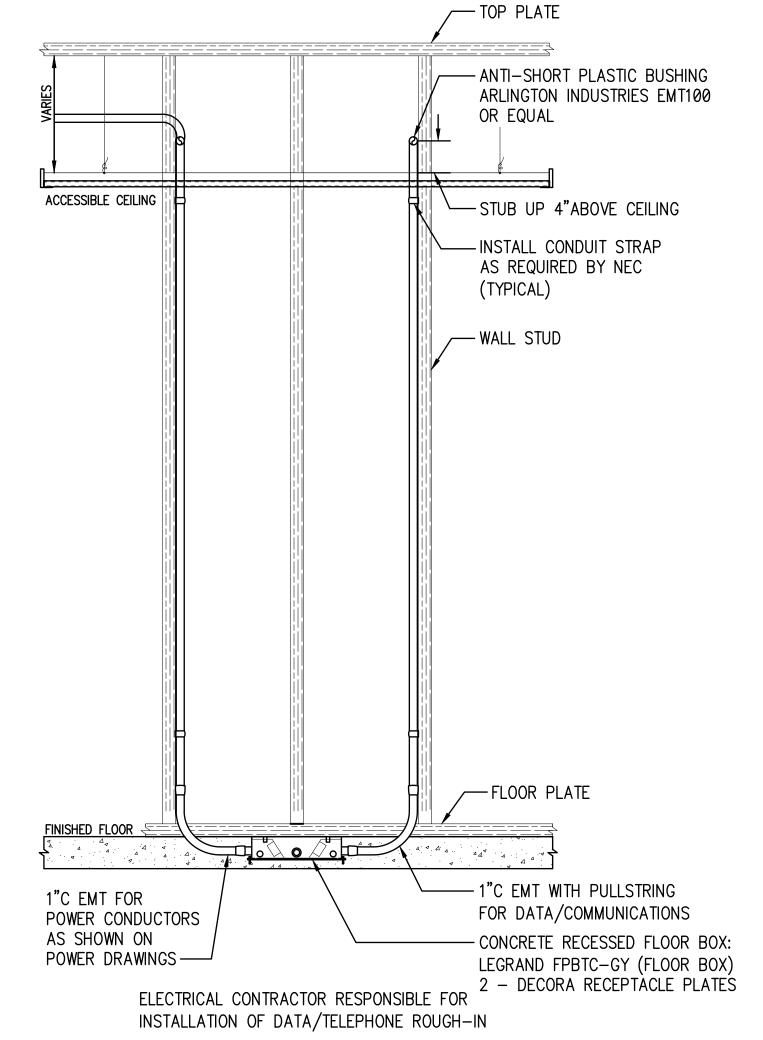

POWER/DATA FLOOR BOX CONCRETE ROUGH—IN ELEVATION TYPICAL DETAIL — ACTUAL INSTALLATION MAY VARY



MUSGROVE ENGINEERING, P.A. 234 S. Whisperwood Way Boise, ID 83709 208.384.0585 645 West 25th Street Idaho Falls, ID 83402 208.523.2862 www.musgrovepa.com PROJECT NO. B19-145



DPW PROJECT NO. 20-232

CODIAL OFFICE I
IDAHO STATE UNIVERSITY
POCATELLO, IDAHO

S

REVISIONS

PROJECT NO.: 19032 DATE: JANUARY 2022 DRAWN BY: CCJ CHECKED BY:

DRAWING NO.:

MNB

▲ COM*check* Software Version 4.1.5.3 **Interior Lighting Compliance Certificate**

Project Information

Energy Code: 2015 IECC Project Title: ISU CUSTODIAL OFFICE REMODEL Project Type: Alteration

Construction Site: 652 EAST DUNN STREET POCATELLO, ID 83201

Owner/Agent: IDAHO STATE UNIVERSITY POCATELLO, ID 83201

Designer/Contractor: ANDREW YANOSHEK BRADLEY ENGINEERING CHTD 645 WEST 25TH STREET IDAHO FALLS, ID 83402 208-523-2862 BEC@BRADLEYENGINEERING.COM

Allowed Interior Lighting Power

A Area Category	В Floor Area (ft2)	Allowed Watts / ft		บ wed Watts (B X C)
1-Office	2829	0.82	2320	
	To	otal Allowed W	/atts =	2320
Proposed Interior Lighting Power				
Α	В	С	D	E
Fixture ID: Description / Lamp / Wattage Per Lamp / Ballast	Lamps/	# of	Fixture	(C X D)
	Fixture	Fixtures	Watt.	
Office (2829 sq.ft.)				
LED 1: A & AE: LED Panel 33W:	1	4	32	128
LED 2: B & BE: LED Panel 41W:	1	18	42	756
LED 3: C & CE: LED Panel 54W:	1	4	52	208
LED 4: D & DE: LED Other Fixture Unit 103W:	1	3	104	312
LED 5: E: EXIT SIGN: LED Other Fixture Unit 6.5W:	1	4	2	9
LED 6: F & FE: LED Other Fixture Unit 50W:	1	8	52	416
		Total Propos	ed Watts =	1829

Interior Lighting Compliance Statement

nterior Lighting PASSES

Compliance Statement: The proposed interior lighting alteration project represented in this document is consistent with the building plans, specifications, and other calculations submitted with this permit application. The proposed interior lighting systems have been designed to meet the 2015 IECC requirements applicable mandatory requirements listed in the Inspection Checklist. systems have been designed to meet the 2015 IECC requirements in COM*check* Version 4.1.5.3 and to comply with any 12-20-2021



COMcheck Software Version 4.1.5.3 Exterior Lighting Compliance Certificate

Project Information

Energy Code: Project Title: Project Type: Exterior Lighting Zone

2015 IECC ISU CUSTODIAL OFFICE REMODEL Alteration 2 (Residential mixed use area (LZ2))

Construction Site: 652 EAST DUNN STREET POCATELLO, ID 83201

Owner/Agent: IDAHO STATE UNIVERSITY POCATELLO, ID 83201

Designer/Contractor: ANDREW YANOSHEK BRADLEY ENGINEERING CHTD 645 WEST 25TH STREET IDAHO FALLS, ID 83402 208-523-2862 BEC@BRADLEYENGINEERING.COM

Allowed Exterior Lighting Power

Α	В	С	D		E
Area/Surface Category	Quantity	Allowed Watts / Unit	Tradable Wattage	- 10-10-10-10-10-10-10-10-10-10-10-10-10-1	ed Watts X C)
Main entry	3 ft of door	20	Yes		60
Other door (not main entry)	9 ft of door	20	Yes		180
		Total Tradab	le Watts (a)	=	240
		Total All	owed Watts	=	240
	Total All	owed Supplement	tal Watts (b)	=	600
(b) A supplemental allowance equal to 600 watts may be applied towar Proposed Exterior Lighting Power A Fixture ID: Description / Lamp / Wattage Per Lam		oth non-tradable a B Lamps/ Fixture	C # of Fixtures	D Fixture Watt.	E (C X D)
Main entry (3 ft of door width): Tradable Wattage LED 1: X1: LED Other Fixture Unit 6.5W:		1	1	8	8
<u> Other door (not main entry) (9 ft of door width): Tradable Wattage</u>	2				
LED 2: X1: LED Other Fixture Unit 6.5W:		1	1	8	8
LED 3: X2: LED Other Fixture Unit 36W:		1	1	39	39
		Total Tra	dable Propos	sed Watts =	56

Exterior Lighting PASSES

Exterior Lighting Compliance Statement

Compliance Statement: The proposed exterior lighting alteration project represented in this document is consistent with the building plans, specifications, and other calculations submitted with this permit application. The proposed exterior lighting systems have been designed to meet the 2015 IECC requirements in COMcheck Version 4.1.5.3 and to comply with any applicable mandatory requirements listed in the Inspection Checklist.

MATTHEW BRADLEY, P.E.

12–20–2021

MATTHEW BRADLEY, P.E.

SWITCH	AND	OCCUPANCY	SENSOR	LEGEND

\$0S1 OCCUPANCY SENSOR - WALL MOUNT, SINGLE TECHNOLOGY, LINE VOLTAGE, WHITE. SENSOR SWITCH WSX-VLP-WH

\$0S2 OCCUPANCY SENSOR - WALL MOUNT, DUAL TECHNOLOGY, LINE VOLTAGE, SINGLE POLE WHITE. SENSOR SWITCH WSX-PDT-D-VLP-WH

OS3 OCCUPANCY SENSOR - CEILING MOUNT, DUAL TECHNOLOGY, LINE VOLTAGE, SMALL MOTION, VISIBLE LIGHT PROGRAMMING. SENSOR SWITCH CMR-PDT-9-VLP

		MANUFACTURER	FIXT	LAMP		
SYMBOL	NAME	CAT. NO.	WATTS	TYPE	MOUNTING	REMARKS
	LITHONIA	CPANL 2X4 40/50/60LM 40K M2	32	LED	RECESSED	2X4' LED SWITCHABLE LUMEN PANEL
Α				4000K		SET TO 4000 LUMENS, WHITE FINISH
						,
	LITHONIA	CPANL 2X4 40/50/60LM 40K M2	32	LED	RECESSED	2X4' LED SWITCHABLE LUMEN PANEL
ΑE		PS1055CP FMC EMI		4000K		SET TO 4000 LUMENS, WHITE FINISH
/ _						EMERGENCY POWER BATTERY PACK
	LITHOINA	CPANL 2X4 40/50/60LM 40K M2	42	LED	RECESSED	2X4' LED SWITCHABLE LUMEN PANEL
В				4000K		SET TO 5000 LUMENS, WHITE FINISH
	LITHOINA	CPANL 2X4 40/50/60LM 40K M2	42	LED	RECESSED	2X4' LED SWITCHABLE LUMEN PANEL
BE		PS1055CP FMC EMI		4000K		SET TO 5000 LUMENS, WHITE FINISH
						EMERGENCY POWER BATTERY PACK
	LITHOINA	CPANL 2X4 40/50/60LM 40K M2	52	LED	RECESSED	2X4' LED SWITCHABLE LUMEN PANEL
С				4000K		SET TO 6000 LUMENS, WHITE FINISH
CE	LITHOINA	CPANL 2X4 40/50/60LM 40K M2	52	LED	RECESSED	2X4' LED SWITCHABLE LUMEN PANEL
		PS1055CP FMC EMI		4000K		SET TO 6000 LUMENS, WHITE FINISH
						EMERGENCY POWER BATTERY PACK
D	LITHOINA	TZL1N-L96-14000LM-FST-MVOLT-40K-90CRI-WH-ZACVH	104	LED	SUSPENDED	96" LED STRIPLIGHT, 14,000 LUMENS
				4000K		FROSTED DIFFUSER, AIRCRAFT HANGING CABLE
						WHITE FINISH
DE	LITHOINA	TZL1N-L96-14000LM-FST-MVOLT-40K-90CRI-E7W-WH-ZACVH	104	LED	SUSPENDED	96" LED STRIPLIGHT, 14,000 LUMENS
				4000K		FROSTED DIFFUSER, AIRCRAFT HANGING CABLE
						WHITE FINISH, EMERGENCY BATTERY PACK 7W
	LITHOINA	ECBG LED M6	2.32	LED	SURFACE	INTEGRATED EXIT SIGN/ UNIT COMBO
Е						GREEN EXIT SIGN
						INTEGRATED LED LIGHT BAR
	LITHOINA	ZL1N-L48-7000LM-FST-MVOLT-40K-90CRI-WH-ZACVH	52	LED	SUSPENDED	48" LED STRIPLIGHT, 7,000 LUMENS
F				4000K		PROVIDE AIRCRAFT HANGING CABLE AS NEEDED
						WHITE FINISH
FE	LITHOINA	ZL1N-L48-7000LM-FST-MVOLT-40K-90CRI-E7W-WH-ZACVH	52	LED	SUSPENDED	48" LED STRIPLIGHT, 7,000 LUMENS
				4000K	AND SURFACE	PROVIDE AIRCRAFT HANGING CABLE AS NEEDED
						WHITE FINISH, EMERGENCY BATTERY PACK 7W
X1	LITHONIA	WPX1LED1-40K-MVOLT-DDBXD	11	LED	SURFACE	EXTERIOR LED WALL PACK, 1537 LUMENS
				4000K		1537 LUMENS, 4000K
						DARK BRONZE
X1E	LITHONIA	WPX1LED1-40K-MVOLT-E4WH-DDBXD	11	LED	SURFACE	EXTERIOR LED WALL PACK, 1537 LUMENS
				4000K		1537 LUMENS, 4000K
						DARK BRONZE, BATTERY PACK

FIXTURE SCHEDULE

— · — · — · — O—10 DIMMING LINE VOLTAGE LIGHTING CONDUCTORS AND 0-10V (GREY, PURPLE) DIMMING CONDUCTORS

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