

DPW 2021605 IDVS CEMETERY PROJECTS, BLACKFOOT: STORAGE BUILDING

BLACKFOOT, IDAHO

Attention Building Inspector: Ensure that all deferred submittal items have been submitted to and approved by the DOPL Building Department prior to performing any inspections.

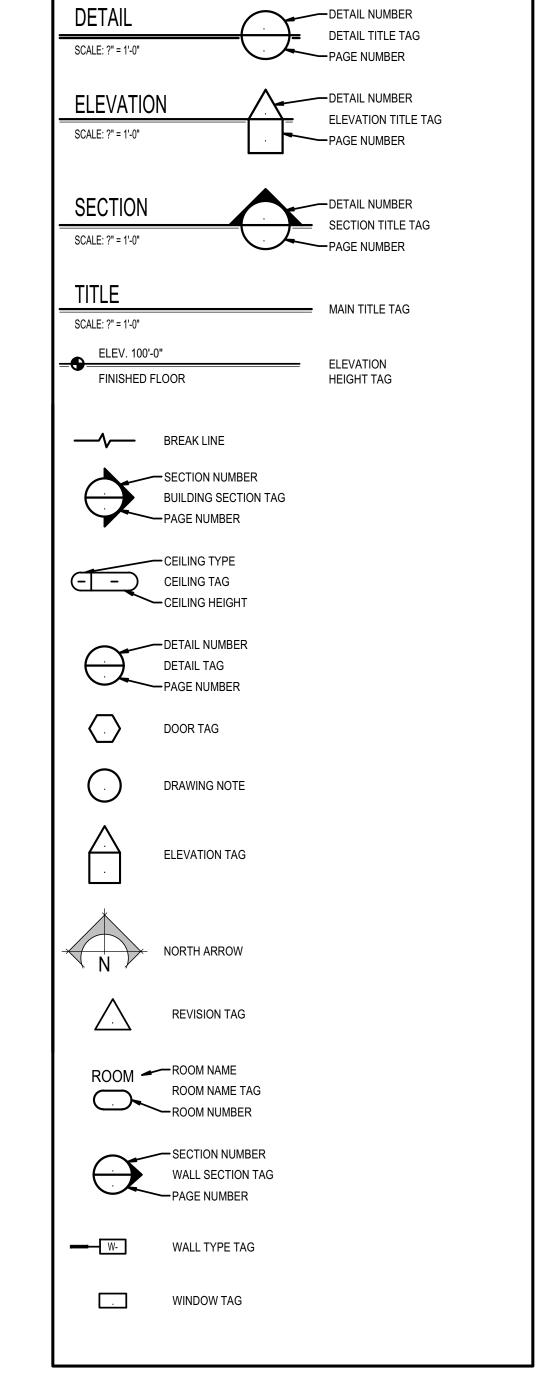

SYMBOLS LEGEND

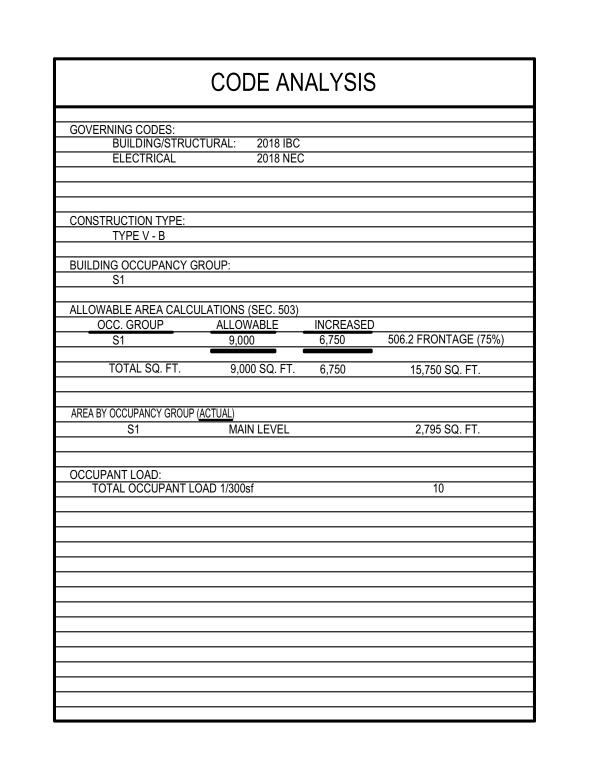

CONSULTANTS				Agency Construction Approval			
		100217 (1110					
				CONSTRUCTION APPROVAL BY RESPONSIBLE CHIEF OFFICER OF INSTITUTION OR AGENCY			
ELECTRICAL ENGINEER: MUSGROVE ENGINEERING 645 WEST 25th STREET			(IDAHO CODE 67-5710)				
		IDAHO FALLS, ID. 83402 TELEPHONE: (208) 523-2862		This is to indicate that I or my delegated staff have reviewed the final plans and specifications for: 2021605 IDVS: Cemetery Projects, Blackfoot			
			DPW Project No. 2021605				
				This project incorporates the required program elements within the funding limitations authorized, and authorize the Division of Public Works to proceed with bidding of the project. If acceptable bids are received, I will approve awarding a contract and construction of the facilities in accordance with the plans and specifications.			
				Agency:			
				Agency Signature Authority:			
DRAWING INDEX				Approval Approved	Due: 11-Jun-2021		
GENERAL				Name or Role	Status	Actions	
S1.0 TITLE SHEET AND INDEX				1 Agency -	Approved		
SITE				Signature Authority	Debbie Spence 02-Jun-2021		
S1.0 N	MAINTENANCE COMPOL	JND SITE PLAN			08:29 AM MST		
ARCHITECTURAL				2 Project Manager	Approved Martin Santoyo 04-Jun-2021	Comments: Section 7 4113.16, 1.7 State of Idaho warranty forms are not attached. Also, in section B, change warranty period from 5 years to 20 years.	
.1.0 F	FLOOR PLANS, ELEVATION	ONS AND BUILDING SECTIONS			08:53 AM MST		
				3 Project Manager Senior	Approved Margie Kennedy (SR PM) 04-Jun-2021		
ELECTRICAL					09:10 AM MST		
0.0 ELECTRICAL COVER SHEET			4 DPW Administrator	Approved Pat Donaldson			
1.0 E	ELECTRICAL PLANS				04-Jun-2021 10:43 AM MST		
2.0 E	ELECTRICAL COMCHEC	K					

ELECTRICAL DETAILS

80 The deferred submittal items shall be submitted by the contractor to the DOPL Building Department for plan review and approval prior to recieving a building permit. **DEFERRED SUBMITTAL ACTIONS:** CEME THIS NEEDS TO INCLUDE AT LEAST THE FOLLOWING: THE ENGINEERED DESIGN FOR THE STEEL BUILDING INCLUDING ANY REQUIREMENTS FOR A mezzanine is not approved for this project. SPECIAL INSPECTION OF THE HIGH STRENGTH BOLTING. THE ENGINEERED DESIGN FOR THE FOUNDATION INCLUDING A STATEMENT OF SPECIAL INSPECTIONS. DATE: BLD2104-00057 REVIEWED FOR CODE COMPLIANCE This approval shall not be construed to be an approval of any violation of, or variance from, Idaho's adopted codes, standards,

laws or rules applicable to this project.

REQUIRED FOR CONSTRUCTION


IIII DDW architects DARE PLANNING ZINTER

(

REVISIONS

PROJECT NO.: NBW 20026

FEB 2021 DRAWN BY: CGK CHECKED BY: DRAWING NO.:

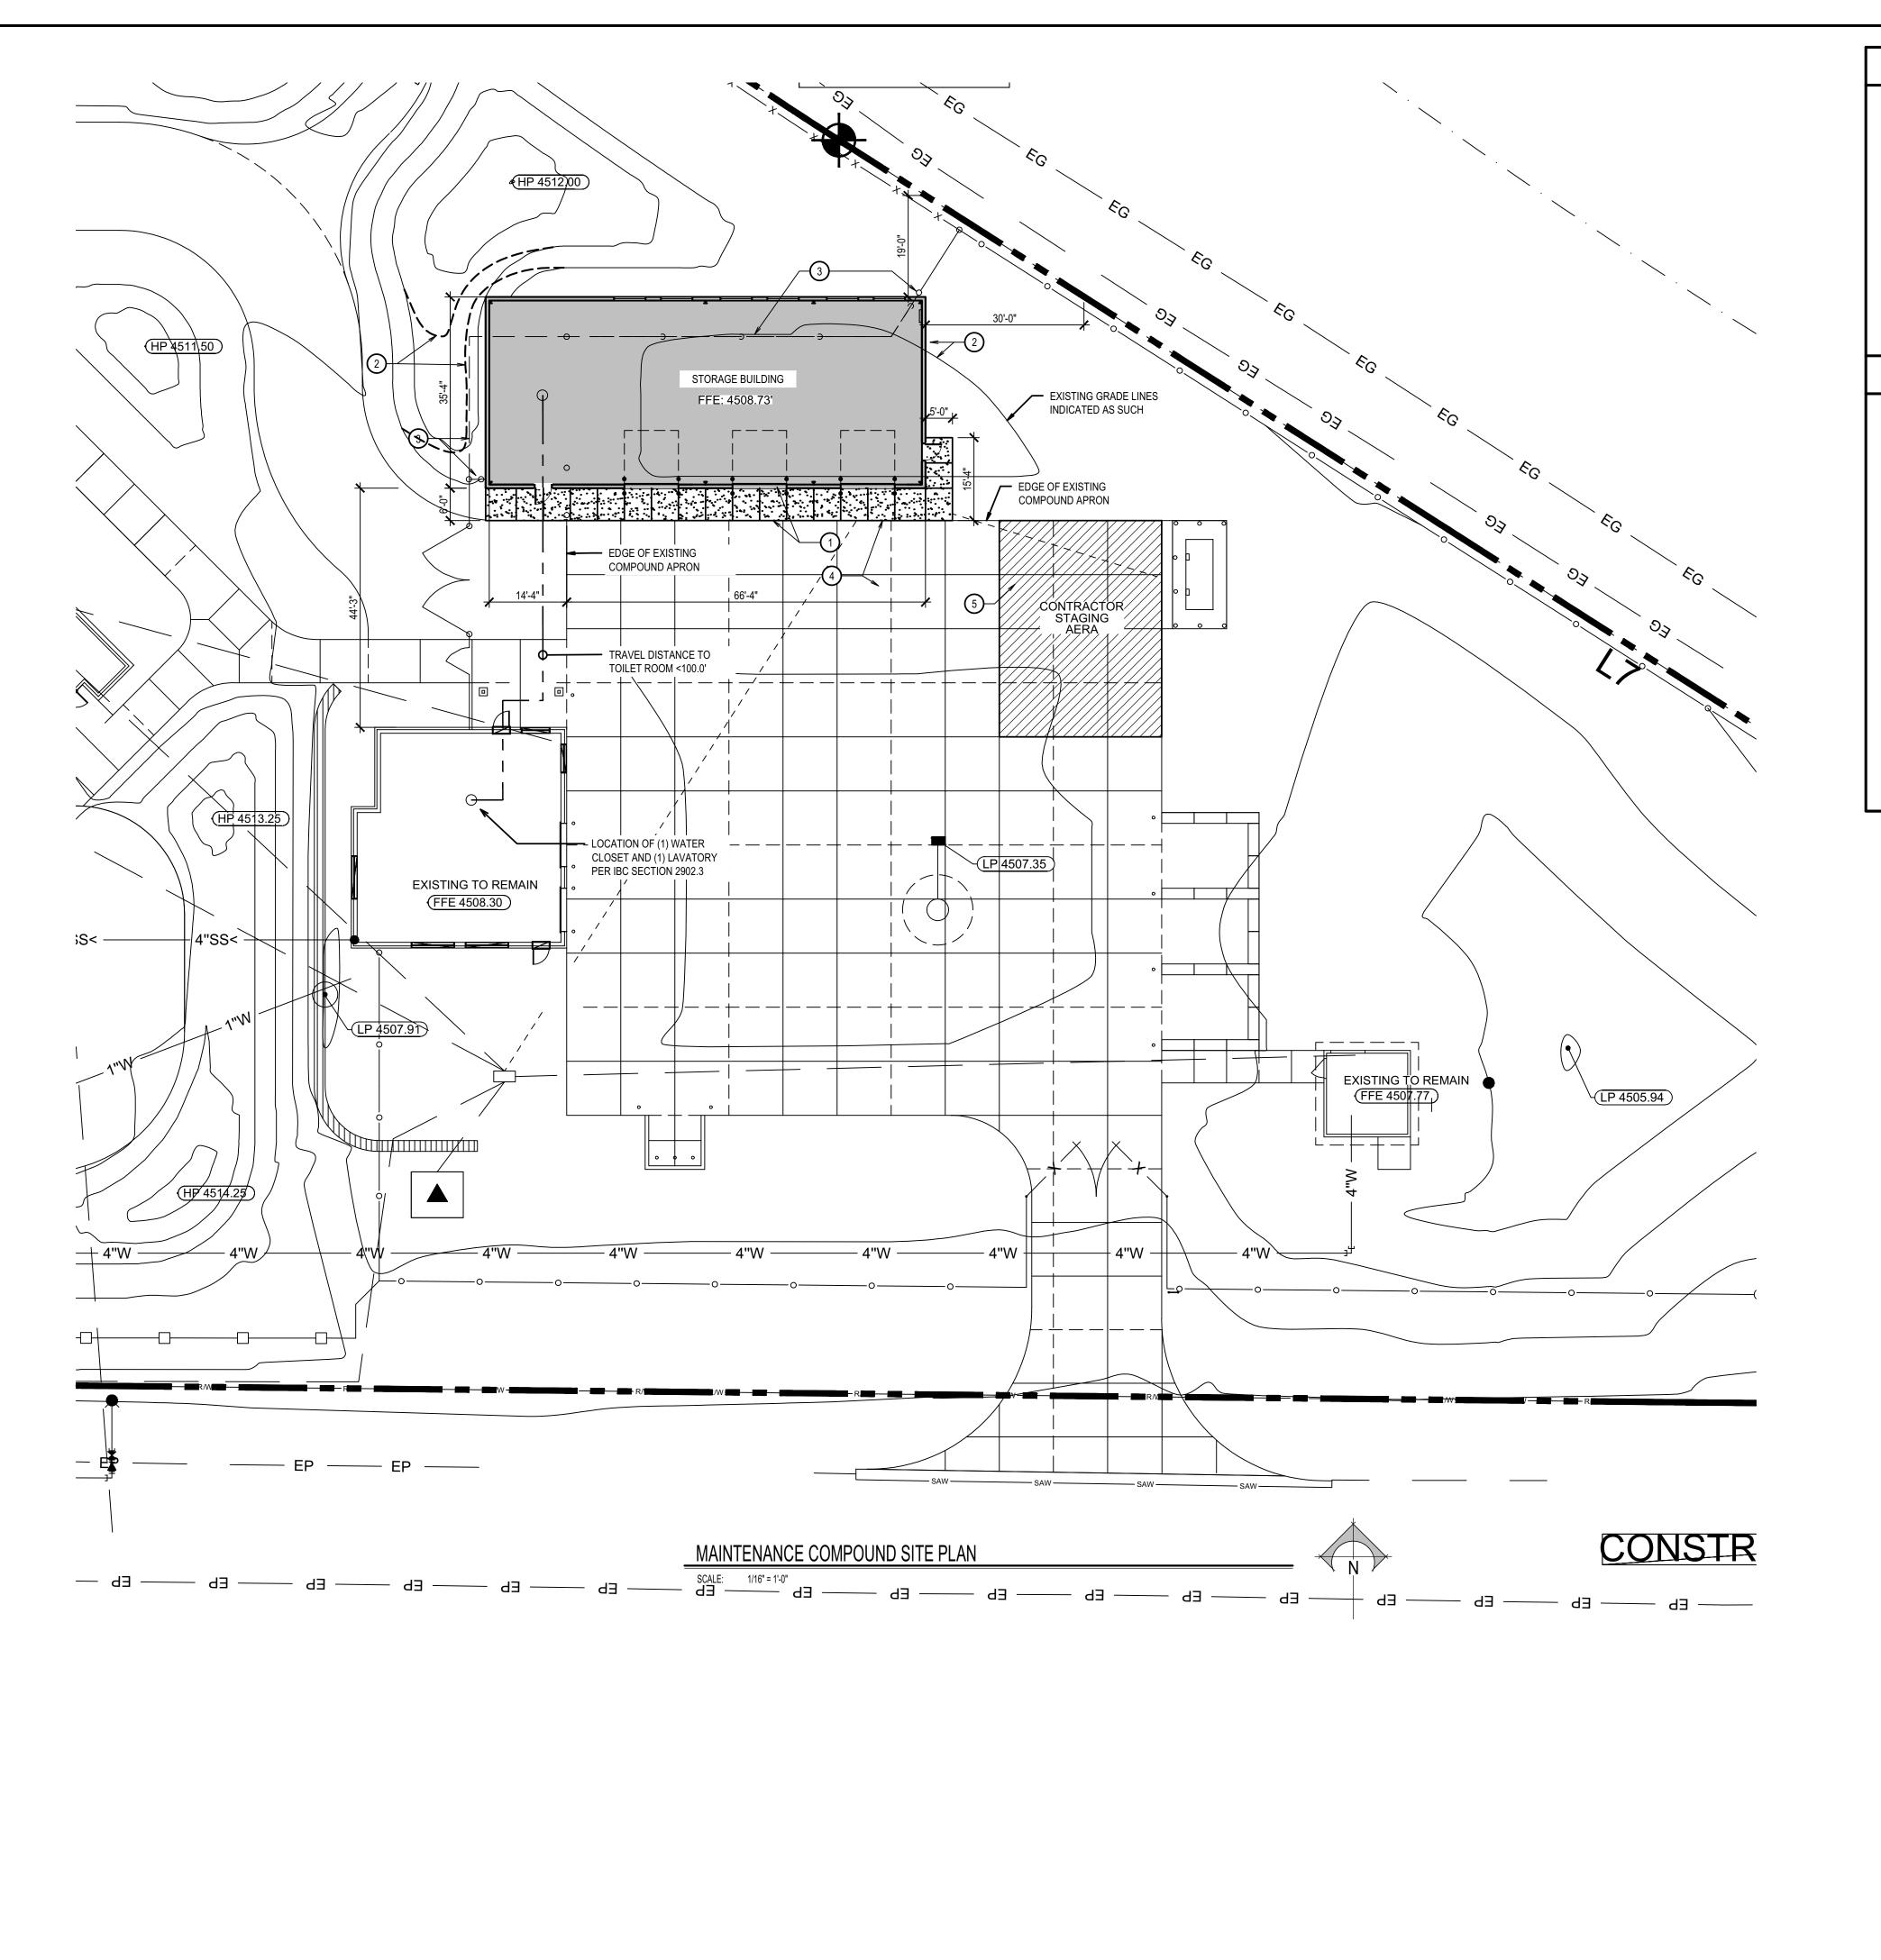

GENERAL NOTES

- WORK TO BE IN ACCORDANCE WITH ALL CODES AND ACCESSIBILI
- REQUIREMENTS.
- CONTRACTOR TO VERIFY ALL DIMENSIONS IN FIELD.
- CONTRACTOR SHALL REPLACE OR REPAIR ALL OWNER PROPERTY DAMAGED AS A RESULT OF NEW CONSTRUCTION. THE DRAWING SET IS INTENDED AS A BASIS OF DESIGN. THE
- INFORMATION CONTAINED WITHIN IS INTENDED AS THE GENERAL CRITERIA FOR THE DESIGN.
- ALL MAN DOOR LANDINGS SHALL COMPLY WITH ADA REQUIREMENTS FOR SLOPE.

KEYNOTES

- 6" CONCRETE APRON WITH #4 REBAR @ 24"o.c. EACH WAY. SLOPE FROM FINISHED FLOOR ELEVATION TO EXISTING CONCRETE DRIVE ELEVATIONS. GRADE PERIMETER OF BUILDING CONSTRUCTION EXCAVATION TO MATCH EXISTING GRADES. REPAIR EXISTING LANDSCAPE IRRIGATION AND LANDSCAPE LAWN.
- DEMOLISH PORTION OF EXISTING CHAIN LINK FENCE TO ACCOMMODATE NEW BUILDING CONSTRUCTION. SECURE FENCE ENDS ADJACENT TO NEW BUILDING AS REQUIRED.
- 4. EXISTING CONCRETE DRIVE TO REMAIN.
- 5. CONTRACTOR STAGING AREA.

DING

STORAGE
1-605
, IDAHO

CEMETERY PROJECTS: S'
DPW 2021605 ID'
DPW 2021-605
BLACKFOOT, IDA

PROJECT NO.: NBW 20026 DATE: FEB 2021 DRAWN BY: ???

CHECKED BY:

DRAWING NO.:


BLD2104-00057


REVIEWED FOR CODE COMPLIANCE


This approval shall not be construed to be an approval of any violation of, or variance from, Idaho's adopted codes, standards,


laws or rules applicable to this project.

SEPARATE BUILDING PERMIT REQUIRED FOR CONSTRUCTION

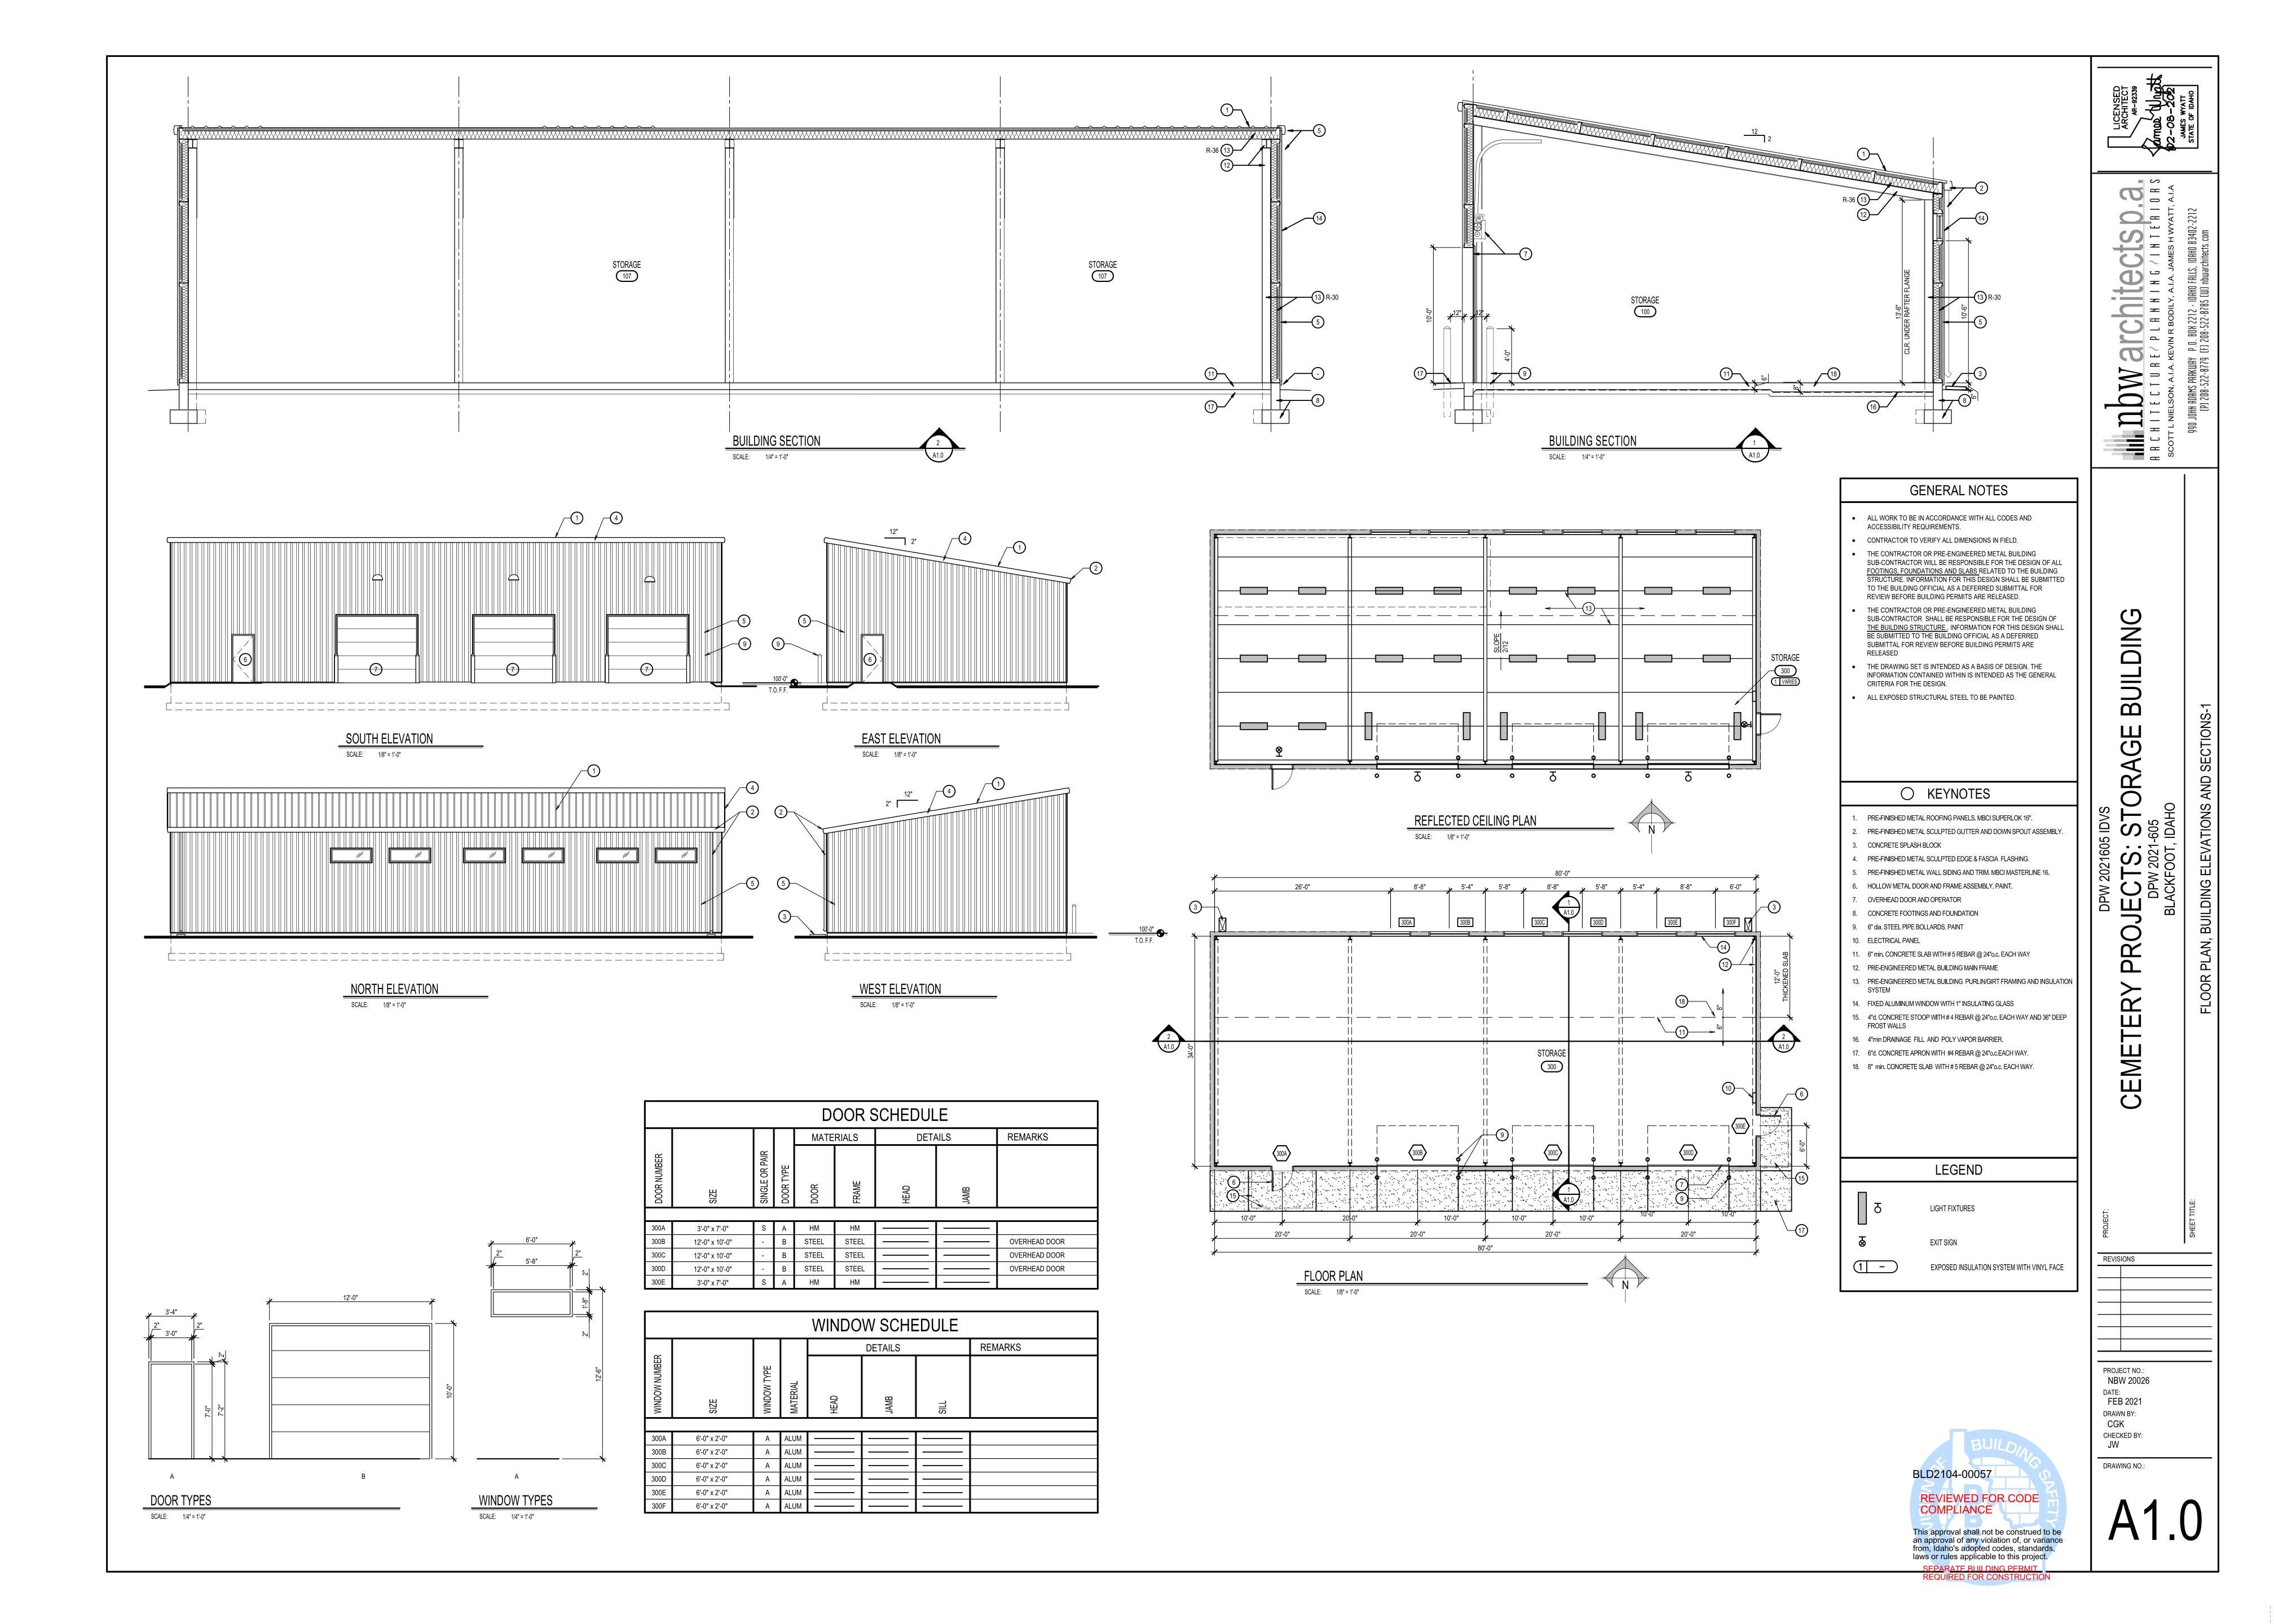

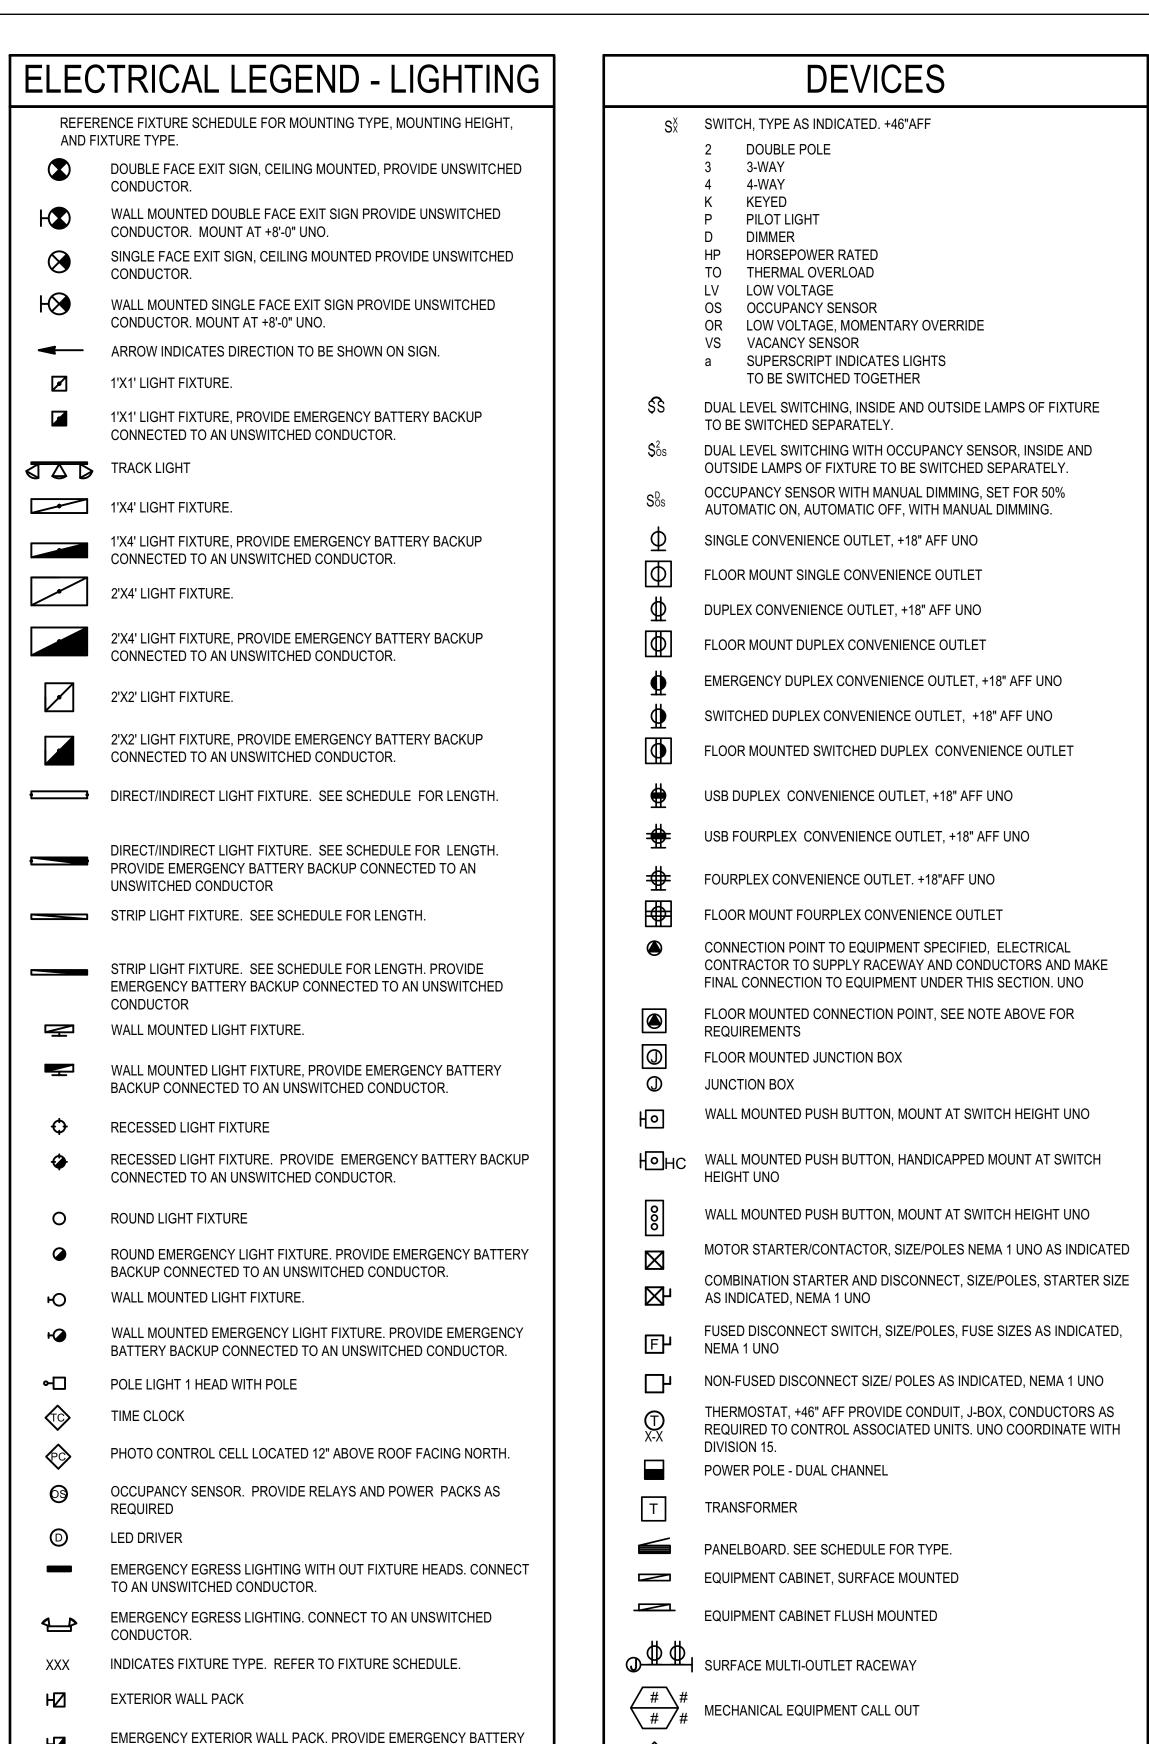

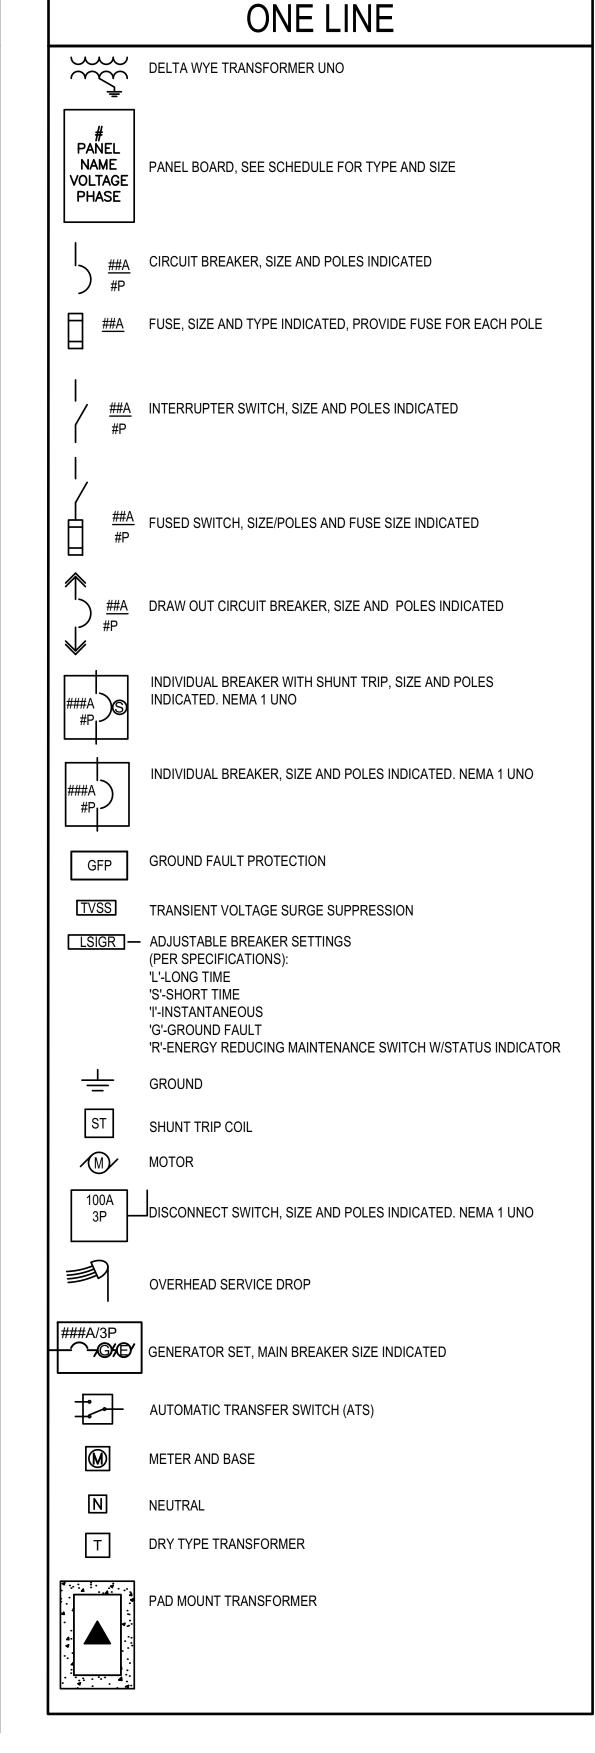

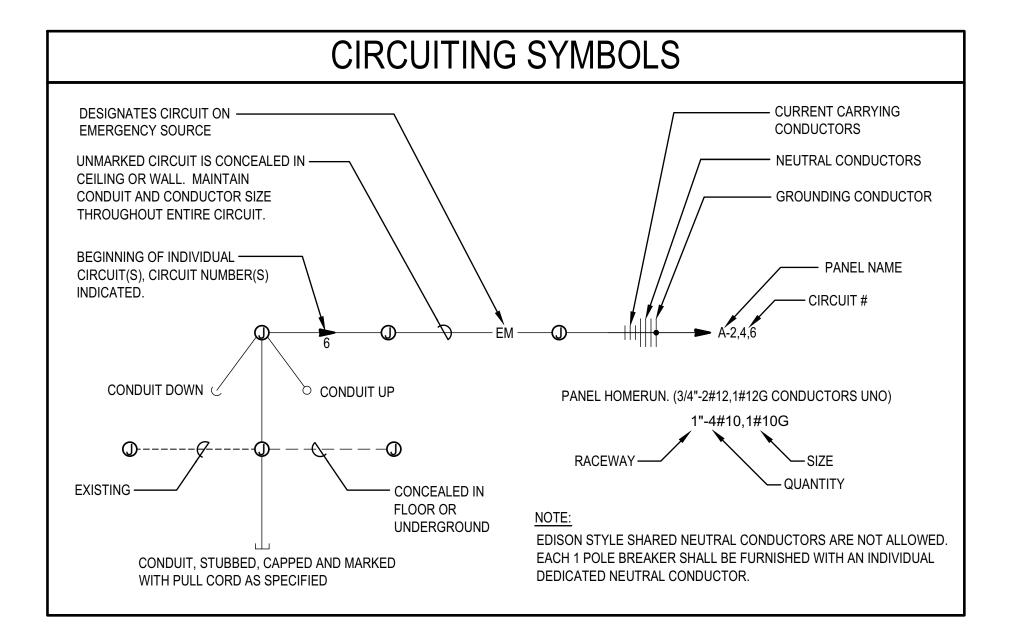

KITCHEN EQUIPMENT CALLOUT

BACKUP CONNECTED TO AN UNSWITCHED CONDUCTOR

ELECTRICAL ABBREVIATIONS

- AMPERES
- 6" ABOVE BACKSPLASH ABOVE FINISHED FLOOR
- AFG ABOVE FINISHED GRADE
 - AMPS INTERRUPTING CAPACITY
 - AUTOMATIC TRANSFER SWITCH AMERICAN WIRE GAUGE
 - BOTTOM OF DECK BOTTOM OF STRUCTURE
 - CEILING MOUNTED
 - CIRCUIT BREAKER
 - COMPACT FLUORESCENT
 - CKT CIRCUIT
 - CONDUIT ONLY, PROVIDE PULL-LINE CURRENT TRANSFORMER

CONTROL

- DIRECT CURRENT DEMOLITION
- DEMO DET DTT DEMOLITION
- DOUBLE TWIN TUBE
- **EXISTING**
- **ELECTRICAL CONTRACTOR** EMERGENCY LIGHT
- FUTURE FACP FIRE ALARM CONTROL PANEL
- GROUND FAULT CIRCUIT INTERRUPTER
- GROUND FAULT INTERRUPTER HAND HOLE
- HIGH INTENSITY DISCHARGE HAND-OFF-AUTO HIGH PRESSURE SODIUM
- HVAC HEATING, VENTILATION, & AIR CONDITIONING
- ISOLATED GROUND IPCO IDAHO POWER COMPANY
- J-BOX JUNCTION BOX
- KILO VOLT-AMP KVA
- KW KILOWATT KWH KILOWATT HOUR
- LCP LIGHTING CONTROL PANEL
- MAIN BREAKER MAIN CIRCUIT BREAKER MOTOR CONTROL CENTER MAIN DISTRIBUTION PANEL

MOUNTING

- MAIN LUGS ONLY MODULAR METERING CENTER METAL HALIDE MAIN SWITCH BOARD
- NORMALLY CLOSED NATIONAL ELECTRICAL CODE NOT IN CONTRACT NIGHT LIGHT

NORMALLY OPEN

- NTS NOT TO SCALE OVERHEAD
- OCCUPANCY SENSOR
- PHOTO-CONTROL
- POLYVINYL CHLORIDE PWR POWER
- REFERENCE
- RECEPTACLE RELOCATED
- SQUARE FEET
- TO BE DETERMINED TIME DELAY RELAY
- TOE KICK TSP TWISTED SHIELDED PAIR
- TRT TRIPLE TUBE TTB TELEPHONE TERMINAL BOARD (TYP.) TYPICAL
- UNDERCABINET
- UG UNDERGROUND U.N.O. UNLESS NOTED OTHERWISE
- VA VOLT-AMPERE
- WG WIRE GUARD WP WEATHER PROOF/NEMA 3R
- PROVIDED/ PROVIDE AND INSTALL / PROVIDED AND PROVIDE BY INSTALLED BY / PROVIDE AND INSTALL INSTALLED/ INSTALL
 - THIS IS A STANDARD LIST OF COMMONLY USED ELECTRICAL ABBREVIATIONS. SOME OF THE ABBREVIATIONS SHOWN ABOVE MAY NOT BE USED IN THIS DRAWING PACKAGE.

ELECTRICAL GENERAL NOTES

- I. THESE ELECTRICAL DRAWINGS ARE DIAGRAMMATIC IN NATURE; THEREFORE, THE ELECTRICAL CONTRACTOR SHALL COORDINATE ALL ELECTRICAL EQUIPMENT AND DEVICE LOCATIONS WITH ARCHITECTURAL, MECHANICAL, AND PLUMBING DIVISIONS PRIOR TO ROUGH-IN. REFER TO AND COORDINATE WITH ARCHITECTURAL, MECHANICAL, AND PLUMBING DRAWINGS FOR ADDITIONAL WORK THAT IS REQUIRED BY THE ELECTRICAL CONTRACTOR.
- ALL CONDUIT AND JUNCTION BOXES ARE TO BE CONCEALED UNLESS LOCATED WITHIN DEDICATED ELECTRICAL OR MECHANICAL ROOMS. USE OF SURFACE MOUNTED RACEWAYS IN ALL OTHER SPACES MUST BE APPROVED BY THE ARCHITECT FOR EACH LOCATION. WHERE SURFACE RACEWAYS ARE APPROVED, UTILIZE WIREMOLD, OR APPROVED EQUAL, SURFACE MOUNTED RACEWAYS PAINTED TO MATCH SURROUNDING WALLS.
- REFER TO ARCHITECTURAL ELEVATIONS FOR OUTLET HEIGHTS WHERE THE SPECIFIC OUTLET HEIGHT IS NOT INDICATED. REFER TO THE ELECTRICAL LEGEND FOR THE DEFAULT OUTLET HEIGHT WHEN NOT INDICATED ON ELEVATIONS OR ON AT THE DEVICES.
- D. PROVIDE PULL-LINE IN ALL EMPTY CONDUITS.
- TERMINATE ALL LOW-VOLTAGE CONDUITS WITH INSULATED THROAT BUSHING.
- MECHANICAL EQUIPMENT INDICATED IS SHOWN IN AN APPROXIMATE LOCATION. COORDINATE EXACT LOCATION WITH MECHANICAL CONTRACTOR
- G. ALL NON-LOCKING, 120-V, 15 AND 20-AMP RECEPTACLES SHALL BE LISTED TAMPER-RESISTENT RECEPTACLES PER NEC 406.12

- H. CONTRACTOR SHALL COORDINATE WITH AN UNDERGROUND LOCATING SERVICE PRIOR TO COMMENCING WORK. SEE CIVIL DRAWINGS FOR ADDITIONAL SITE INFORMATION. COORDINATE WITH OTHER SITE DISCIPLINES.
- SITE LIGHTING AND UTILITY EQUIPMENT SHOWN IN APPROXIMATE LOCATION. COORDINATE EXACT LOCATION WITH CIVIL DRAWINGS, PROPERTY LINES, AND UTILITY COMPANIES PRIOR TO ROUGH-IN.
- REFER TO POLE BASE DETAIL FOR SITE LIGHTING POLE BASE REQUIREMENTS.
- K. ROUTE CONDUITS IN COMMON TRENCH WHERE POSSIBLE REFER TO TRENCHING DETAIL.

SHEET INDEX

E0.0 ELECTRICAL COVER SHEET E1.0 ELECTRICAL PLANS

E2.0 ELECTRICAL DETAILS

LEGEND IS GENERAL IN NATURE. NOT ALL OF THE SYMBOLS SHOWN ARE USED IN THIS PROJECT.

Electrical Plan Review: Approved with Conditions. The stamped documentation has been Reviewed for Compliance in accordance with the NEC as adopted by the State of Idaho by an Electrical Plan Review. This shall not be construed as an approval of any violation of, or variance from Idaho's adopted codes, laws, standards, or rules. Final approval will be based upon on-site electrical inspections to field verify compliance.





13299

= = >

9 5 IDVS
STORA(-605 IDAHO

D


REVISIONS

PROJECT NO.: NBW 20026 DATE: FEB 2021 DRAWN BY: DBH CHECKED BY: MNB

DRAWING NO.:

BLD2104-00057 REVIEWED FOR CODE COMPLIANCE This approval shall not be construed to be an approval of any violation of, or variance from, Idaho's adopted codes, standards, laws or rules applicable to this project.

REQUIRED FOR CONSTRUCTION

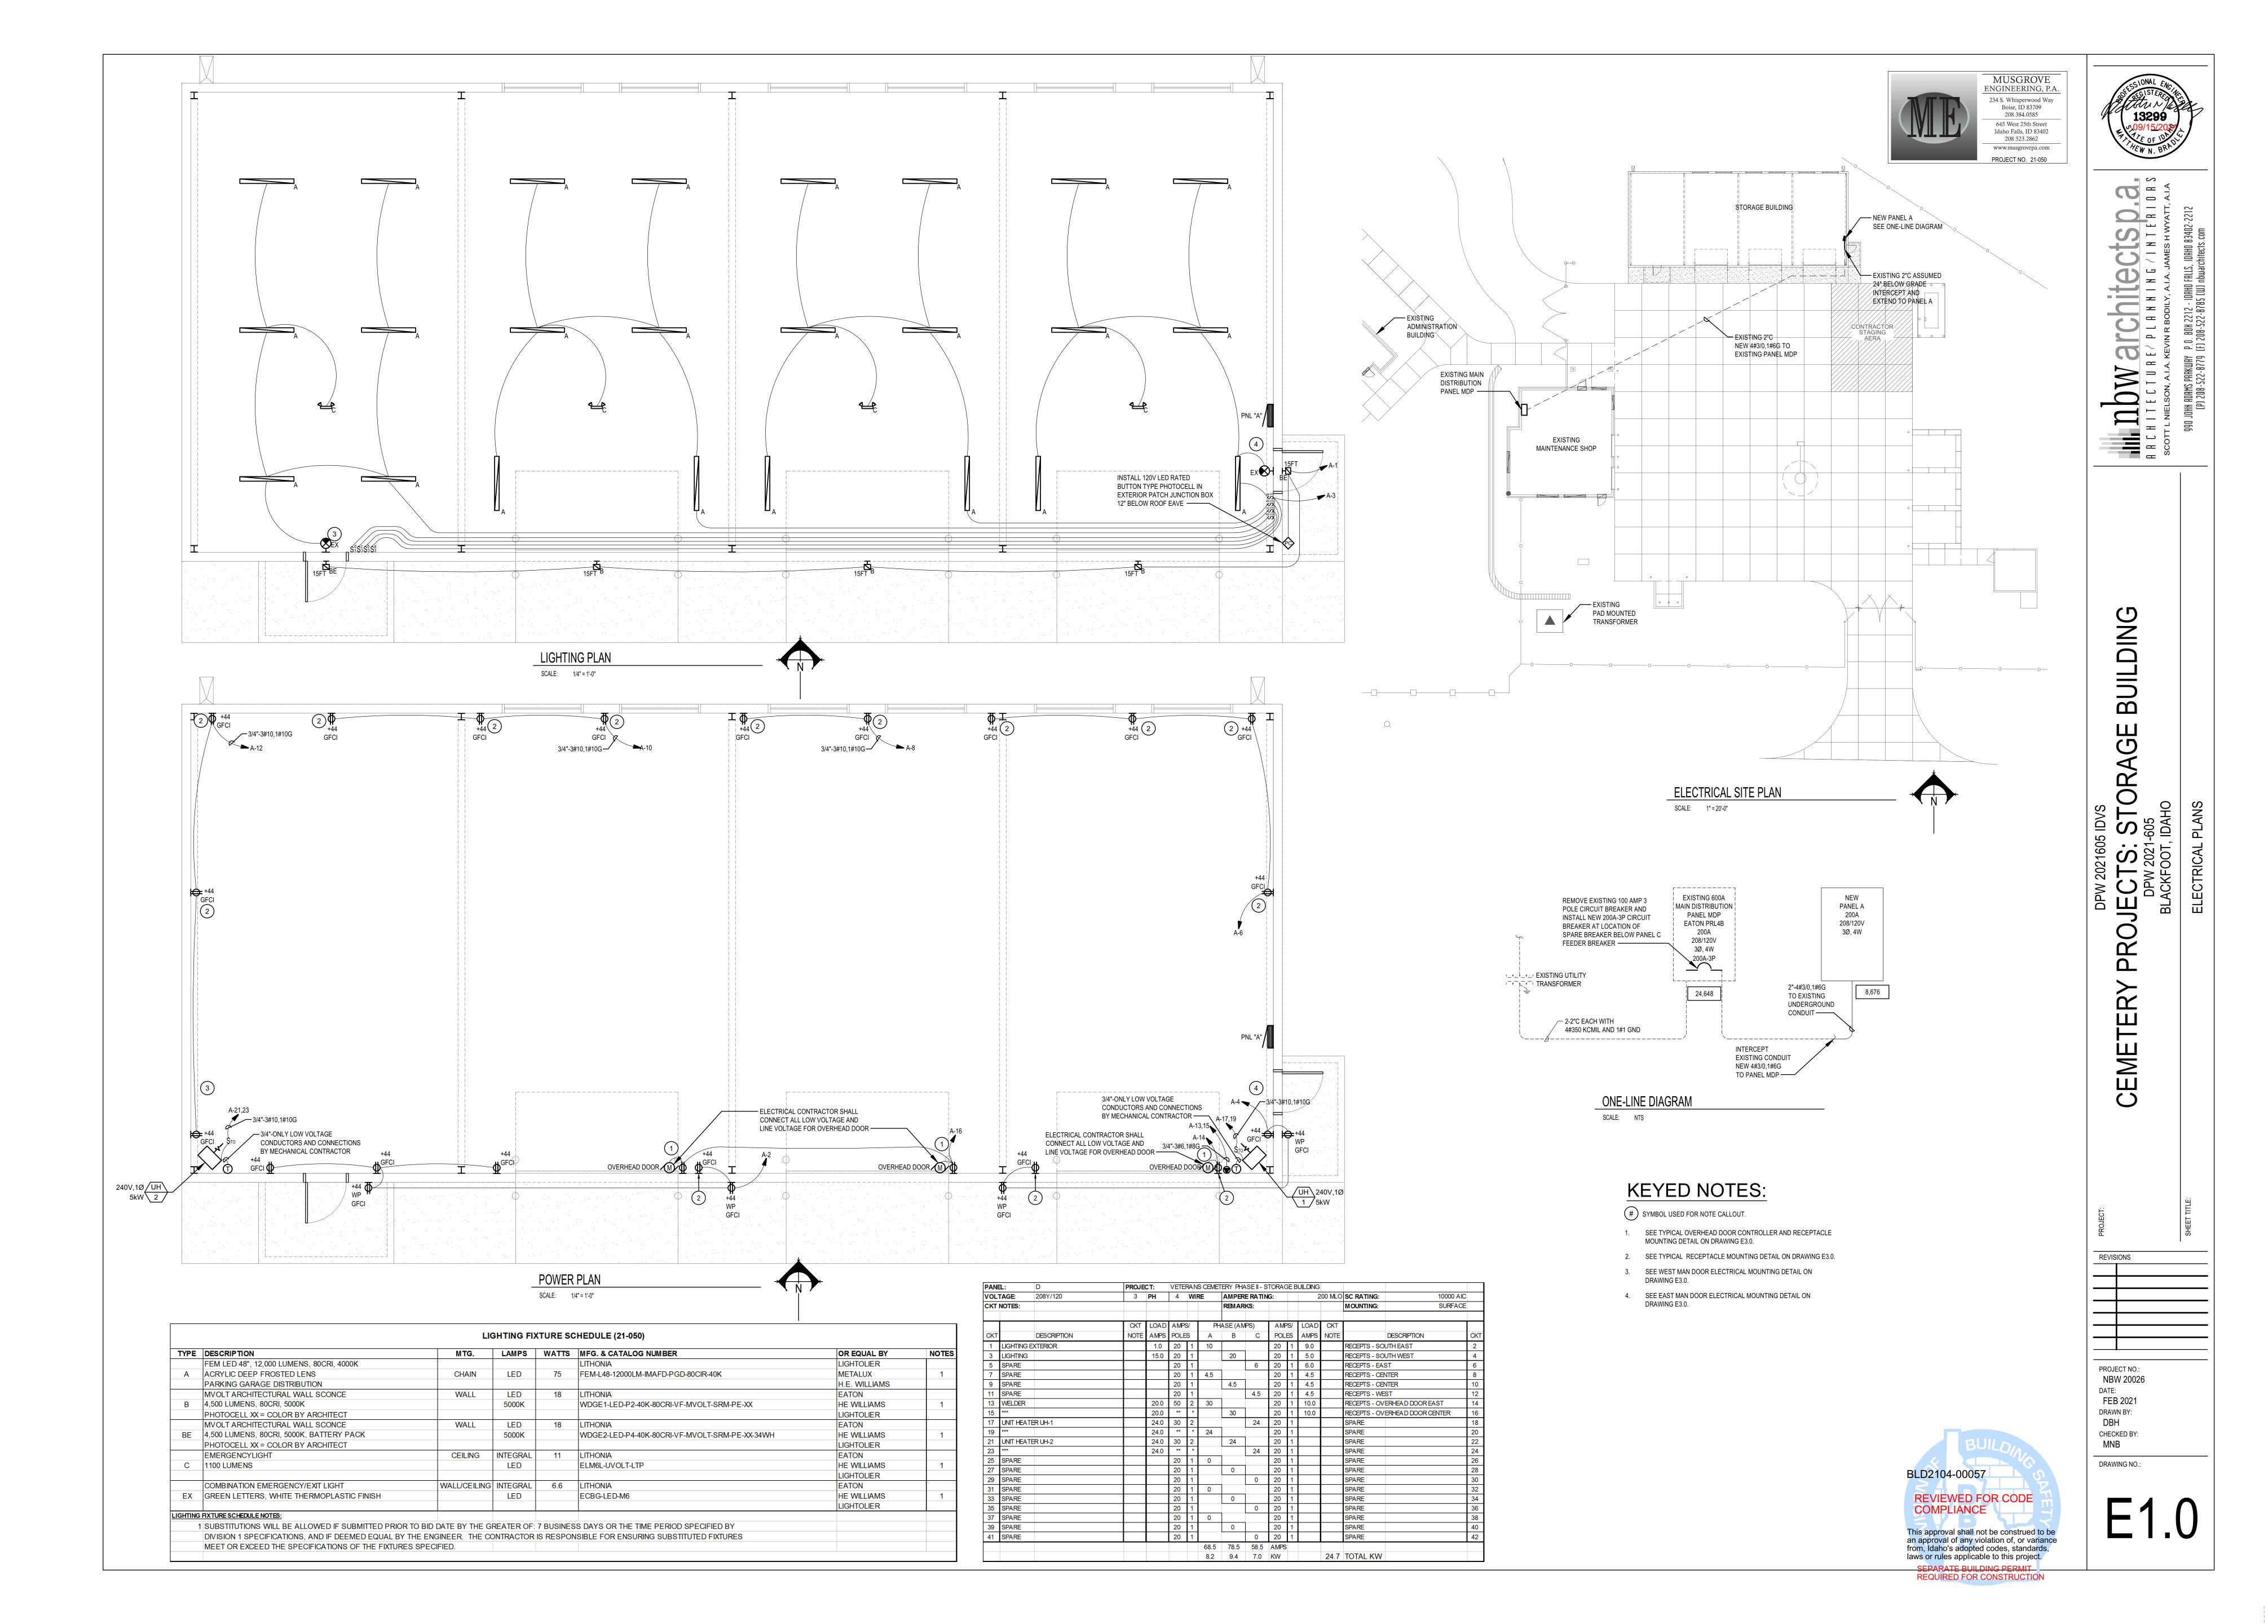








►MOUNT UNISTRUT SUPPORT TO I-BEAM WITH "L" BRACKET (TYPICAL) UNISTRUT SUPPORT SWITCHES MOUNTED TO UNISTRUT SUPPORT FRAME +44" AFF RECEPTACLE MOUNTED TO UNISTRUT SUPPORT FRAME +44" AFF

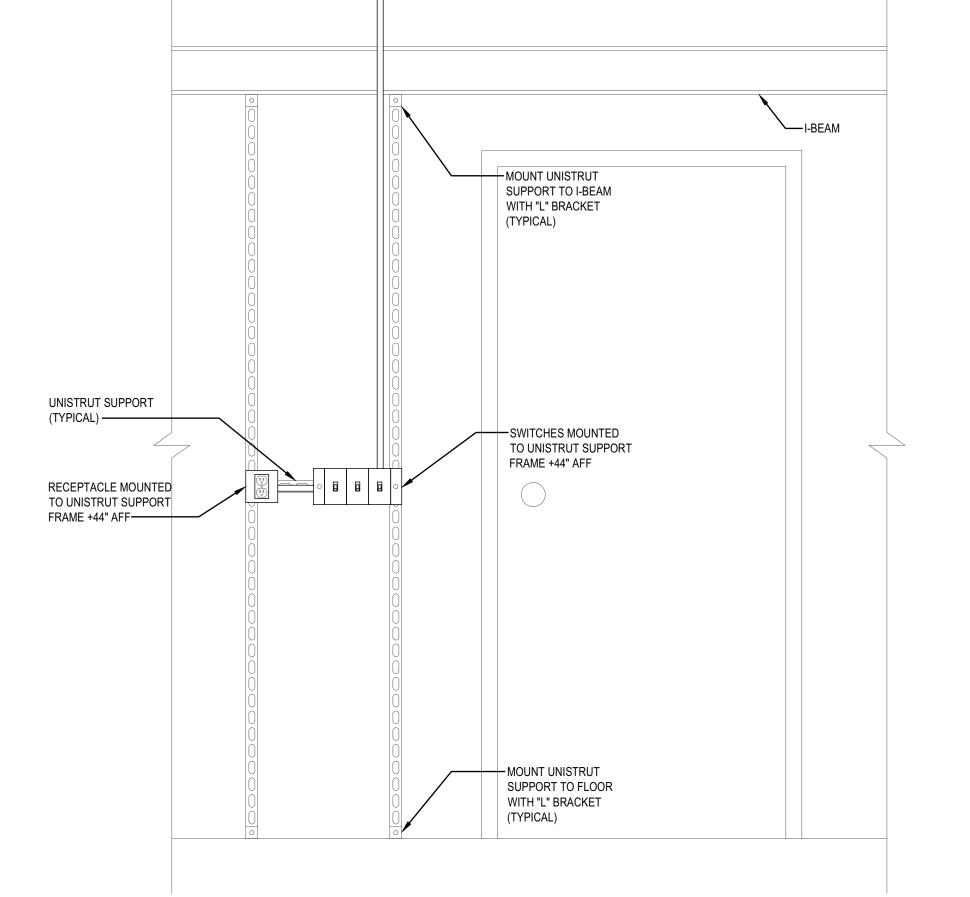

WEST WALL MAN DOOR ELECTRICAL MOUNTING DETAIL

EAST WALL MAN DOOR ELECTRICAL MOUNTING DETAIL

SCALE: 1" = 1'-0"

MOUNT UNISTRUT SUPPORT TO FLOOR


WITH "L" BRACKET

(TYPICAL)

— JUNCTION BOX MOUNTED TO I-BEAM MOUNT UNISTRUT SUPPORT TO I-BEAM WITH "L" BRACKET (TYPICAL) RECEPTACLE MOUNTED TO UNISTRUT SUPPORT +44" AFF (TYPICAL) TYPICAL MOUNTING FOR ALL SPECIALTY RECEPTACLES +44" AFF (TYPICAL) —UNISTRUT SUPPORT MOUNT UNISTRUT
SUPPORT TO FLOOR WITH "L" BRACKET

TYPICAL RECEPTACLE MOUNTING DETAIL

SCALE: 1" = 1'-0"

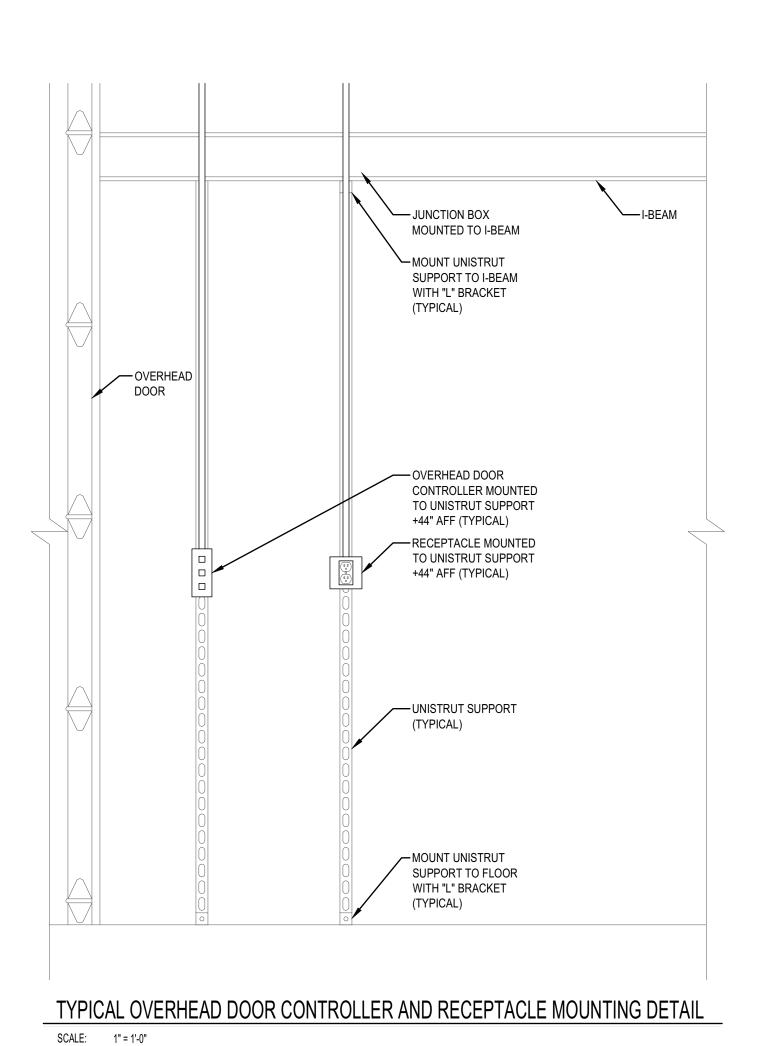

PANEL "A" MOUNTED TO UNISTRUT SUPPROT

> REVISIONS PROJECT NO.: NBW 20026 DATE: FEB 2021 DRAWN BY: DBH CHECKED BY: MNB DRAWING NO.: BLD2104-00057 REVIEWED FOR CODE COMPLIANCE This approval shall not be construed to be an approval of any violation of, or variance from, Idaho's adopted codes, standards, laws or rules applicable to this project.

SEPARATE BUILDING PERMIT REQUIRED FOR CONSTRUCTION

 \Box CEMETERY

ILDING