

ADDENDUM #1

Date: October 29, 2021

This Addendum applicable to work designated herein shall be understood to be and is an Addendum and as such shall be part of and included in the Contract.

To all bidders for furnishing all labor and materials necessary for:

DPW 21239 ISU: PULLING COURTS SIDING AND WINDOW REPLACEMENT POCATELLO, ID NBW#21001

Failure to acknowledge receipt of this Addendum on the bid proposal form may result in rejection of your bid.

Addendum consists of: 1 page. Attached Documents consist of – Pre-bid Conference Agenda, Pre-bid Conference Signup Sheet, Sheet G1.0, Sheet A1.0, Sheet A1.1, Sheet A1.2, Sheet A1.3, Sheet A2.1, Sheet A2.2

GENERAL ITEMS

1. The Pre-bid Conference Agenda and Signup Sheet are attached for your records.
2. The contractor is to remove all building signage and turn it over to the owner.
3. The project is to be phased such that work is occurring on no more than two buildings at a time.
4. The laydown area for materials has been identified and is to be located in the back parking lot – see attached satellite image.

ARCHITECTURAL ITEMS

1. Project Manual Section 01 1000 - Summary has been replaced – see attached.
2. The drawing index on Sheet G1.0 has been revised.
3. Sheet A1.0 has been added.
4. Sheet A1.1, A1.2 and A1.3 – Keynote 10 has been added.
5. Sheet A2.1 and A2.2 – Keynote 14 has been added.

END OF ADDENDUM NO.1

Pre-bid Conference

October 27, 2021 – 11:00am MST

DPW 21239 ISU Pulling Courts Siding and Window Replacement

Architect's Project Manager: Nick Hansen Phone – (208) 522-8779 Email – nrh@nbwarchitects.com	Project description: The work of this project can be summarized to include but is not limited to removing and replacing existing wood siding with vinyl siding. Also, to include the replacement of windows with aluminum clad wood double hung windows.	
DPW Project Manager Martin Santoyo Phone – (208) 332-1913	Idaho State University Representative Chris Baker Phone – (208) 282-4572 Email – chrisbaker@isu.edu	
DPW Field Rep. Fred Richards Phone – (208) 269-0639	Bid submission date and time: November 16 th , 2021 2:00 PM MST	Bid submission location: DPW Field Office, 611 Wilson Avenue, Suite 1, Pocatello, Idaho 83201
Building permit issued by: DBS	Construction Time: 150 Calendar Days	Liquidated damages/ day: \$250.00
Unusual conditions: There are COVID 19 protocols in place. Please reference Project Manual Section 01 1000 1.16. The buildings will be occupied during the entire length of construction. No work is to be performed on site during Finals week for both the Fall and Spring Semesters. Please reference Project Manual Section 01 1000 1.09. The phasing of this work is to be carefully coordinated with ISU.		

1. **Bidders List:**

a.

2. **Bidding Information:**

- a. The estimated cost of construction is \$500,000.00
- d. A Public Works Contractors License for the State of Idaho is required to bid on this work.

3. **Addenda:**

- a. All addenda will be issued by the Architect, by email, at least four (4) days prior to bid opening.
- b. All verbal agreements or instructions must be confirmed by written addenda.
- c. Contractors are to bid the contract documents. Review documents carefully. Additional payments to the Contractor will not be made for items shown or specified in documents.
- d. Requests for clarification shall be in writing and received by the architect ten (10) calendar days minimum prior to bid opening.



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4. **Bid Opening:**

- a. Sealed bids will be accepted up to the specified time. Bidding will be closed at the exact specified time. Bids will be opened and reviewed in a meeting following the time for receipt of bids.
- b. Bids are to be submitted as outlined in the Project Manual.
- c. The bid form used will be the form provided. Faxed bids are not acceptable.
- d. The Owner reserves the right to reject any or all bids and to waive any irregularity therein.
- e. If all addenda are not acknowledged by number (1,2,3, etc.), on the bid form or if the bid form is not signed, all blanks not filled in or otherwise improperly filled out, the bid will be considered non-responsive.
- f. The bid amount is to be listed in both written and numerical form. If there is a discrepancy between the two, the written amount will be used.

5. **Additional Items of Discussion:**

- a. No substitutions of materials or products not authorized by addendum.
- b. Proof of vaccination is not required to work on this project.
- c. For downloading documents: www.nbwarchitects.com
Click on "Current Bidding Projects"
- d. Contact NBW's office to be added to the bidders list.

6. **Questions**

7. **Meeting Notes:**

- a. The project is to be phased such that work is occurring on no more than two buildings at a time.
- b. A laydown area has been identified at the back of the back parking lot. This location will be highlighted in Addendum #1.
- c. The contractor is to remove all building signage and turn it over to the owner.

Pre-Bid Conference Sign-in Sheet

Project Name: DPW 21239 ISU Pulling Courts Siding and Window Replacement

In Attendance:	Company:	Contact:
1. Sean Whitworth	NUVU Glass	sean@nuvuglass.com 208-270-1191
2. MARTIN SANTOYO	DPW	martin.santoyo@adm.idaho.gov
3. Chris Baker	ISU	chrisbaker@isu.edu.com 208-540-1507
4. Matt Olsen	ISU Housing	olsematn@isu.edu 208380-0048
5. CRAIG THOMPSON	HOUSING	thomcra2@isu.edu 208-380-0985
6. Nick Hansen	NBW	nph@nbwarchitects.com
7.		
8.		
9.		
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11.		
12.		
13.		
14.		
15.		




ISU Cosmetology Center

LAY DOWN AREA



DPW 21239 ISU: PULLING COURTS SIDING AND WINDOW REPLACEMENT

756 S. 10TH AVE
POCATELLO, IDAHO 83201

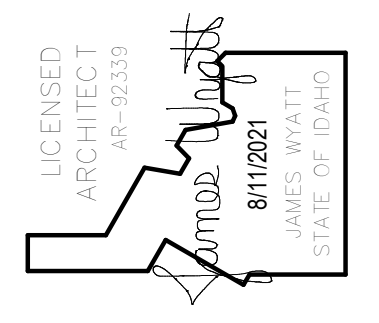

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900 JOHN BOHNS PARKWAY / P.O. BOX 2212 / IDAHO FALLS, IDAHO 83403-2212
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SYMBOLS LEGEND

<p>DETAIL NUMBER SECTION TITLE TAG PAGE NUMBER</p> <p>SCALE: 1/4" = 1'-0"</p> <p>DETAIL NUMBER DETAIL TITLE TAG PAGE NUMBER</p> <p>SCALE: 1/4" = 1'-0"</p> <p>DETAIL NUMBER INT. ELEV. TITLE TAG PAGE NUMBER</p> <p>SCALE: 1/4" = 1'-0"</p> <p>DETAIL NUMBER EXT. ELEV. TITLE TAG PAGE NUMBER</p> <p>SCALE: 1/4" = 1'-0"</p> <p>MAIN TITLE TAG SCALE: 1/4" = 1'-0"</p> <p>ELEVATION TAG ELEV. 100'-0" FINISHED FLOOR</p>	<p>BREAK LINE</p> <p>SECTION NUMBER SECTION TAG PAGE NUMBER</p> <p>DETAIL NUMBER DETAIL TAG PAGE NUMBER</p> <p>DETAIL NUMBER INTERIOR ELEV. TAG PAGE NUMBER</p> <p>ROOM ROOM NAME ROOM NAME TAG ROOM NUMBER</p> <p>NORTH ARROW</p>	<p>REVISION TAG</p> <p>CEILING TYPE CEILING TAG CEILING HEIGHT</p> <p>DOOR TYPE TAG</p> <p>SEE 3/A6.1 WINDOW TYPE TAG</p> <p>FLOOR TYPE TAG</p> <p>ROOF TYPE TAG</p> <p>STRUCTURAL MATERIAL TYPE - CSI DIVISIONS</p> <p>STRUCTURAL MATERIAL WIDTH</p> <p>WALL TYPE TAG</p> <p>WALL'S FIRE RATING IN HOURS</p> <p>UNIQUE WALL TYPE CONFIGURATION</p>
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ROOM FINISHES TAG

PLAN WEST WALL FINISH (W1, W2, W3, W4, W5, W6, W7, W8, W9, W10, W11, W12)

PLAN NORTH WALL FINISH (N1, N2, N3, N4, N5, N6, N7, N8, N9, N10, N11, N12)

PLAN SOUTH WALL FINISH (S1, S2, S3, S4, S5, S6, S7, S8, S9, S10, S11, S12)

PLAN EAST WALL FINISH (E1, E2, E3, E4, E5, E6, E7, E8, E9, E10, E11, E12)

FLOOR FINISH (F1, F2, F3, F4, F5, F6, F7, F8, F9, F10, F11, F12)

ADDITIONAL FINISH NOTES (A1, A2, A3, A4, A5, A6, A7, A8, A9, A10, A11, A12)


ABBREVIATIONS

#	- NUMBER OR POUND
&	- AND
A.F.F.	- ABOVE FINISH FLOOR
AL	- ALUMINUM
ALUM.	- ALUMINUM
B.O.	- BOTTOM OF
CMU	- CONCRETE MASONRY UNIT
CONC.	- CONCRETE
CONT.	- CONTINUOUS
DEMO.	- DEMOLITION OR DEMOLISH
DIAM.	- DIAMETER
DN	- DOWN
EA	- EACH
EIFS	- EXTERIOR INSULATION & FINISHING SYSTEM
ELEC.	- ELECTRICAL
ELEV.	- ELEVATION
EQ.	- EQUAL
EQUIP.	- EQUIPMENT
EXT.	- EXTERIOR
F.F.	- FINISH FLOOR
FRP	- FIBERGLASS REINFORCED PLASTIC
GA	- GAUGE
GYP.	- GYPSUM
H.M.	- HOLLOW METAL
HR	- HOUR
HVAC	- HEATING, VENTILATING, & AIR CONDITION
ID	- INSIDE DIAMETER
I.M.P.	- INSULATED METAL PANEL
INSUL	- INSULATION
INT.	- INTERIOR
MAX.	- MAXIMUM
MECH.	- MECHANICAL
MFR	- MANUFACTURER
MIN.	- MINIMUM
N.I.C.	- NOT IN CONTRACT
NO.	- NUMBER
O.C.	- ON CENTER
O.D.	- OUTSIDE DIAMETER
PLY	- PLYWOOD
PLUM.	- PLUMBING
PVC	- POLYVINYL CHLORIDE
RCP	- REFLECTED CEILING PLAN
REQ'D	- REQUIRED
SIM.	- SIMILAR
SPM	- SINGLE PLY MEMBRANE
STOR.	- STORAGE
STRUCT.	- STRUCTURAL
T.O.	- TOP OF
TYP.	- TYPICAL
U.N.O.	- UNLESS NOTED OTHERWISE
W	- WITH
W.C.	- WATER CLOSET
WD	- WOOD

DRAWING INDEX

GENERAL	
G1.0	GENERAL INFORMATION
ARCHITECTURAL	
A1.0	PHOTOS OF EXISTING CONDITIONS
A1.1	DEMOLITION PLANS BUILDINGS A & H
A1.2	DEMOLITION PLANS BUILDINGS B,C,D,E,F,G,I,J
A1.3	DEMOLITION ELEVATIONS
A2.1	FLOOR PLANS BUILDINGS A & H
A2.2	FLOOR PLANS BUILDINGS B,C,D,E,F,G,I,J
A3.1	BUILDING ELEVATIONS
A4.1	BUILDING SECTIONS
A5.1	DETAILS
A5.2	DETAILS
A6.1	WINDOW DETAILS

BUILDING CODE: IBC 2018

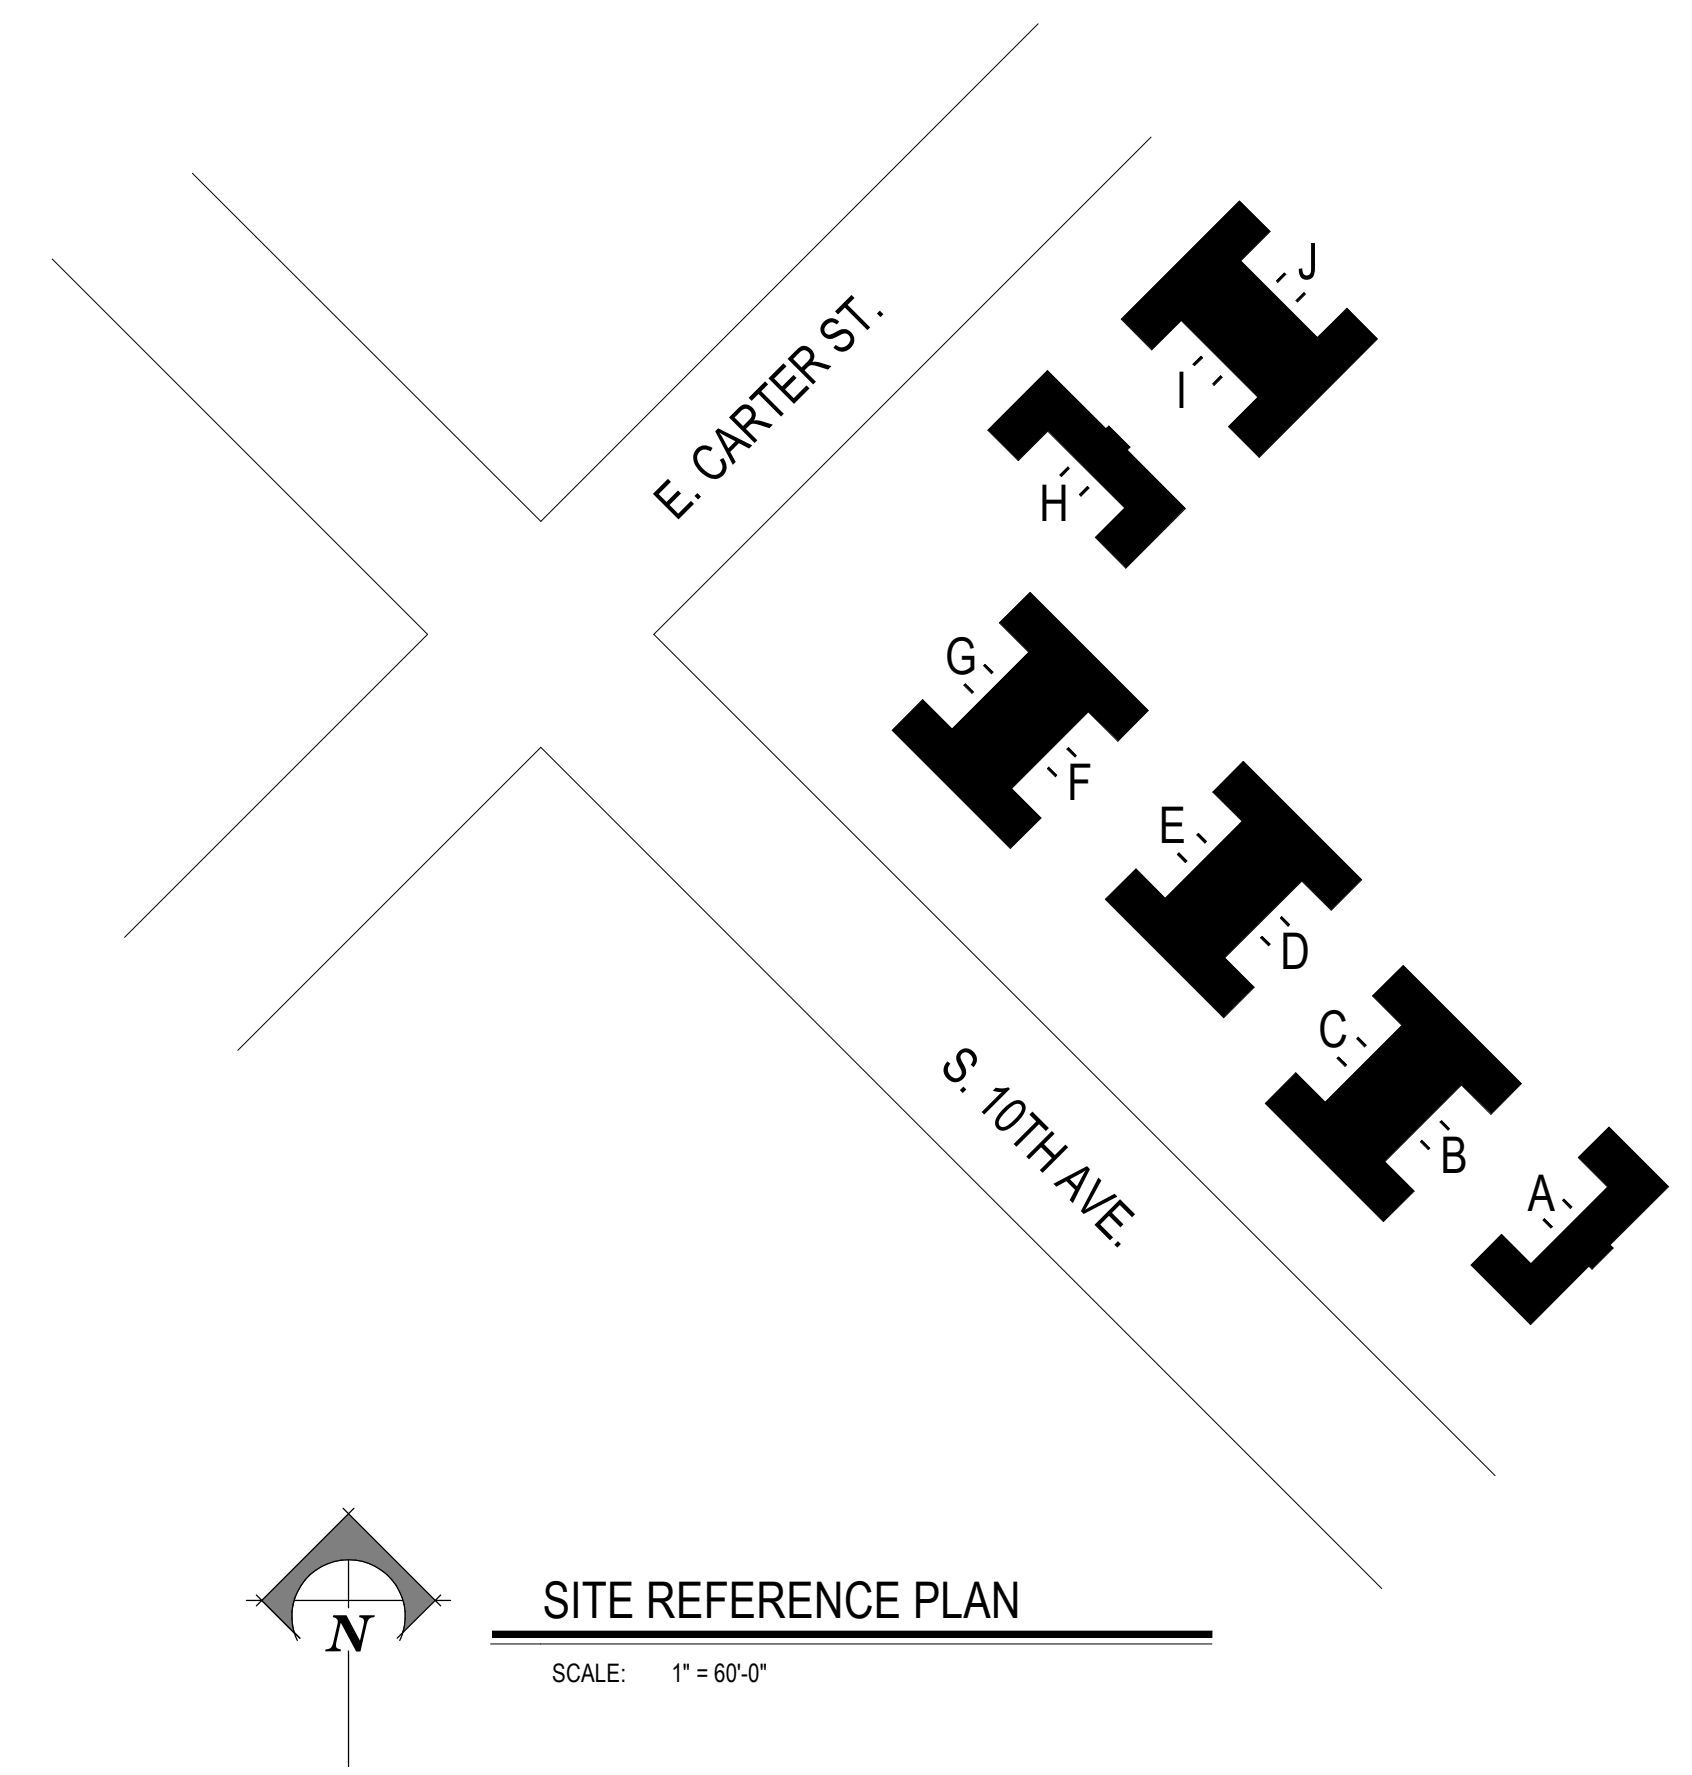

PROJECT: DPW 21239 ISU: PULLING COURTS SIDING AND WINDOW REPLACEMENT
756 S. 10TH AVE
POCATELLO, IDAHO 83201
SHEET TITLE: GENERAL INFORMATION

REVISIONS

#	ADDENDUM #	DATE
1		10-29-2021

PROJECT NO. 21001
DATE: AUGUST 2021
DRAWN BY: NBW
CHECKED BY: NBW

DRAWING NO.: AD #1

G1.0
REVISED 10-29-2021



STAIRS AND RAILING AT BUILDING H




TYPICAL BUILDING FRONT ELEVATION



BACK ELEVATION BUILDING A



TYPICAL WINDOW GYPSUM SURROUND

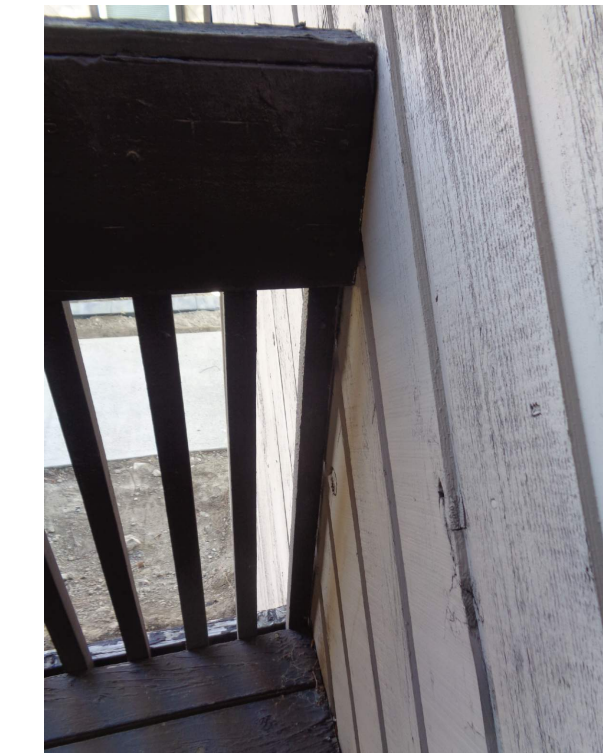

TYPICAL DECK RAILING TO WOOD SIDING CONNECTION



TYPICAL STAIR STRINGER TO WOOD SIDING CONNECTION



TYPICAL TOP OF DECK RAILING



TYPICAL UNDER DECK/BOTTOM OF RAILING CONNECTION



TYPICAL SCUPPER



ROOF AND SIDING TRANSITION BUILDINGS B AND C



ROOF AND SIDING TRANSITION BUILDINGS B AND C



TYPICAL PARAPET CORNER




ROOF AND SIDING TRANSITION BUILDING D




TYPICAL UTILITIES



TYPICAL UTILITIES

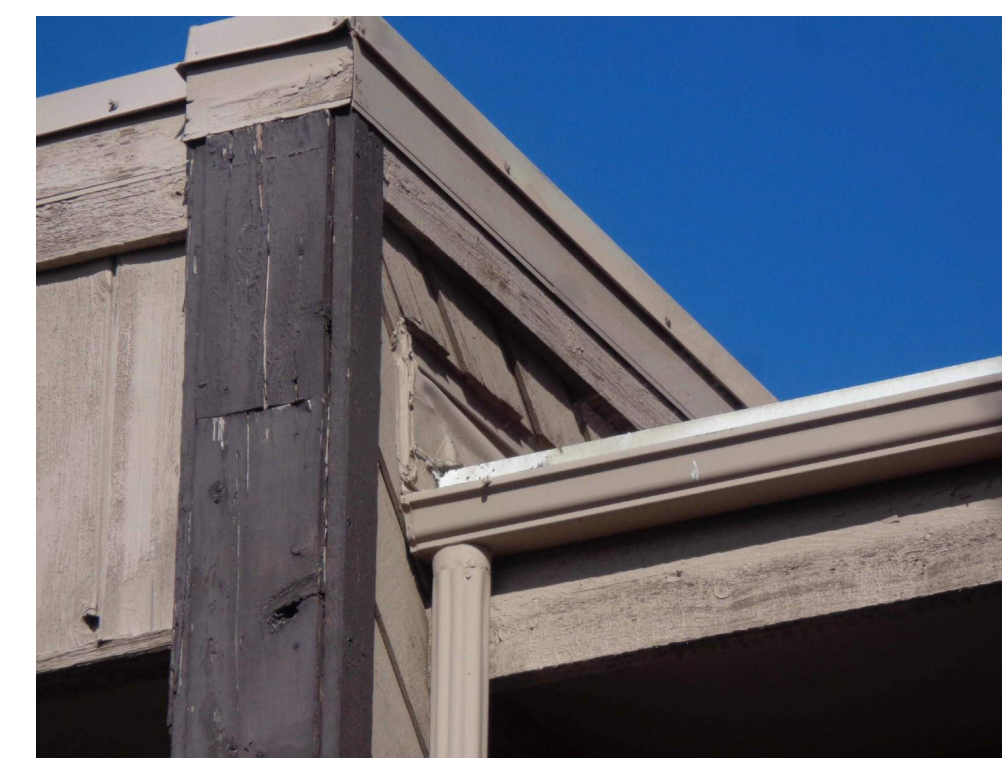

ROOF AND SIDING TRANSITION BUILDING B

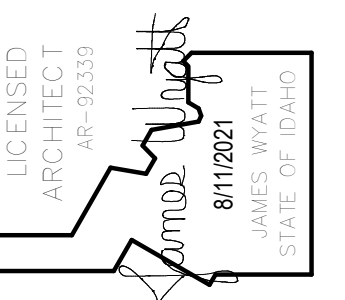


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PROJECT: DPW 21239 ISU: PULLING COURTS SIDING AND WINDOW REPLACEMENT
756 S. 10TH AVE
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SHEET TITLE: PHOTOS OF EXISTING CONDITIONS

REVISIONS		
1	ADDENDUM #1	10-29-2021


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MAIN LEVEL DEMOLITION PLAN

SCALE: 1/8" = 1'-0"

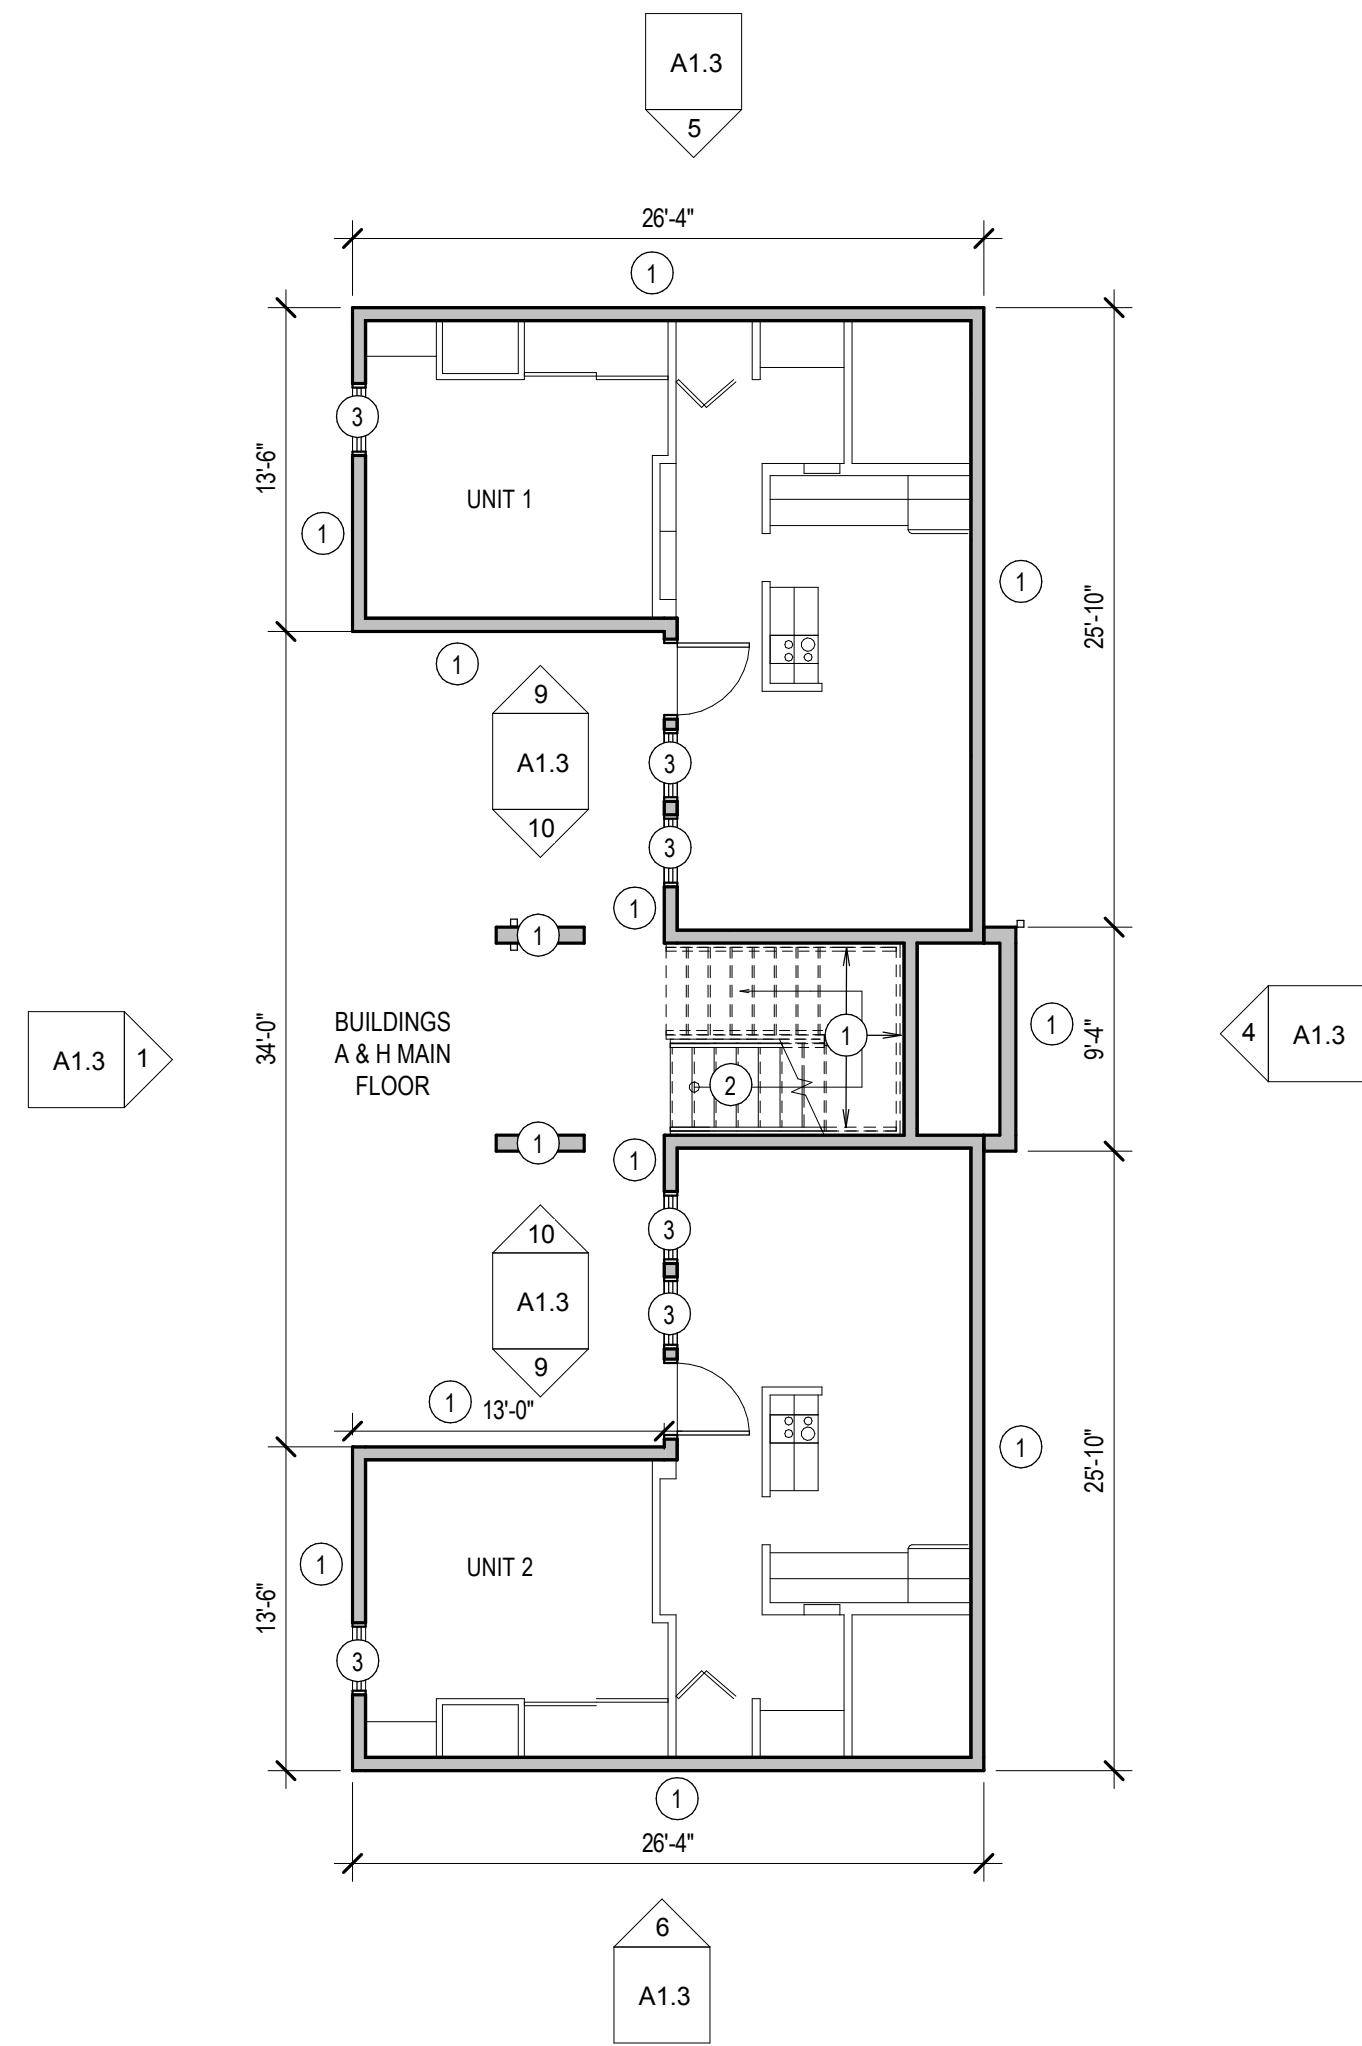

SECOND LEVEL DEMOLITION PLAN


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DEMOLITION GENERAL NOTES

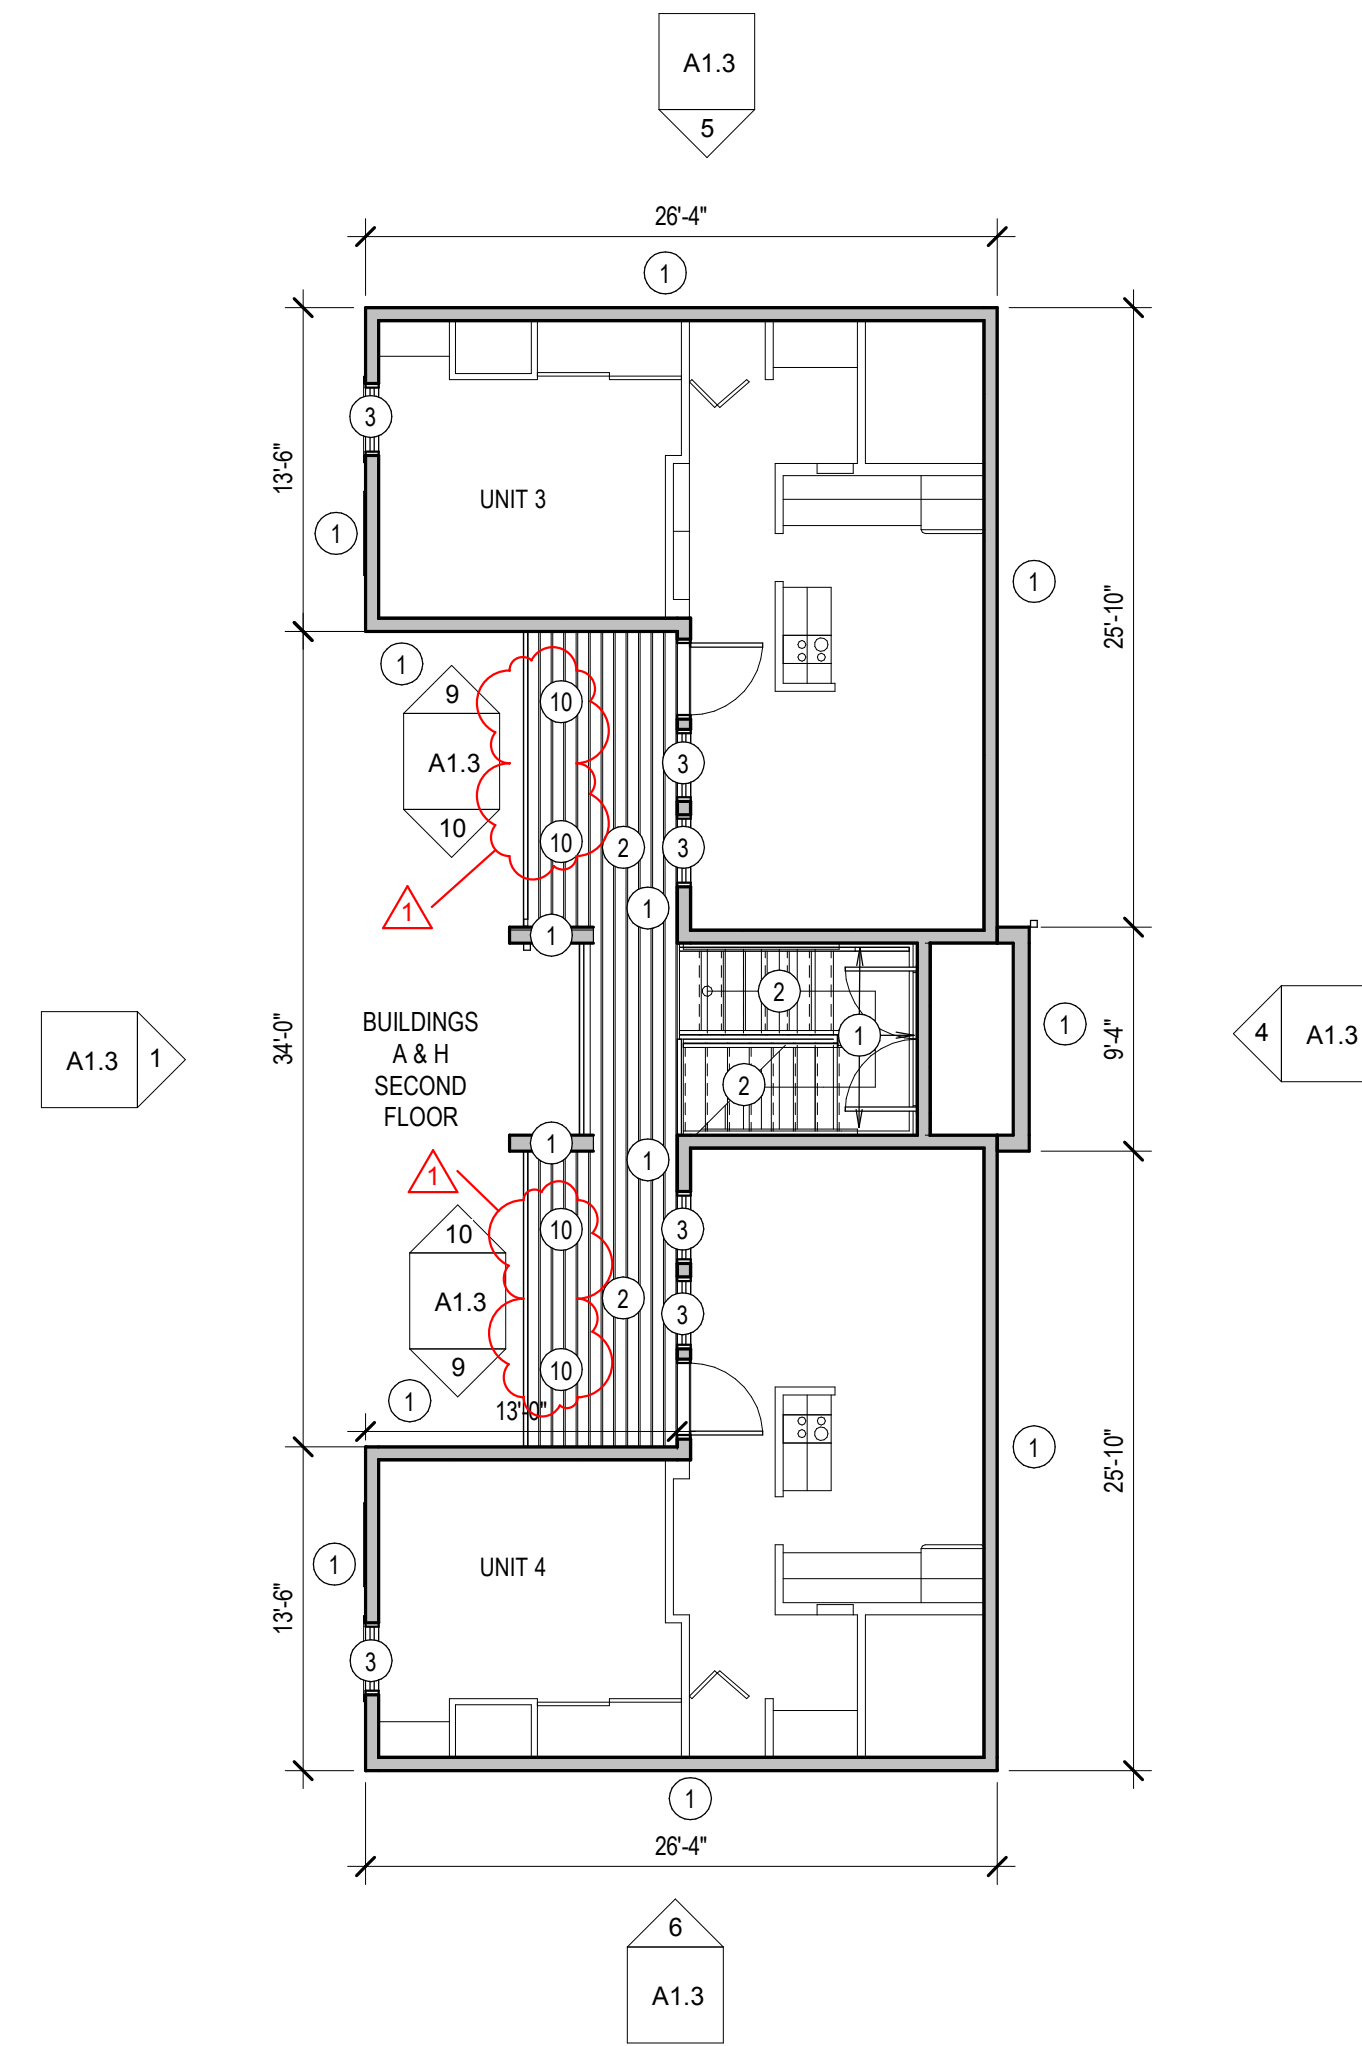1. CONTRACTOR SHALL RESOLVE ALL DIMENSIONAL OR OTHER DISCREPANCIES, DURING LAYOUT WITH ARCHITECT, PRIOR TO BEGINNING CONSTRUCTION.
2. WORK TO BE IN ACCORDANCE WITH CODES & ACCESSIBILITY REQUIREMENTS.
3. CONTRACTOR TO REMOVE ITEMS THAT ARE ATTACHED TO, OR IMPEDE THE REMOVAL OF, THE EXISTING WOOD SIDING, TRIM AND WEATHER BARRIER, WITH THE EXCEPTION OF THE STAIRS, DECK, HANDRAILS AND SOFFIT. THESE INCLUDE, BUT ARE NOT LIMITED TO; CONDUIT, VENTS, GUTTERS, DOWNSPOUTS, PIPING, HOSE BIBBS, AIR CONDITIONERS, LIGHTS, HOSE HANGERS, BUILDING SIGNAGE, MECHANICAL UNITS, ROOF CAP/DROP EDGE, DOOR/WINDOW TRIM, SCUPPERS, CHAIN LINK FENCE POSTS, AND WIRES.
4. THE AGENCY HAD A SERVICE CONTRACTOR REVIEW THE CONDITION OF THE EXISTING WOOD SIDING. IT WAS NOTED THAT BEHIND THE EXISTING WOOD SIDING IS BUILDING PAPER AND WOOD SHEATHING. THEREFORE IT IS ANTICIPATED THAT EXISTING BUILDING PAPER AND WOOD SHEATHING WILL BE FOUND BEHIND THE EXISTING WOOD SIDING.
5. USE ISOLATION TAPE BETWEEN DIS-SIMILAR METALS.
6. DISCONNECT AND REMOVE ITEMS THAT PENETRATE THE EXISTING SIDING, SO NEW SIDING CAN BE INSTALLED WITHOUT COMPLICATION. THIS INCLUDES, BUT IS NOT LIMITED TO; CONDUIT, WIRING, PIPING, VENTS, HOSE BIBBS, ETC.
7. PENETRATIONS TO BE SEALED AND WATERPROOFED.
8. REPLACE ANY EXISTING WALL SHEATHING THAT IS DAMAGED, DETERIORATED OR DESTROYED.

DEMOLITION KEYNOTES

- ① REMOVE WOOD SIDING, TRIM AND WEATHER BARRIER. CAREFULLY REMOVE ANYTHING ATTACHED TO THE SIDING THAT IMPEDES ITS REMOVAL, WITH THE EXCEPTION OF THE STAIRS AND RAILING AND DECK.
- ② RETAIN AND PROTECT EXTERIOR DECK, RAILING AND STAIRS.
- ③ REMOVE WINDOW AND TRIM. REMOVE WOOD SILL ON THE INTERIOR OF WINDOW. CUT BACK AND MODIFY GYPSUM SURROUND AS NEEDED TO INSTALL NEW WINDOW. SEE SHEET A6.1 FOR DETAILS
- ④ RETAIN AND PROTECT METAL RAILING AND WALL MOUNTED BRACKETS AT BLDG H
- ⑤ REMOVE GUTTERS, DOWNSPOUTS AND SCUPPERS
- ⑥ REMOVE PARAPET CAPS.
- ⑦ EXISTING MEMBRANE ROOFING TO BE CUT BACK AT THESE LOCATIONS TO ALLOW NEW SIDING TO BE INSTALLED. NEW MEMBRANE ROOFING TO OVERLAP EXISTING MEMBRANE ROOFING. SEE DETAILS ON SHEET A6.1
- ⑧ REMOVE EXISTING EXHAUST VENT CAP
- ⑨ REMOVE EXISTING WALL LOUVER
- ⑩ REMOVE EXISTING SOFFIT LOUVER

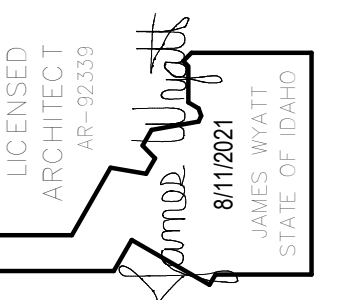

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PROJECT: DPW 21239 ISU: PULLING COURTS SIDING AND WINDOW REPLACEMENT
756 S. 10TH AVE
POCATELLO, IDAHO 83201

SHEET TITLE: DEMOLITION PLANS BUILDINGS A & H


PROJECT NO. 21001
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CHECKED BY: NBW

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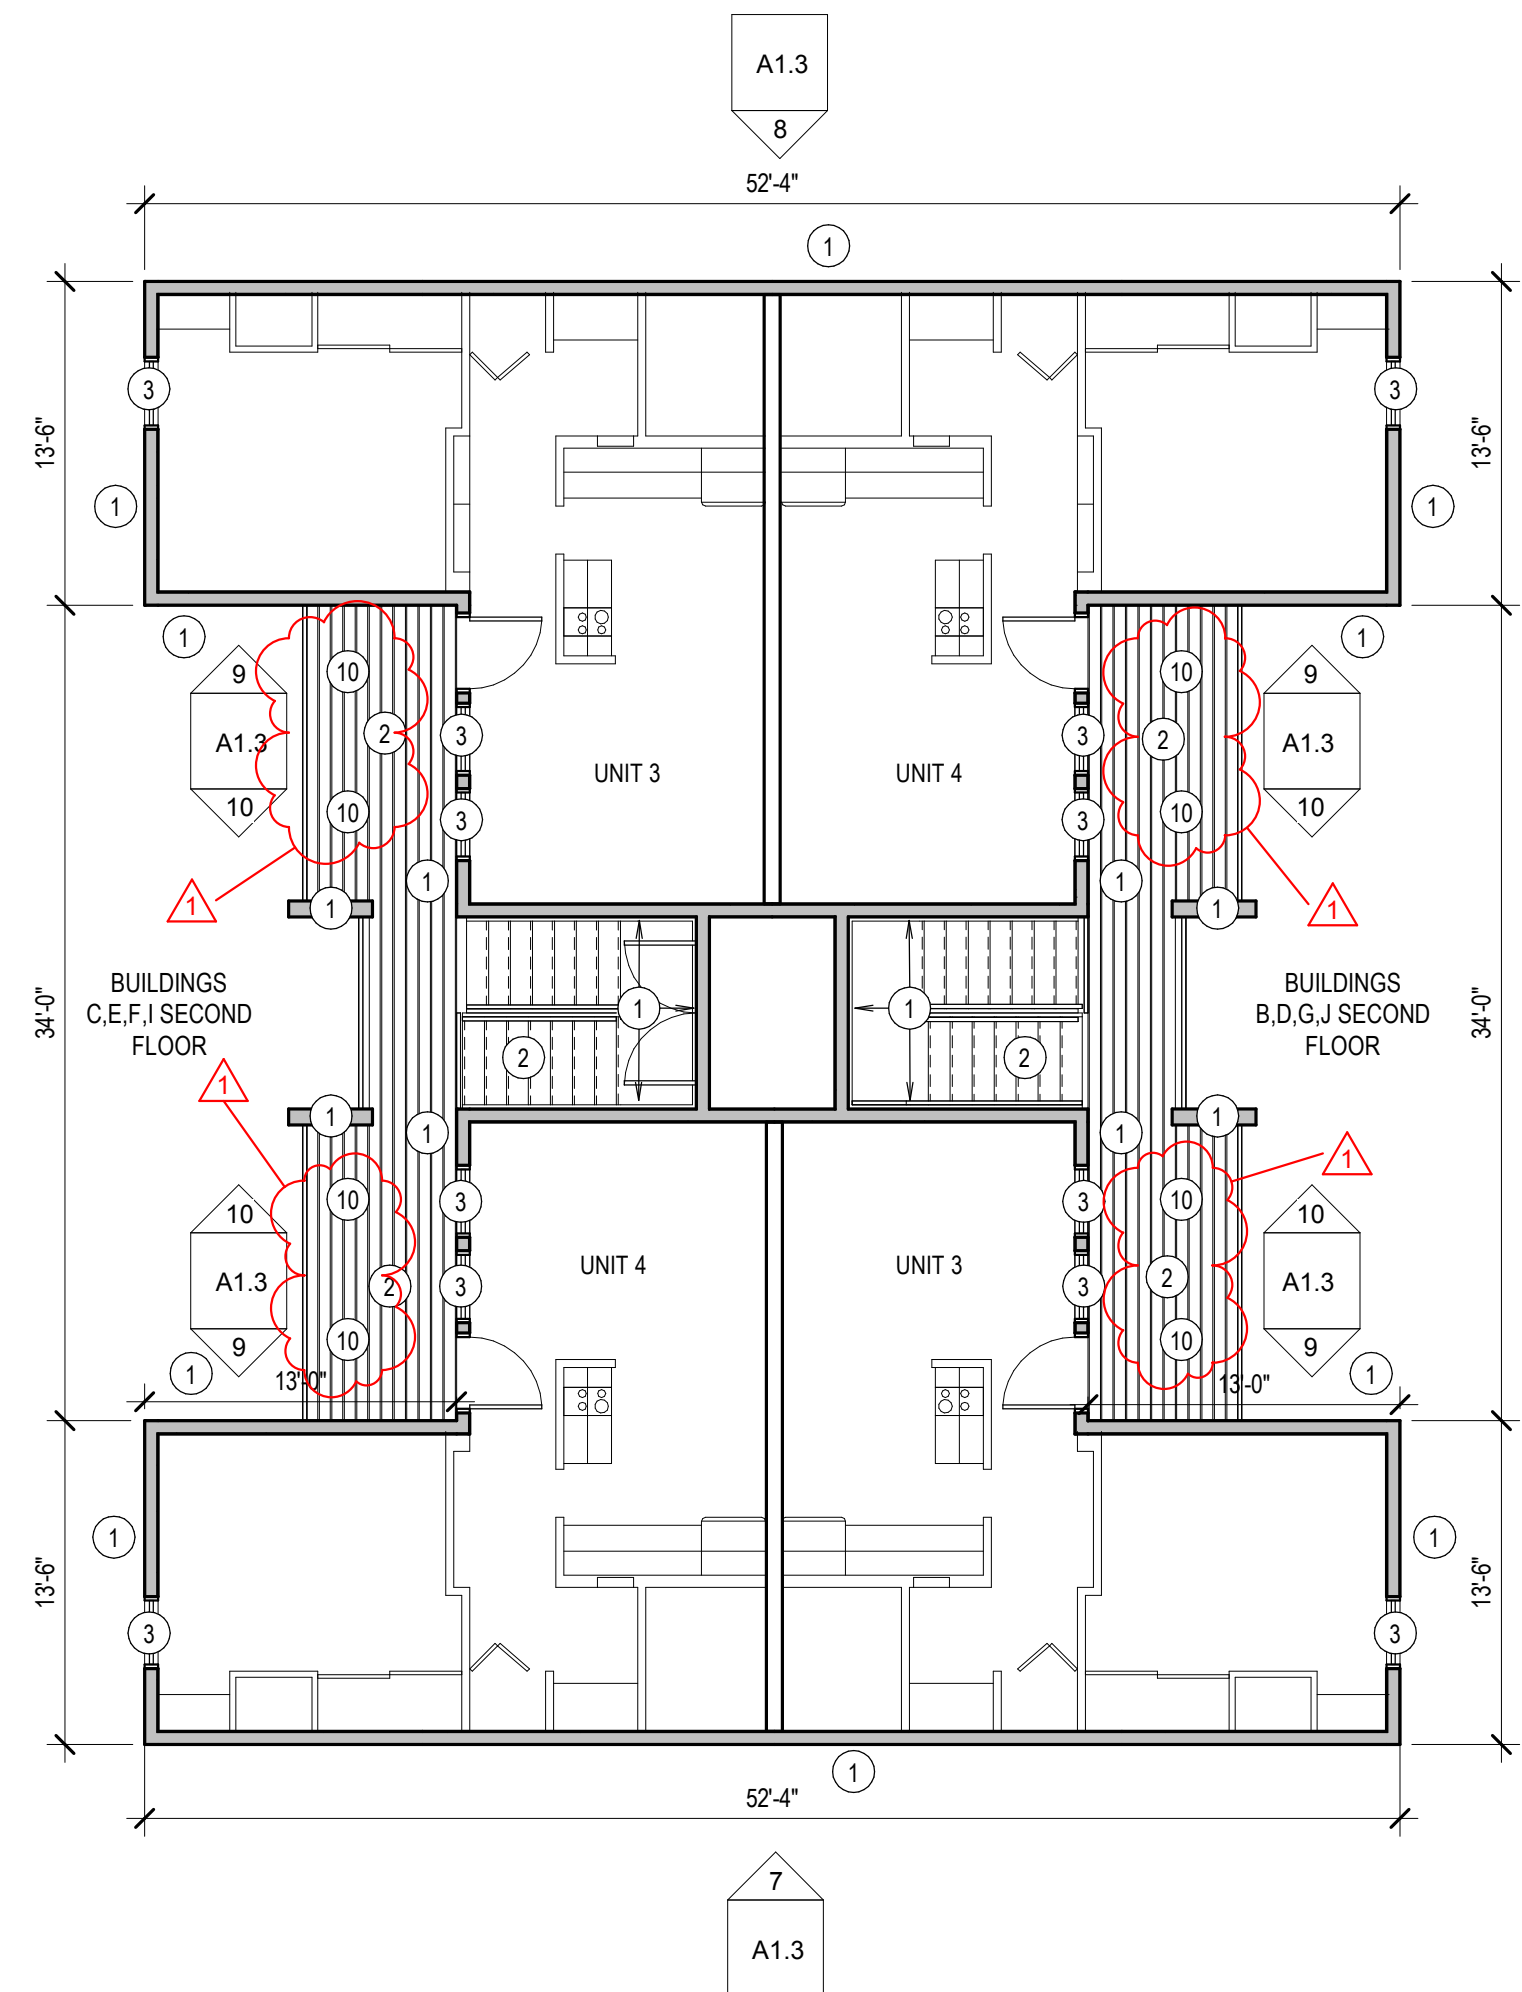
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MAIN LEVEL DEMOLITION PLAN

SCALE: 1/8" = 1'-0"



SECOND LEVEL DEMOLITION PLAN

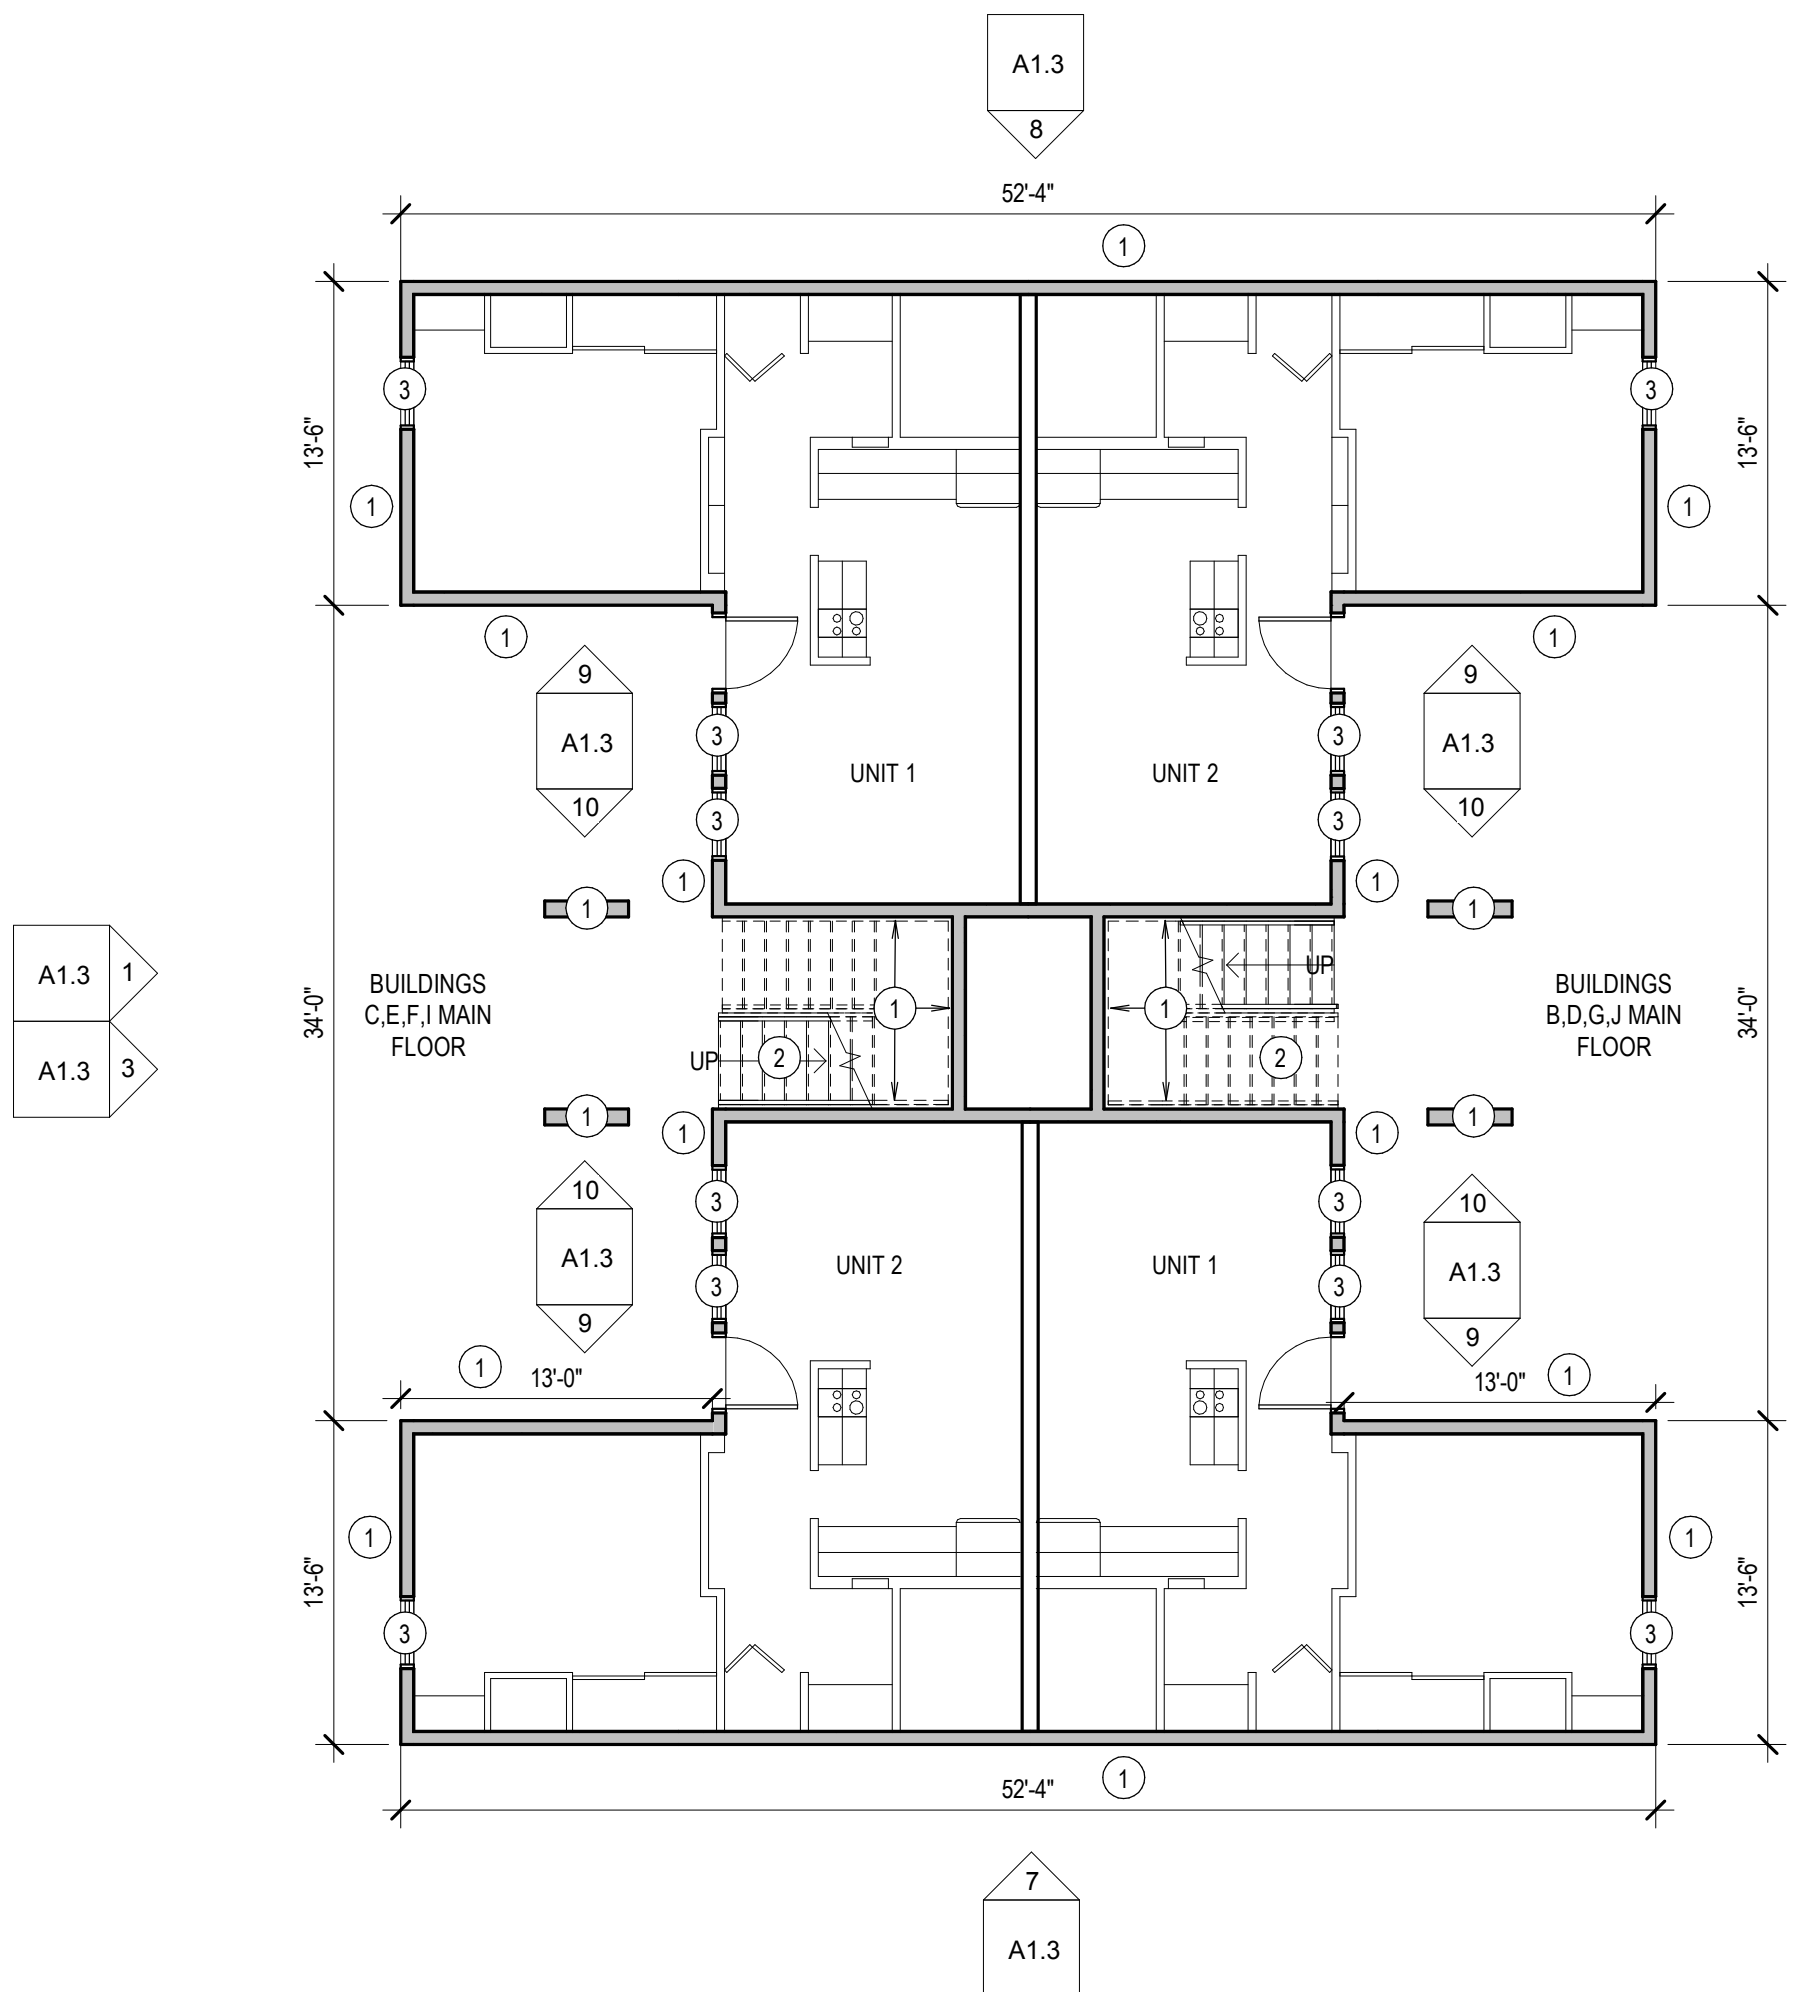
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DEMOLITION GENERAL NOTES

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2. WORK TO BE IN ACCORDANCE WITH CODES & ACCESSIBILITY REQUIREMENTS.
3. CONTRACTOR TO REMOVE ITEMS THAT ARE ATTACHED TO, OR IMPEDE THE REMOVAL OF, THE EXISTING WOOD SIDING, TRIM AND WEATHER BARRIER, WITH THE EXCEPTION OF THE STAIRS, DECK, HANDRAILS AND SOFFIT. THESE INCLUDE, BUT ARE NOT LIMITED TO; CONDUIT, VENTS, GUTTERS, DOWNSPOUTS, PIPING, HOSE BIBBS, AIR CONDITIONERS, LIGHTS, HOSE HANGERS, BUILDING SIGNAGE, MECHANICAL UNITS, ROOF CAP/DROP EDGE, DOOR/WINDOW TRIM, SCUPPERS, CHAIN LINK FENCE POSTS, AND WIRES.
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5. USE ISOLATION TAPE BETWEEN DIS-SIMILAR METALS.
6. DISCONNECT AND REMOVE ITEMS THAT PENETRATE THE EXISTING SIDING, SO NEW SIDING CAN BE INSTALLED WITHOUT COMPLICATION. THIS INCLUDES, BUT IS NOT LIMITED TO; CONDUIT, WIRING, PIPING, VENTS, HOSE BIBBS, ETC.
7. PENETRATIONS TO BE SEALED AND WATERPROOFED.
8. REPLACE ANY EXISTING WALL SHEATHING THAT IS DAMAGED, DETERIORATED OR DESTROYED.

DEMOLITION KEYNOTES

- 1 REMOVE WOOD SIDING, TRIM AND WEATHER BARRIER. CAREFULLY REMOVE ANYTHING ATTACHED TO THE SIDING THAT IMPEDES ITS REMOVAL, WITH THE EXCEPTION OF THE STAIRS AND RAILING AND DECK.
- 2 RETAIN AND PROTECT EXTERIOR DECK, RAILING AND STAIRS.
- 3 REMOVE WINDOW AND TRIM. REMOVE WOOD SILL ON THE INTERIOR OF WINDOW. CUT BACK AND MODIFY GYPSUM SURROUND AS NEEDED TO INSTALL NEW WINDOW. SEE SHEET A6.1 FOR DETAILS
- 4 RETAIN AND PROTECT METAL RAILING AND WALL MOUNTED BRACKETS AT BLDG H
- 5 REMOVE GUTTERS, DOWNSPOUTS AND SCUPPERS
- 6 REMOVE PARAPET CAPS.
- 7 EXISTING MEMBRANE ROOFING TO BE CUT BACK AT THESE LOCATIONS TO ALLOW NEW SIDING TO BE INSTALLED. NEW MEMBRANE ROOFING TO OVERLAP EXISTING MEMBRANE ROOFING. SEE DETAILS ON SHEET A6.1
- 8 REMOVE EXISTING EXHAUST VENT CAP
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SHEET TITLE: DEMOLITION PLANS BUILDINGS B,C,D,E,F,G,I,J


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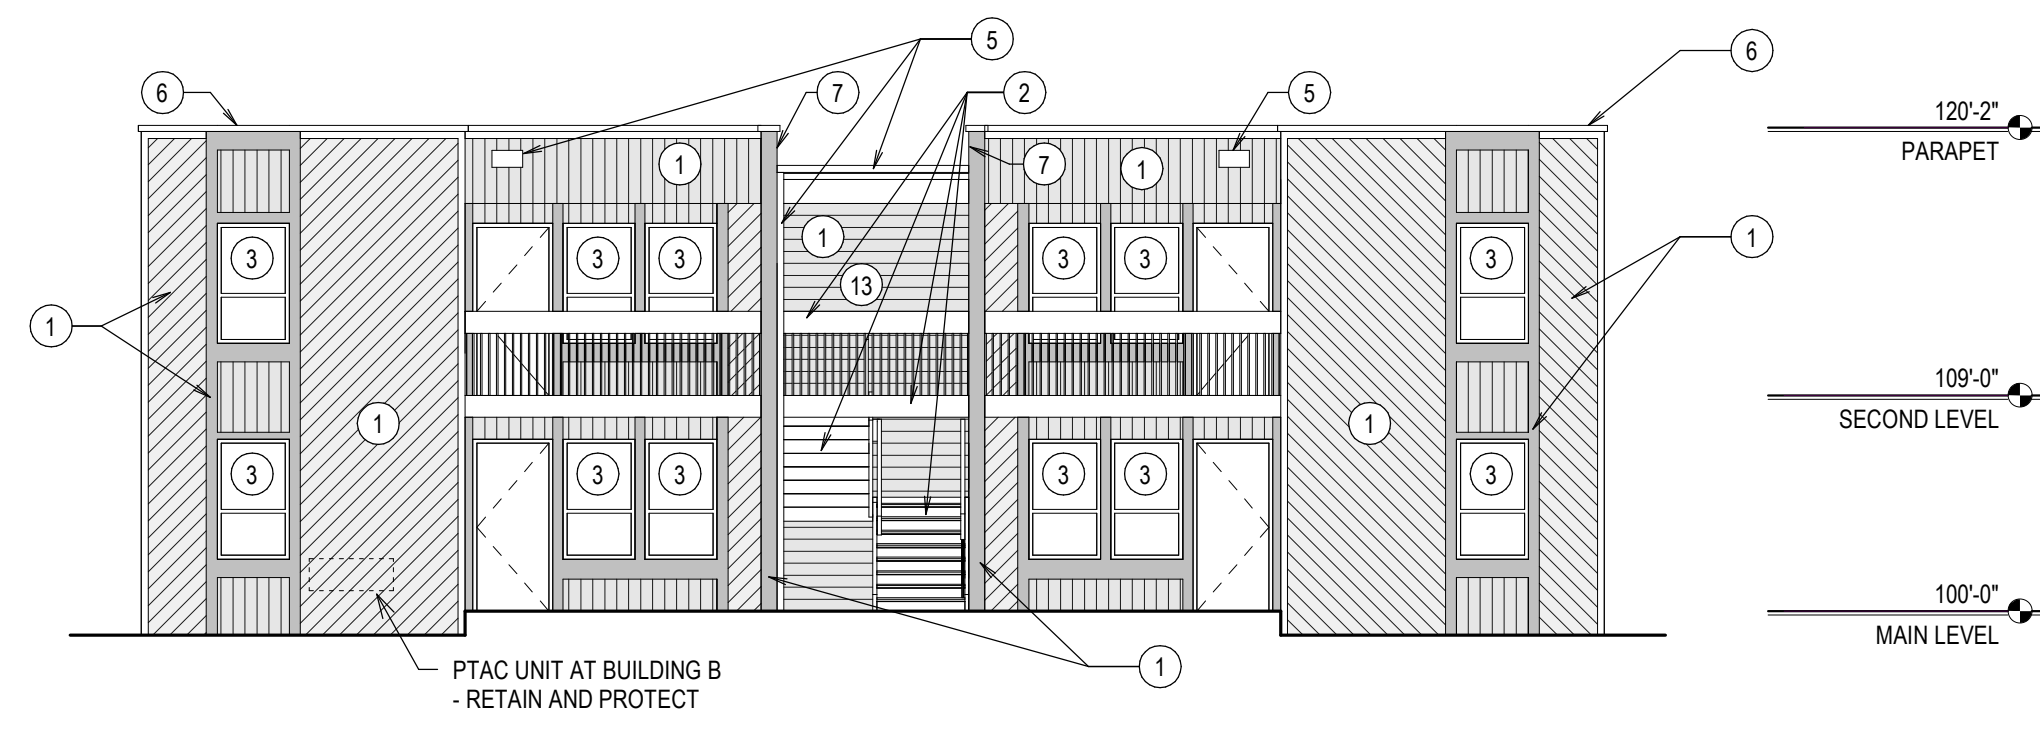
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REVISED 10-29-2021

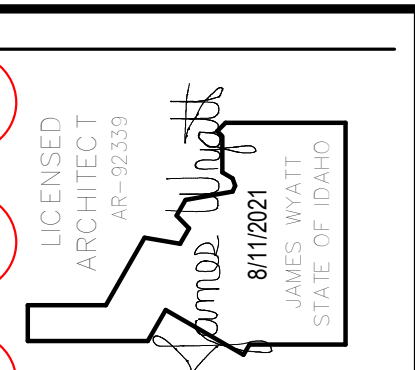


1 DEMOLITION ELEVATION BLDGS A,C,E,F,H

A1.3 SCALE: 1/8" = 1'-0"

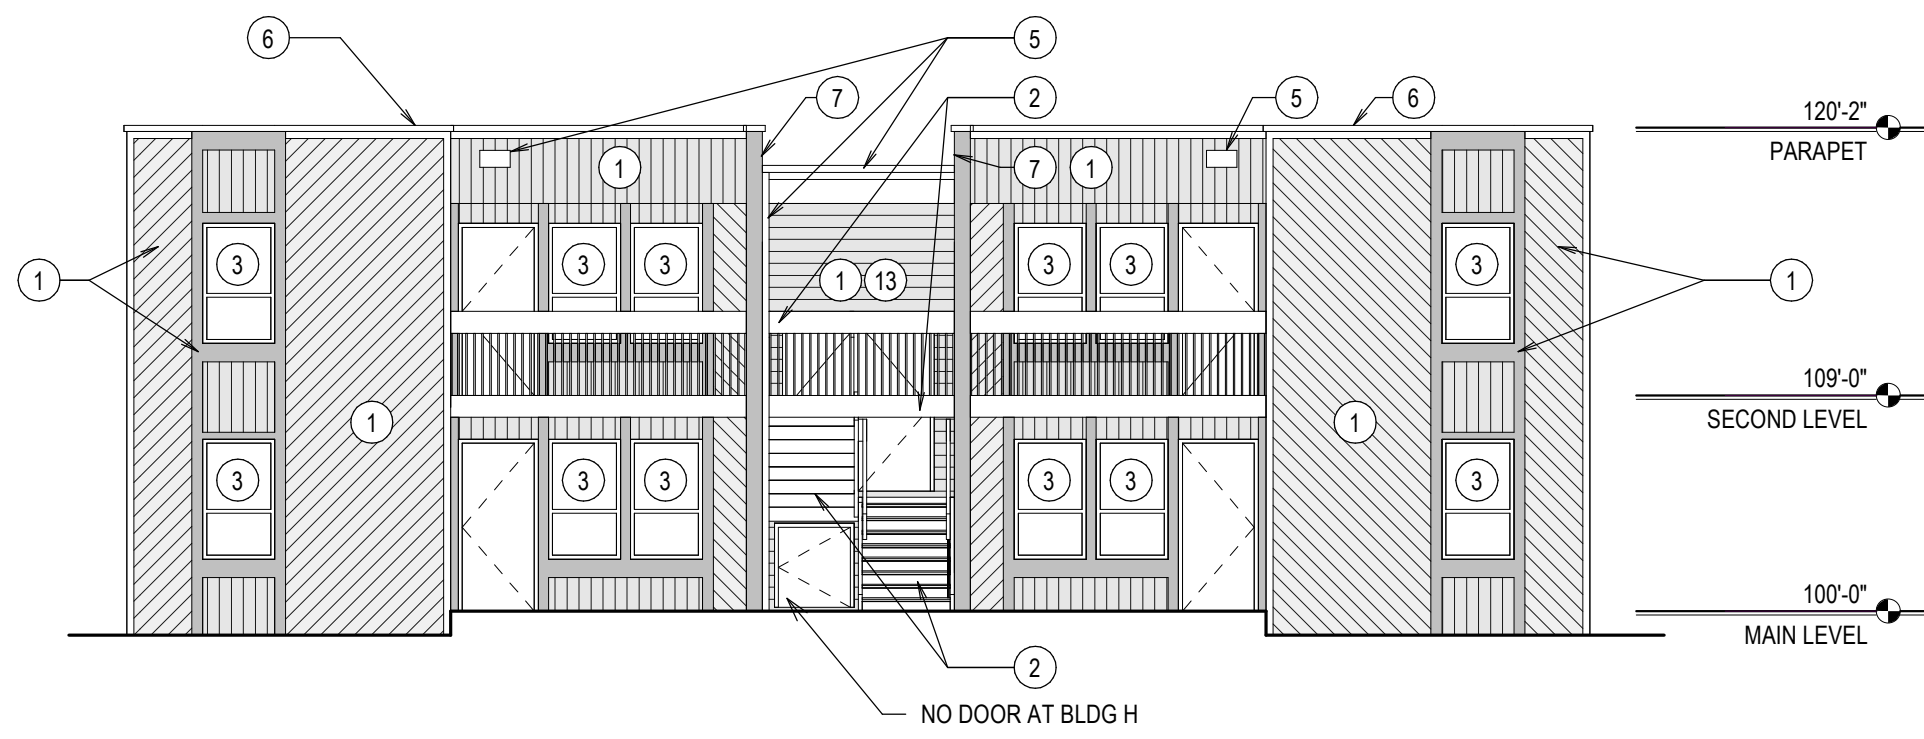


2 DEMOLITION ELEVATION BLDGS B,D,G,J

A1.3 SCALE: 1/8" = 1'-0"

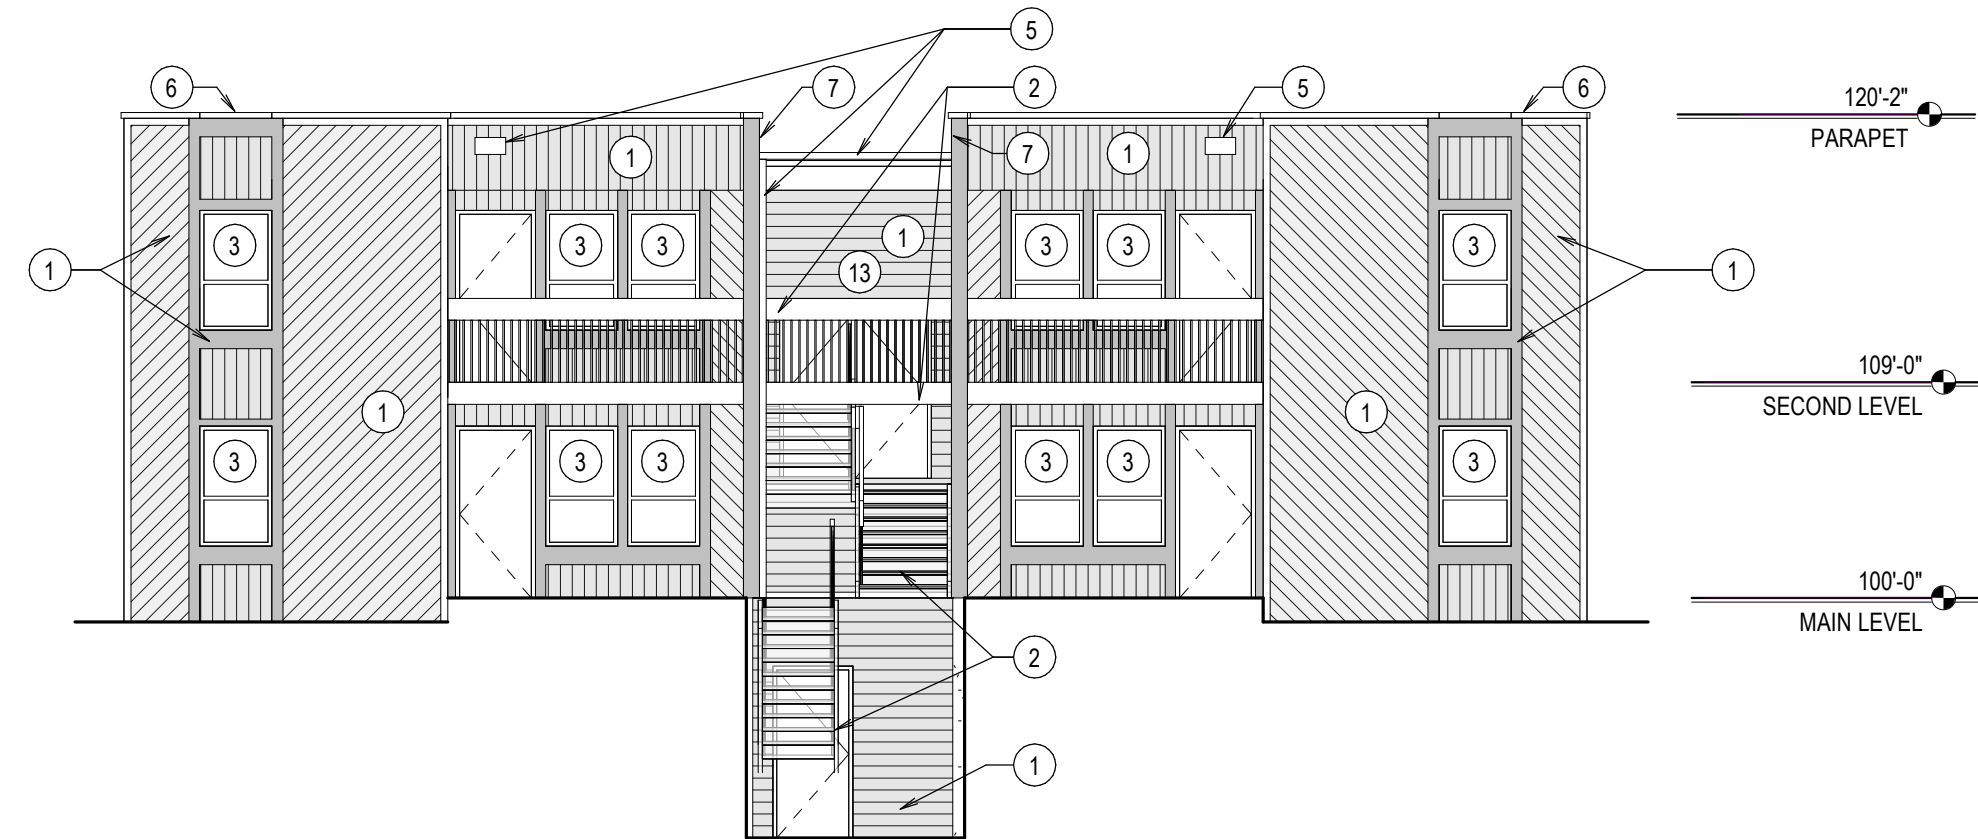


3 DEMOLITION ELEVATION BLDG I

A1.3 SCALE: 1/8" = 1'-0"

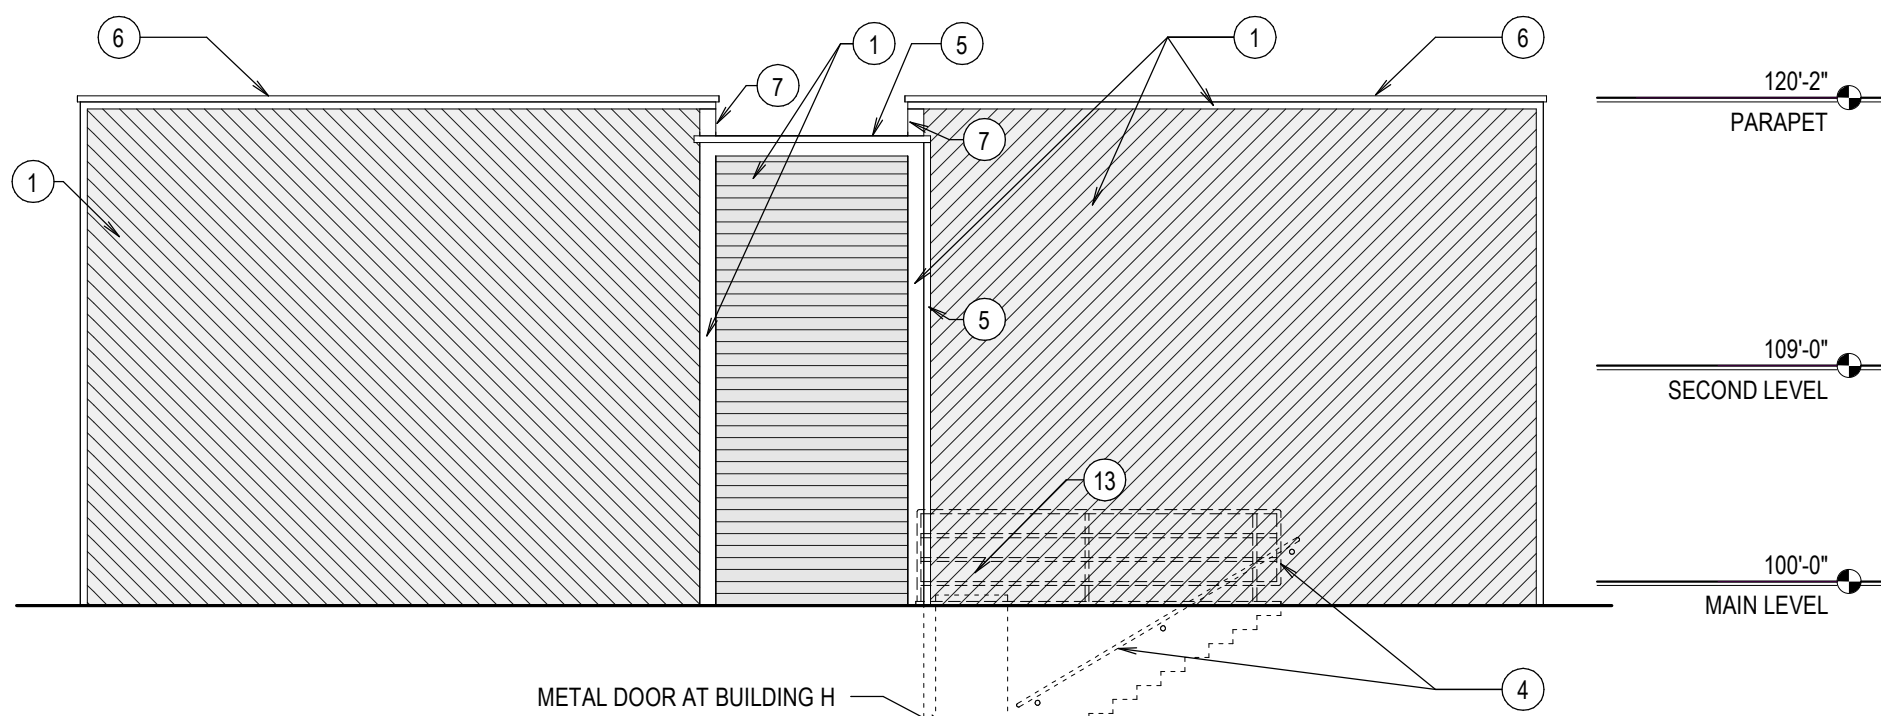


4 DEMOLITION ELEVATION BLDGS A & H

A1.3 SCALE: 1/8" = 1'-0"

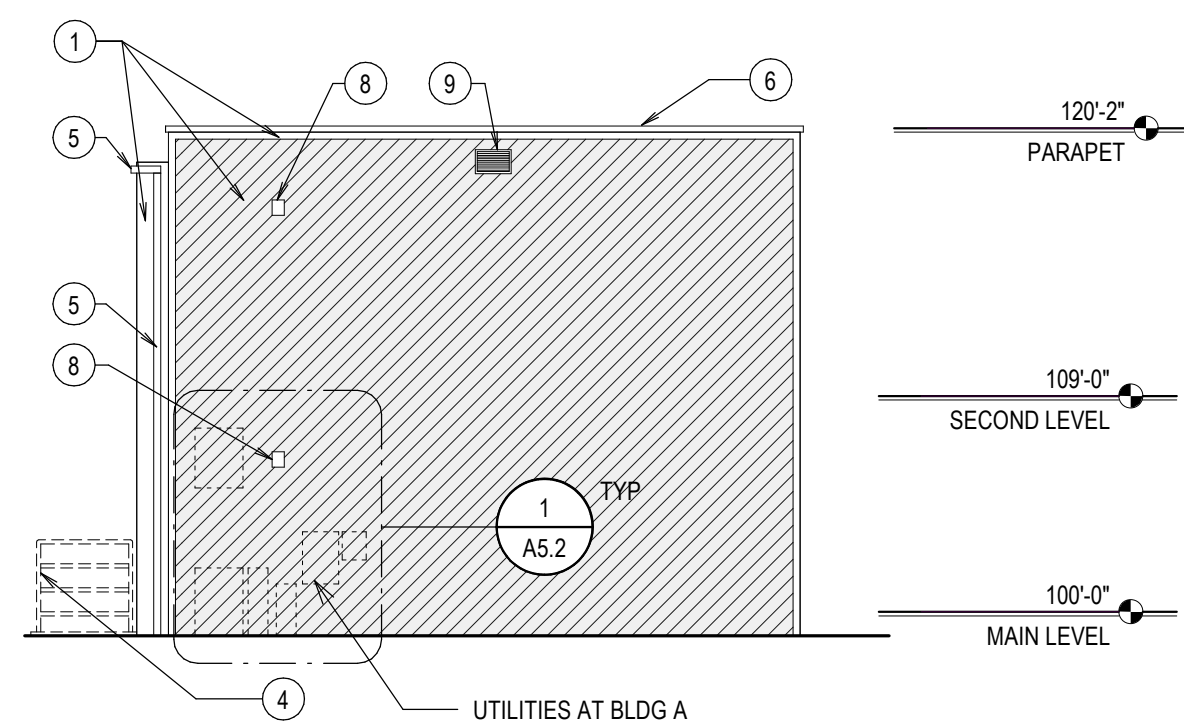


5 DEMOLITION ELEVATION BLDGS A & H

A1.3 SCALE: 1/8" = 1'-0"

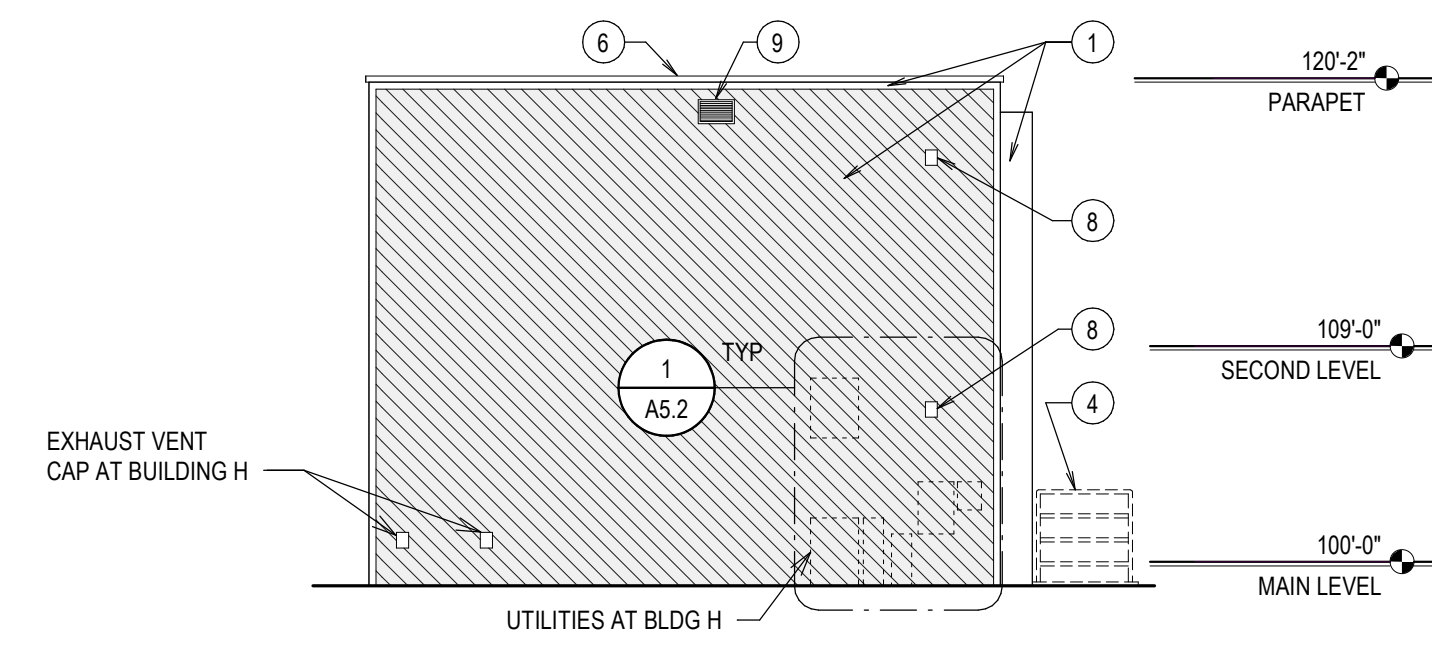


6 DEMOLITION ELEVATION BLDGS A & H

A1.3 SCALE: 1/8" = 1'-0"

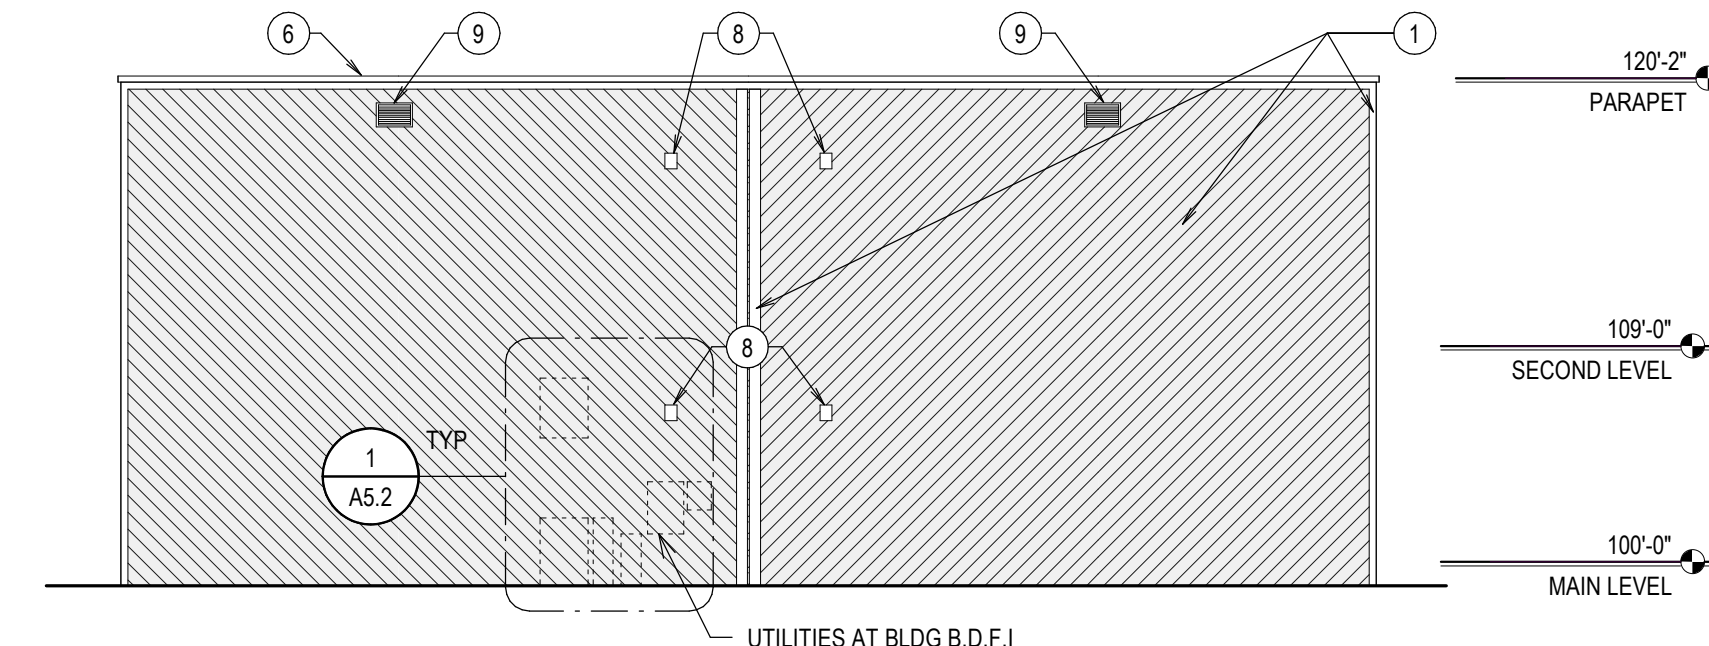


7 DEMOLITION ELEVATION BLDGS B,C,D,E,F,G,I,J

A1.3 SCALE: 1/8" = 1'-0"

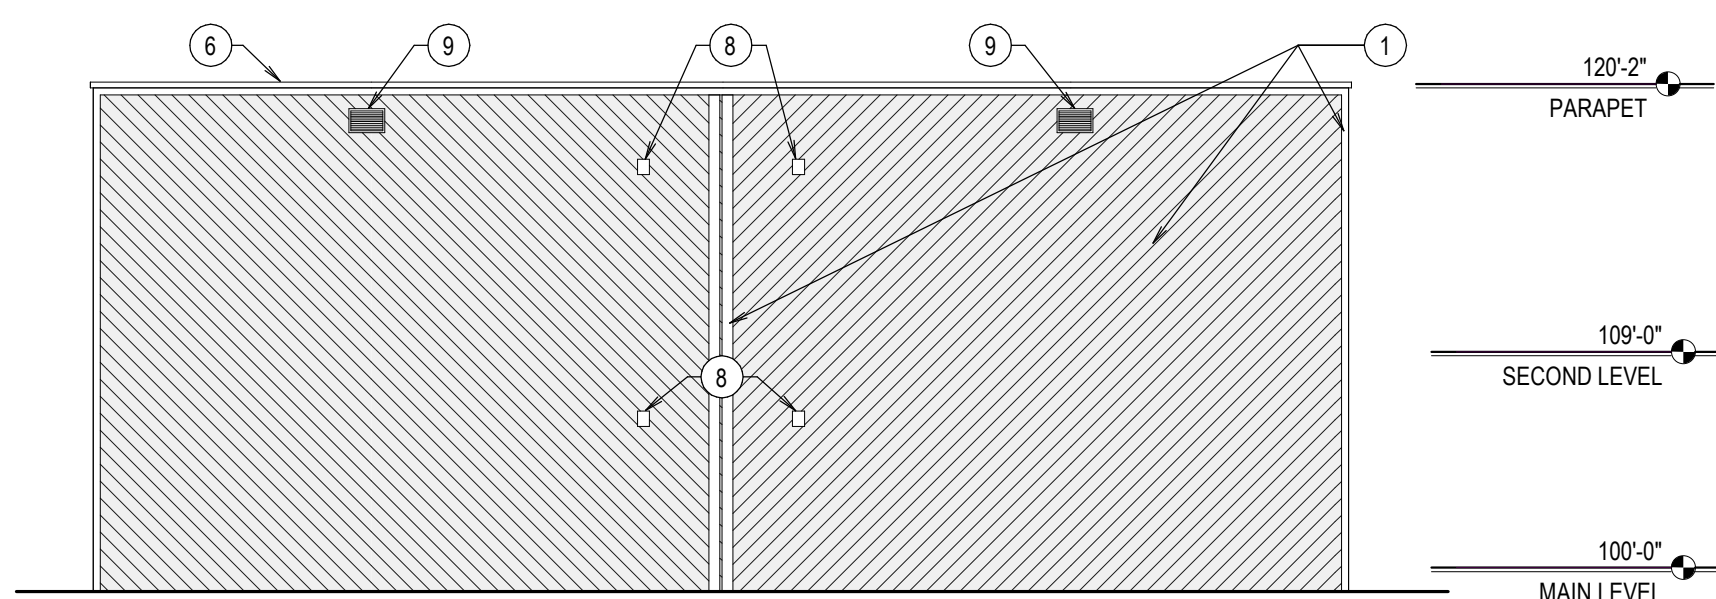


8 DEMOLITION ELEVATION BLDGS B,C,D,E,F,G,I,J

A1.3 SCALE: 1/8" = 1'-0"

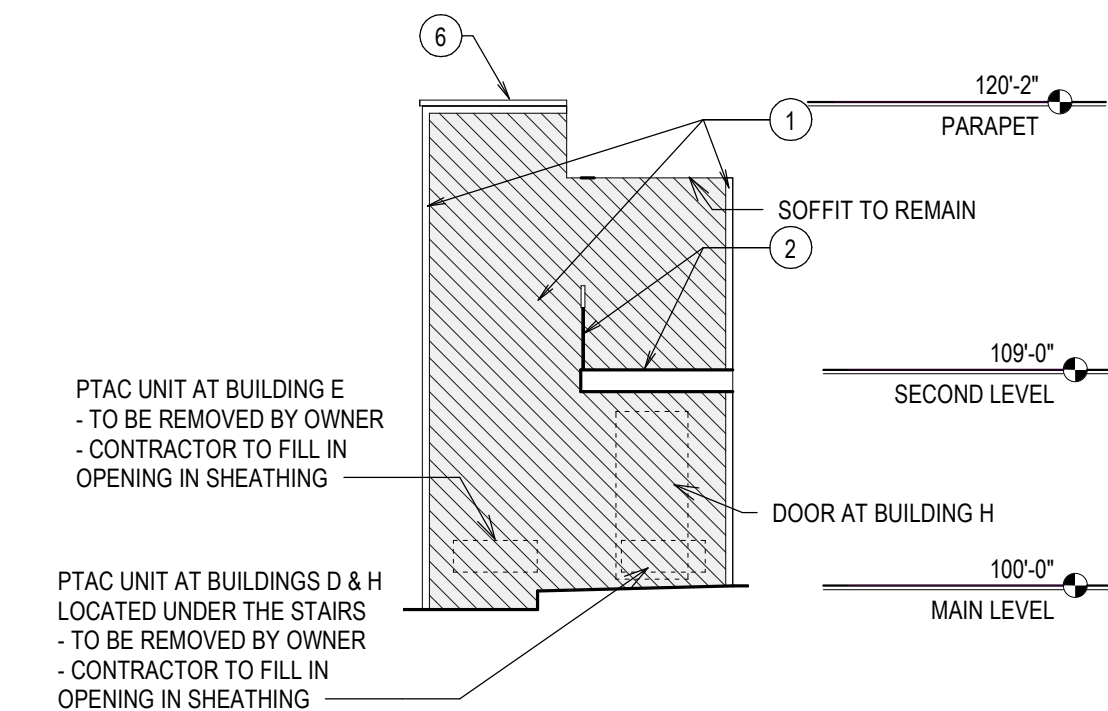

9 DEMOLITION ELEVATION ALL BLDGS

A1.3 SCALE: 1/8" = 1'-0"

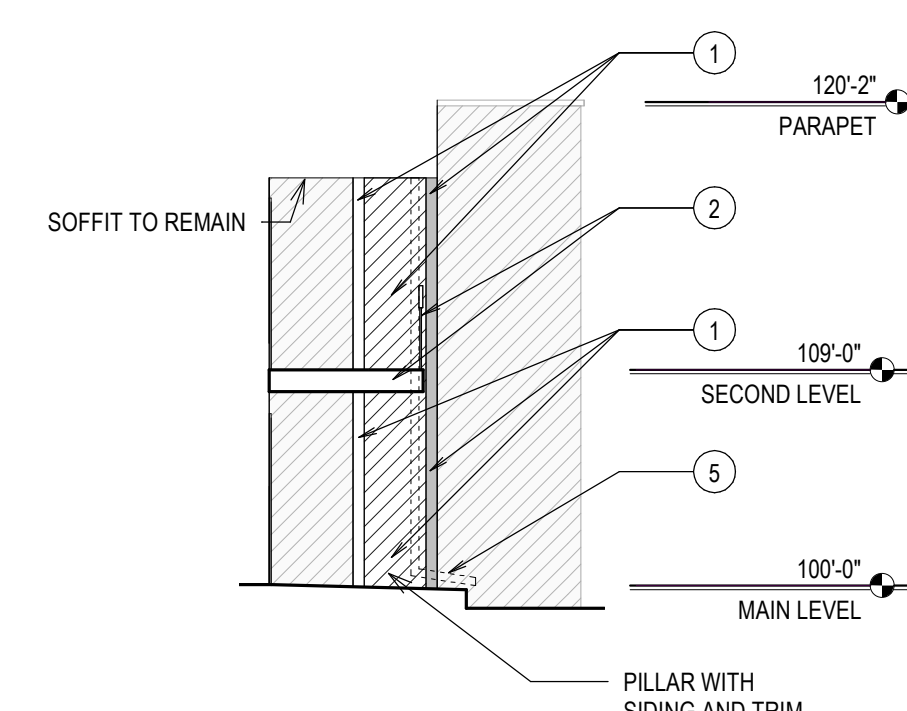

10 PILLAR DEMOLITION ELEVATION ALL BLDGS

A1.3 SCALE: 1/8" = 1'-0"

DEMOLITION GENERAL NOTES

- CONTRACTOR SHALL RESOLVE ALL DIMENSIONAL OR OTHER DISCREPANCIES, DURING LAYOUT WITH ARCHITECT, PRIOR TO BEGINNING CONSTRUCTION.
- WORK TO BE IN ACCORDANCE WITH CODES & ACCESSIBILITY REQUIREMENTS.
- CONTRACTOR TO REMOVE ITEMS THAT ARE ATTACHED TO, OR IMPEDE THE REMOVAL OF, THE EXISTING WOOD SIDING, TRIM AND WEATHER BARRIER, WITH THE EXCEPTION OF THE STAIRS, DECK, HANDRAILS AND SOFFIT. THESE INCLUDE, BUT ARE NOT LIMITED TO, CONDUIT, VENTS, GUTTERS, DOWNSPOUTS, PIPING, HOSE BIBBS, AIR CONDITIONERS, LIGHTS, HOSE HANGERS, BUILDING SIGNAGE, MECHANICAL UNITS, ROOF CAP/DROP EDGE, DOOR/WINDOW TRIM, SCUPPERS, CHAIN LINK FENCE POSTS, AND WIRES.
- THE AGENCY HAD A SERVICE CONTRACTOR REVIEW THE CONDITION OF THE EXISTING WOOD SIDING. IT WAS NOTED THAT BEHIND THE EXISTING WOOD SIDING IS BUILDING PAPER AND WOOD SHEATHING. THEREFORE IT IS ANTICIPATED THAT EXISTING BUILDING PAPER AND WOOD SHEATHING WILL BE FOUND BEHIND THE EXISTING WOOD SIDING.
- USE ISOLATION TAPE BETWEEN DIS-SIMILAR METALS.
- DISCONNECT AND REMOVE ITEMS THAT PENETRATE THE EXISTING SIDING, SO NEW SIDING CAN BE INSTALLED WITHOUT COMPLICATION. THIS INCLUDES, BUT IS NOT LIMITED TO, CONDUIT, WIRING, PIPING, VENTS, HOSE BIBBS, ETC.
- PENETRATIONS TO BE SEALED AND WATERPROOFED.
- REPLACE ANY EXISTING WALL SHEATHING THAT IS DAMAGED, DETERIORATED OR DESTROYED.

DEMOLITION KEYNOTES

- REMOVE WOOD SIDING, TRIM AND WEATHER BARRIER CAREFULLY REMOVE ANYTHING ATTACHED TO THE SIDING THAT IMPEDES ITS REMOVAL, WITH THE EXCEPTION OF THE STAIRS AND RAILING AND DECK.
- RETAIN AND PROTECT EXTERIOR DECK, RAILING AND STAIRS.
- REMOVE WINDOW AND TRIM. REMOVE WOOD SILL ON THE INTERIOR OF WINDOW. CUT BACK AND MODIFY GYPSUM SURROUND AS NEEDED TO INSTALL NEW WINDOW. SEE SHEET A6.1 FOR DETAILS
- RETAIN AND PROTECT METAL RAILING AND WALL MOUNTED BRACKETS AT BLDG H
- REMOVE GUTTERS, DOWNSPOUTS AND SCUPPERS
- REMOVE PARAPET CAPS.
- EXISTING MEMBRANE ROOFING TO BE CUT BACK AT THESE LOCATIONS TO ALLOW NEW SIDING TO BE INSTALLED. NEW MEMBRANE ROOFING TO OVERLAP EXISTING MEMBRANE ROOFING. SEE DETAILS ON SHEET A6.1
- REMOVE EXISTING EXHAUST VENT CAP
- REMOVE EXISTING WALL LOUVER
- REMOVE EXISTING SOFFIT LOUVER



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PROJECT: DPW 21239 ISU: PULLING COURTS SIDING AND WINDOW REPLACEMENT
756 S. 10TH AVE
POCATELLO, IDAHO 83201
SHEET TITLE: DEMOLITION ELEVATIONS

PROJECT NO. 21001
DATE: AUGUST 2021
DRAWN BY: NBW
CHECKED BY: NBW

REVISIONS	DATE
1 ADDENDUM #1	10-28-2021


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REVISED 10-29-2021




10/29/2021 10:51:43 AM C:\Users\jrhansen\Documents\21239 PULLING COURTS SIDING_HanselNickl.rvt

KEYNOTES	
1	NEW VINYL SIDING - COLOR 1
2	SCRAPE, SAND AND PAINT EXTERIOR WOOD DECK, RAILING, STAIRS AND SOFFIT. THIS IS TO INCLUDE THE UNDERSIDE OF THE DECK AND ANY ASSOCIATED STRUCTURE. TAPE OFF AND PAINT AROUND LIGHT FIXTURES ON THE SOFFIT AND UNDERSIDE OF DECKING. ALL ASSOCIATED CONDUIT TO BE PAINTED TO MATCH SURROUNDING MATERIAL.
3	WINDOWS IN EVERY BUILDING TO BE REPLACED. REPLACE WOOD SILL ON THE INTERIOR OF WINDOW. WHERE DETERIORATED OR DAMAGED GYPSUM IS FOUND REPLACE GYPSUM WITH NEW - FINISH TO MATCH EXISTING WALLS. SEE SHEET A6.1 FOR DETAILS
4	EXISTING METAL RAILING, HANDRAIL AND WALL MOUNTED BRACKETS AT BLDG H TO BE CLEANED, SANDED AND PAINTED
5	EXISTING METAL DOORS AND FRAMES TO BE CLEANED, SANDED AND PAINTED BOTH INTERIOR AND EXTERIOR
6	NEW PREFINISHED PARAPET CAP
7	EXISTING MEMBRANE ROOFING TO BE CUT BACK AT THESE LOCATIONS TO ALLOW NEW SIDING TO BE INSTALLED. NEW MEMBRANE ROOFING TO OVERLAP EXISTING MEMBRANE ROOFING. SEE DETAILS ON SHEET A6.1.
8	NEW PREFINISHED GUTTERS, DOWNSPOUTS AND SCUPPERS
9	LOCATIONS FOR FUTURE PTAC UNITS - OWNER FURNISHED AND INSTALLED
10	NEW EXHAUST VENT CAP TO BE FAMCO 4" GALVANIZED HOODED WALL VENT WITH SPRING LOADED DAMPER GASKET AND SCREEN-PAINTED
11	NEW PREFINISHED METAL WALL LOUVER
12	NEW VINYL SIDING - COLOR 2
13	LIGHTING ATTACHED TO WALL NEEDS TO BE REMOVED AND REATTACHED AFTER VINYL SIDING INSTALLATION
14	NEW PREFINISHED METAL SOFFIT LOUVER

GENERAL NOTES	
1.	CONTRACTOR SHALL RESOLVE ALL DIMENSIONAL OR OTHER DISCREPANCIES, DURING LAYOUT WITH ARCHITECT, PRIOR TO BEGINNING CONSTRUCTION.
2.	WORK TO BE IN ACCORDANCE WITH CODES & ACCESSIBILITY REQUIREMENTS.
3.	USE ISOLATION TAPE BETWEEN DIS-SIMILAR METALS.
4.	PENETRATIONS TO BE SEALED AND WATERPROOFED.
5.	CONTRACTOR TO FIELD VERIFY ALL SIZES FOR LOUVERS AND VENTS

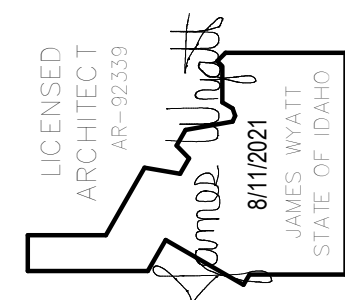

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PROJECT: DPW 21239 ISU: PULLING COURTS SIDING AND WINDOW REPLACEMENT
 756 S. 10TH AVE
 POCATELLO, IDAHO 83201
 SHEET TITLE: FLOOR PLANS BUILDINGS A & H

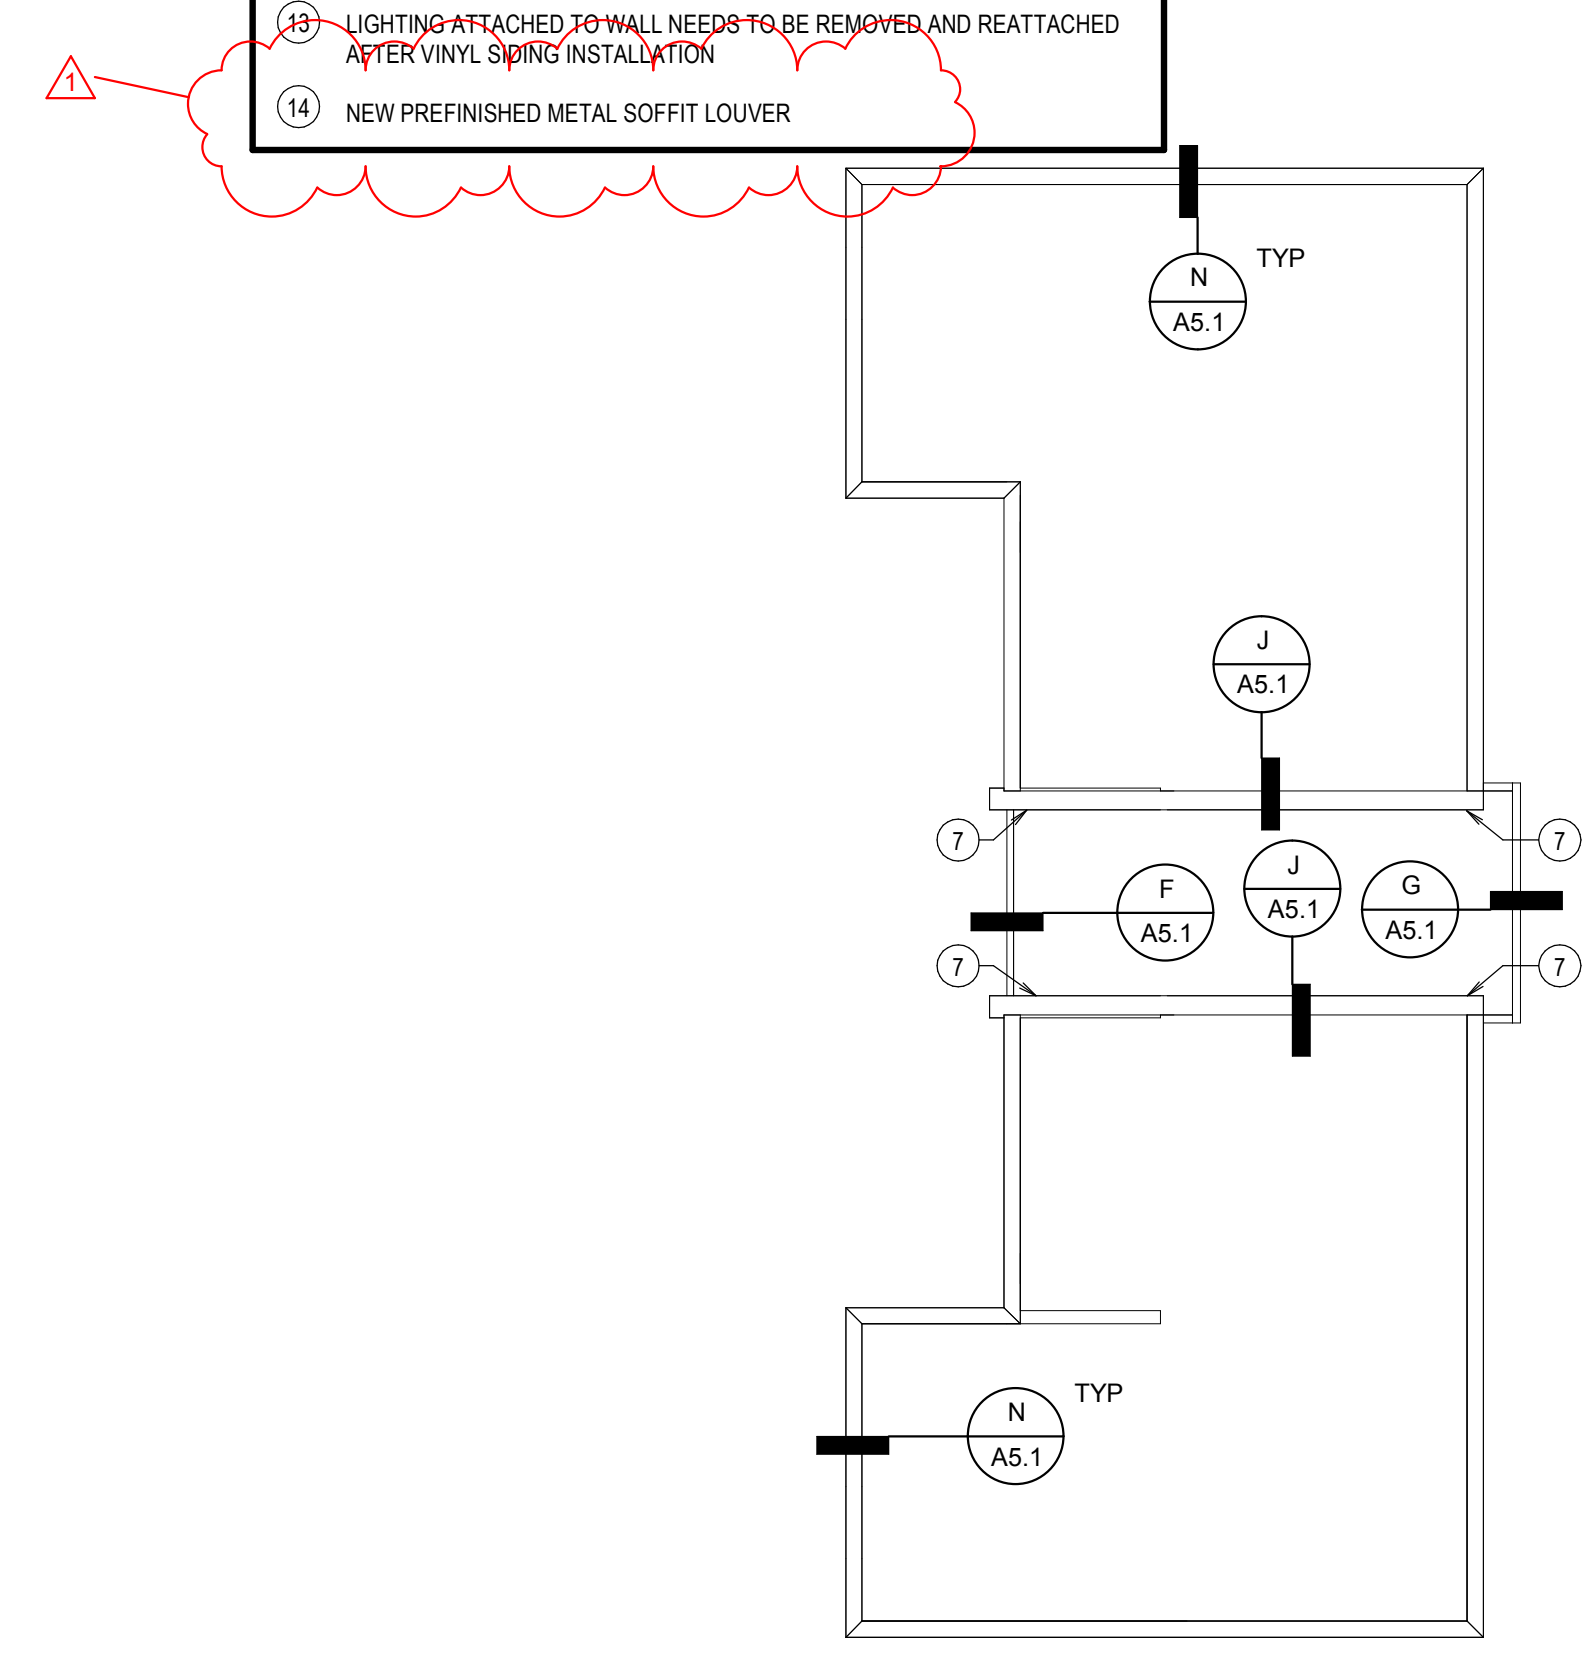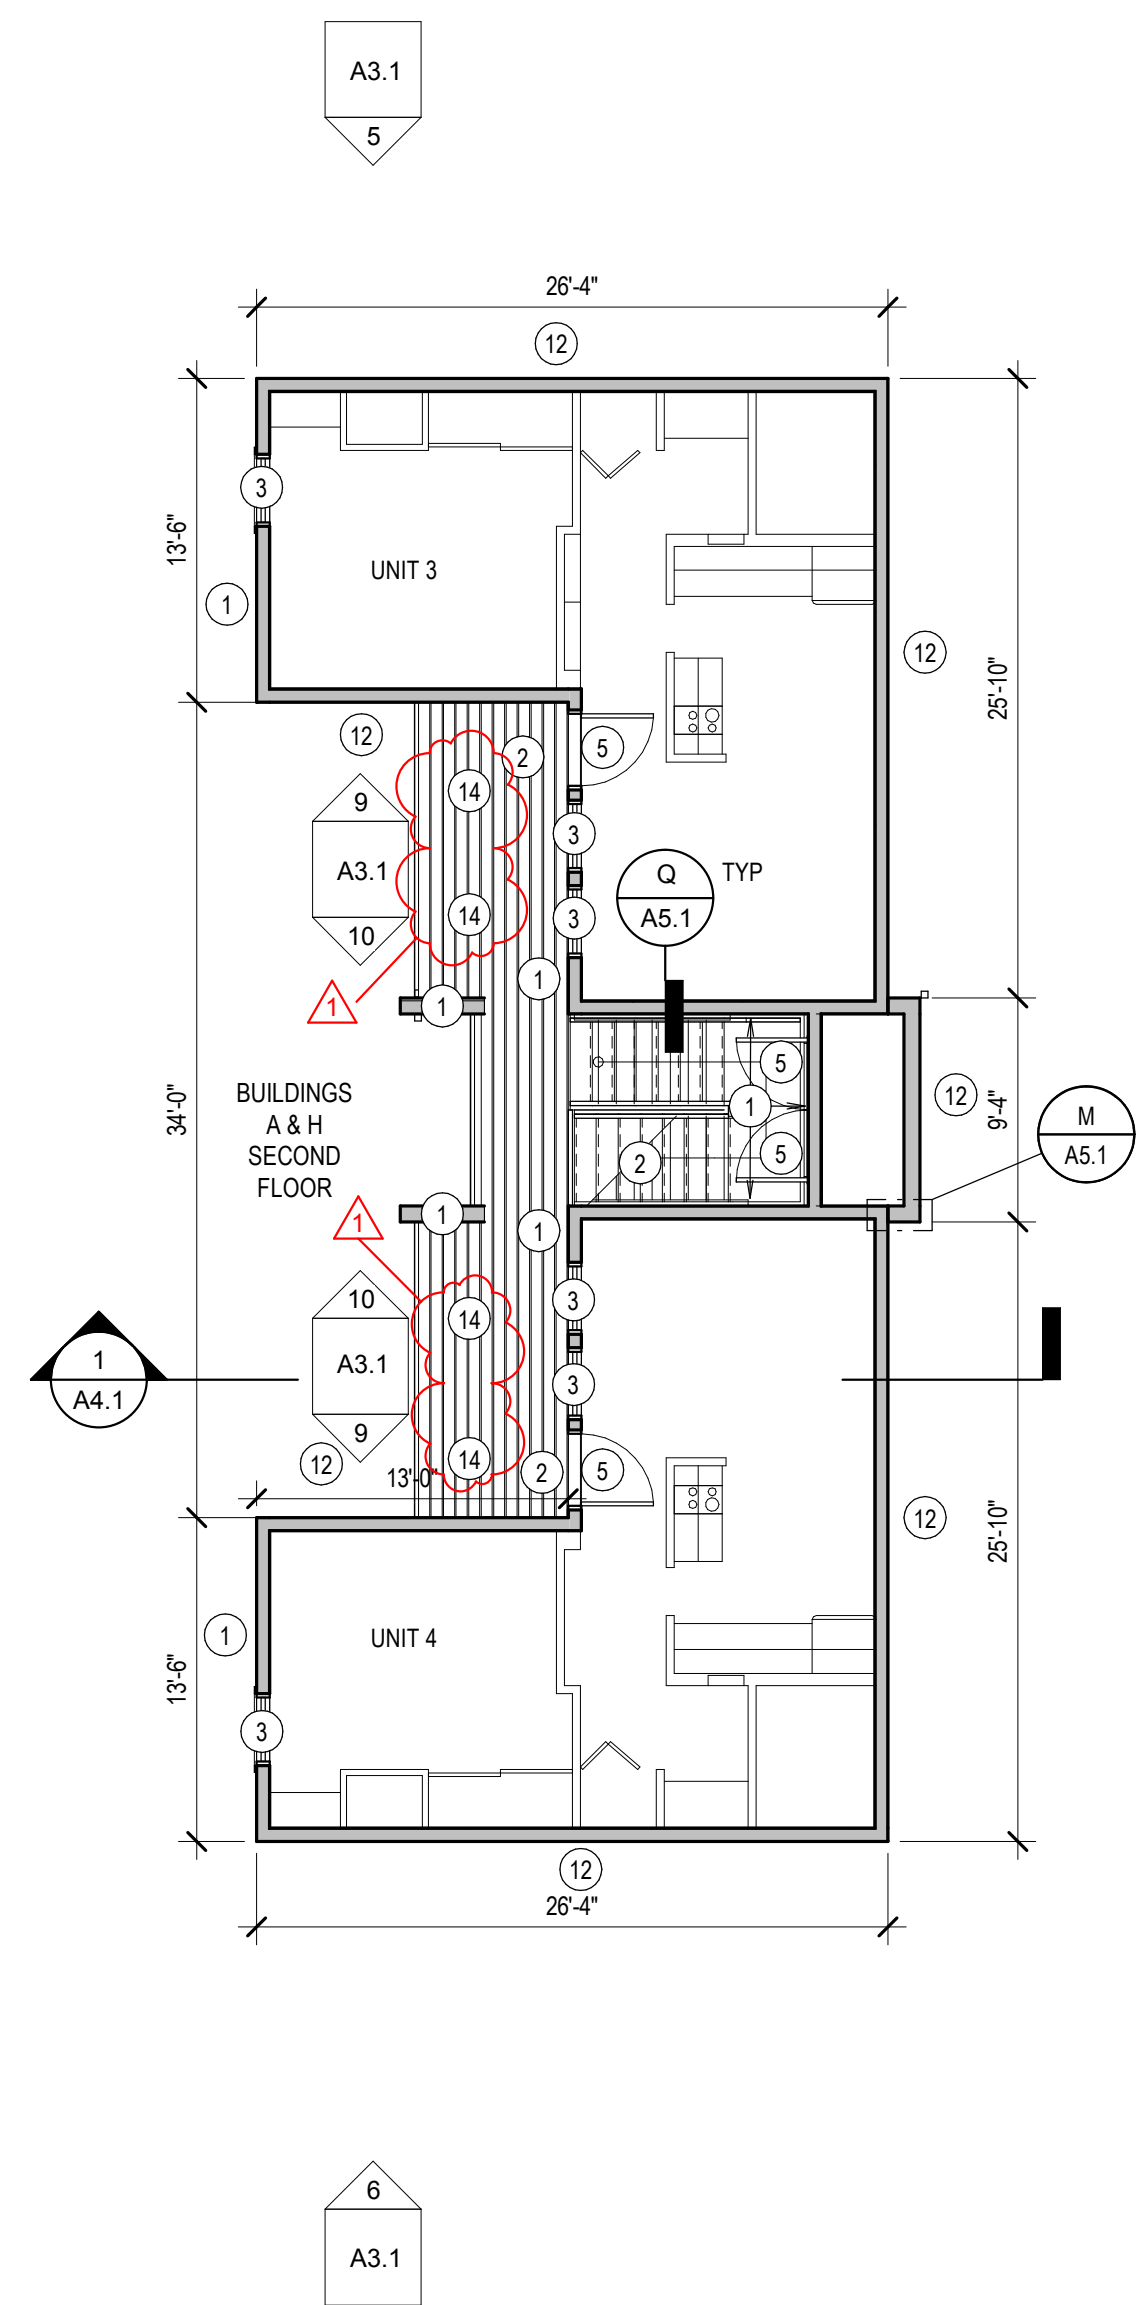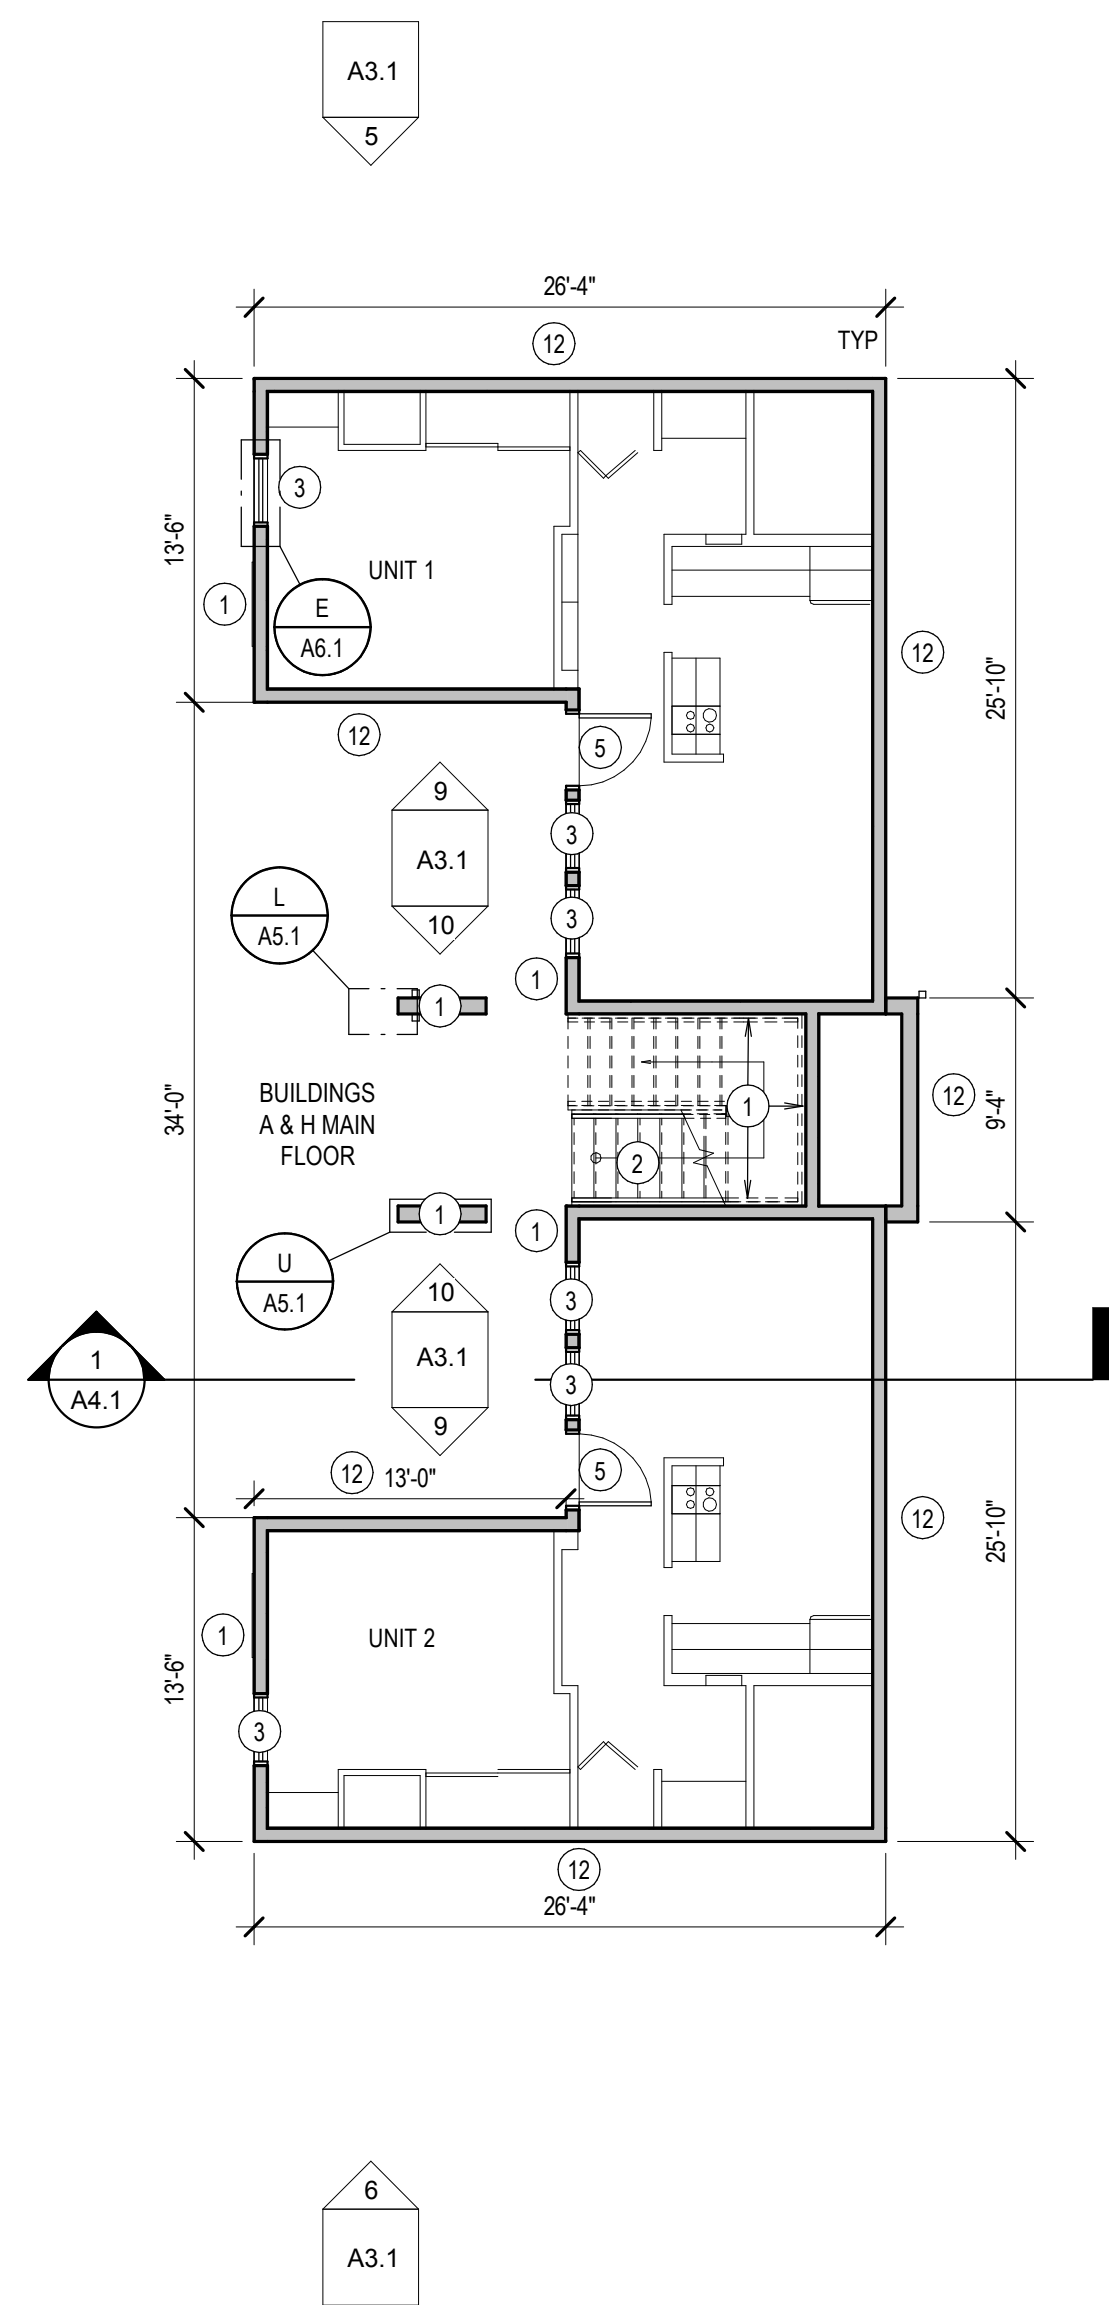
REVISIONS		
1	ADDENDUM #1	10-28-2021

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 CHECKED BY: NBW

DRAWING NO.: AD #1

A2.1
 REVISED 10-29-2021

KEYNOTES	GENERAL NOTES
<ol style="list-style-type: none"> 1 NEW VINYL SIDING - COLOR 1 2 SCRAPE, SAND AND PAINT EXTERIOR WOOD DECK, RAILING, STAIRS AND SOFFIT. THIS IS TO INCLUDE THE UNDERSIDE OF THE DECK AND ANY ASSOCIATED STRUCTURE. TAPE OFF AND PAINT AROUND LIGHT FIXTURES ON THE SOFFIT AND UNDERSIDE OF DECKING. ALL ASSOCIATED CONDUIT TO BE PAINTED TO MATCH SURROUNDING MATERIAL. 3 WINDOWS IN EVERY BUILDING TO BE REPLACED. REPLACE WOOD SILL ON THE INTERIOR OF WINDOW. WHERE DETERIORATED OR DAMAGED GYPSUM IS FOUND REPLACE GYPSUM WITH NEW - FINISH TO MATCH EXISTING WALLS. SEE SHEET A6.1 FOR DETAILS 4 EXISTING METAL RAILING, HANDRAIL AND WALL MOUNTED BRACKETS AT BLDG H TO BE CLEANED, SANDED AND PAINTED 5 EXISTING METAL DOORS AND FRAMES TO BE CLEANED, SANDED AND PAINTED BOTH INTERIOR AND EXTERIOR 6 NEW PREFINISHED PARAPET CAP 7 EXISTING MEMBRANE ROOFING TO BE CUT BACK AT THESE LOCATIONS TO ALLOW NEW SIDING TO BE INSTALLED. NEW MEMBRANE ROOFING TO OVERLAP EXISTING MEMBRANE ROOFING. SEE DETAILS ON SHEET A6.1. 8 NEW PREFINISHED GUTTERS, DOWNSPOUTS AND SCUPPERS 9 LOCATIONS FOR FUTURE PTAC UNITS - OWNER FURNISHED AND INSTALLED 10 NEW EXHAUST VENT CAP TO BE FAMCO 4" GALVANIZED HOODED WALL VENT WITH SPRING LOADED DAMPER GASKET AND SCREEN-PAINTED 11 NEW PREFINISHED METAL WALL LOUVER 12 NEW VINYL SIDING - COLOR 2 13 LIGHTING ATTACHED TO WALL NEEDS TO BE REMOVED AND REATTACHED AFTER VINYL SIDING INSTALLATION 14 NEW PREFINISHED METAL SOFFIT LOUVER 	<ol style="list-style-type: none"> 1 CONTRACTOR SHALL RESOLVE ALL DIMENSIONAL OR OTHER DISCREPANCIES, DURING LAYOUT WITH ARCHITECT, PRIOR TO BEGINNING CONSTRUCTION. 2 WORK TO BE IN ACCORDANCE WITH CODES & ACCESSIBILITY REQUIREMENTS. 3 USE ISOLATION TAPE BETWEEN DIS-SIMILAR METALS. 4 PENETRATIONS TO BE SEALED AND WATERPROOFED. 5 CONTRACTOR TO FIELD VERIFY ALL SIZES FOR LOUVERS AND VENTS

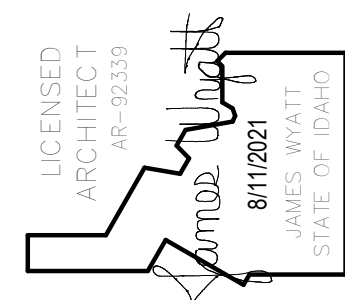

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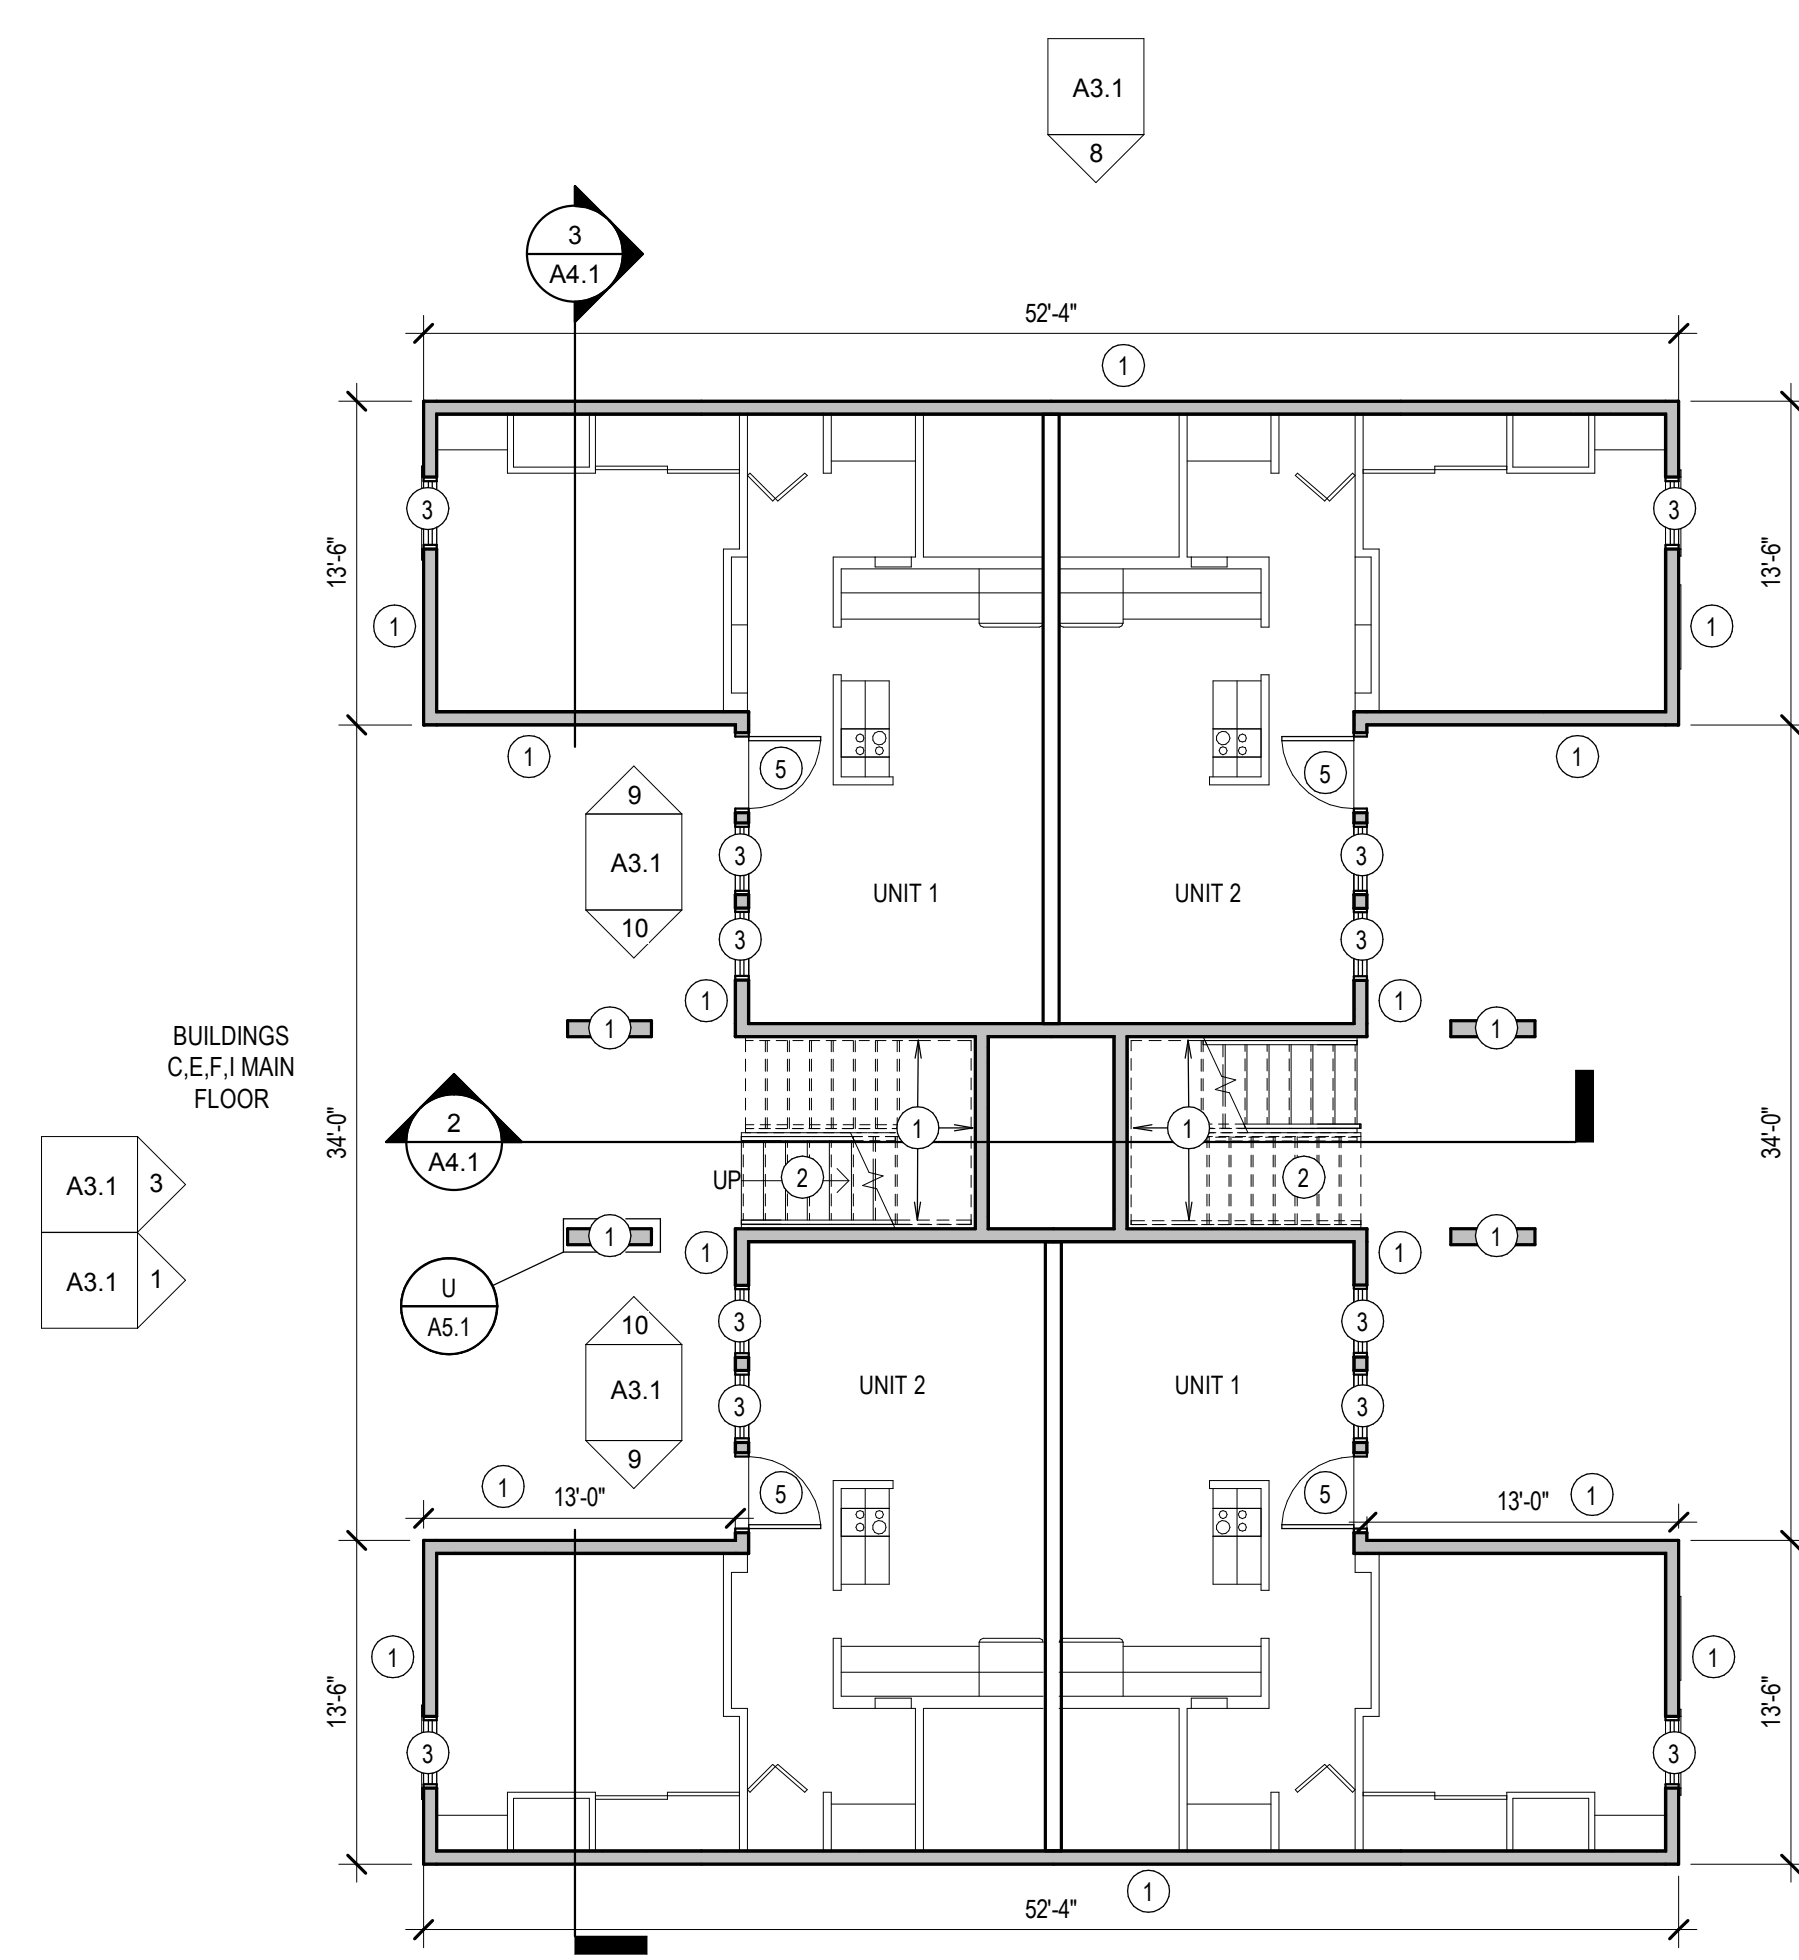
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REVISIONS	ADDENDUM #	DATE
1		10-29-2021


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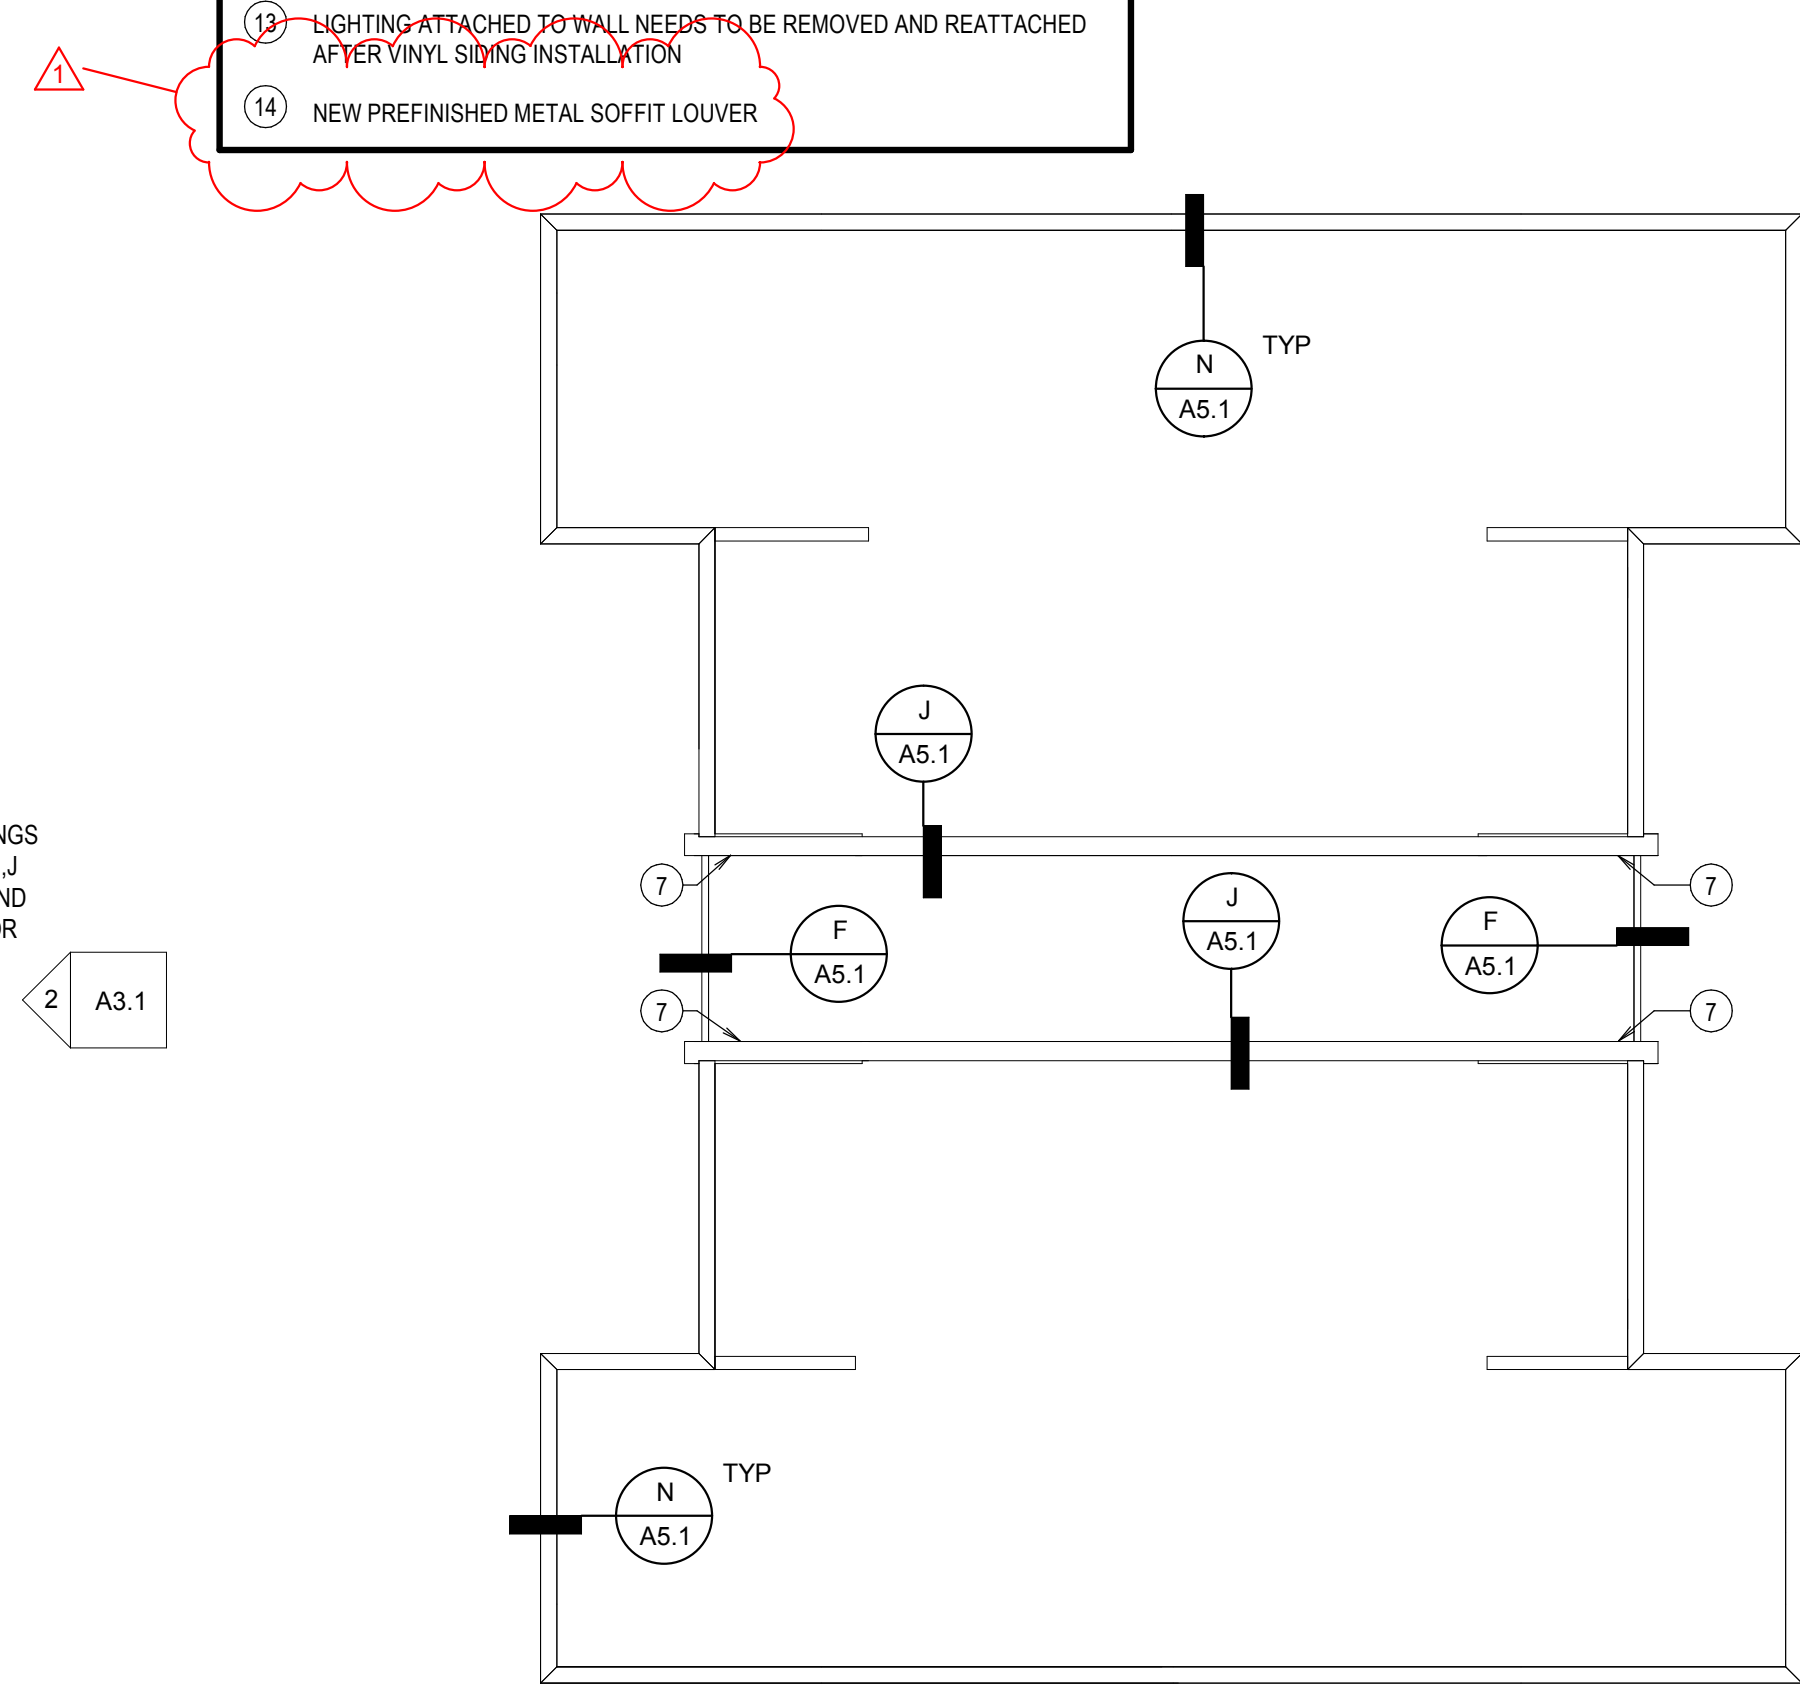
A2.2
 REVISED 10-29-2021



MAIN LEVEL FLOOR PLAN
 SCALE: 1/8" = 1'-0"



SECOND LEVEL FLOOR PLANS
 SCALE: 1/8" = 1'-0"

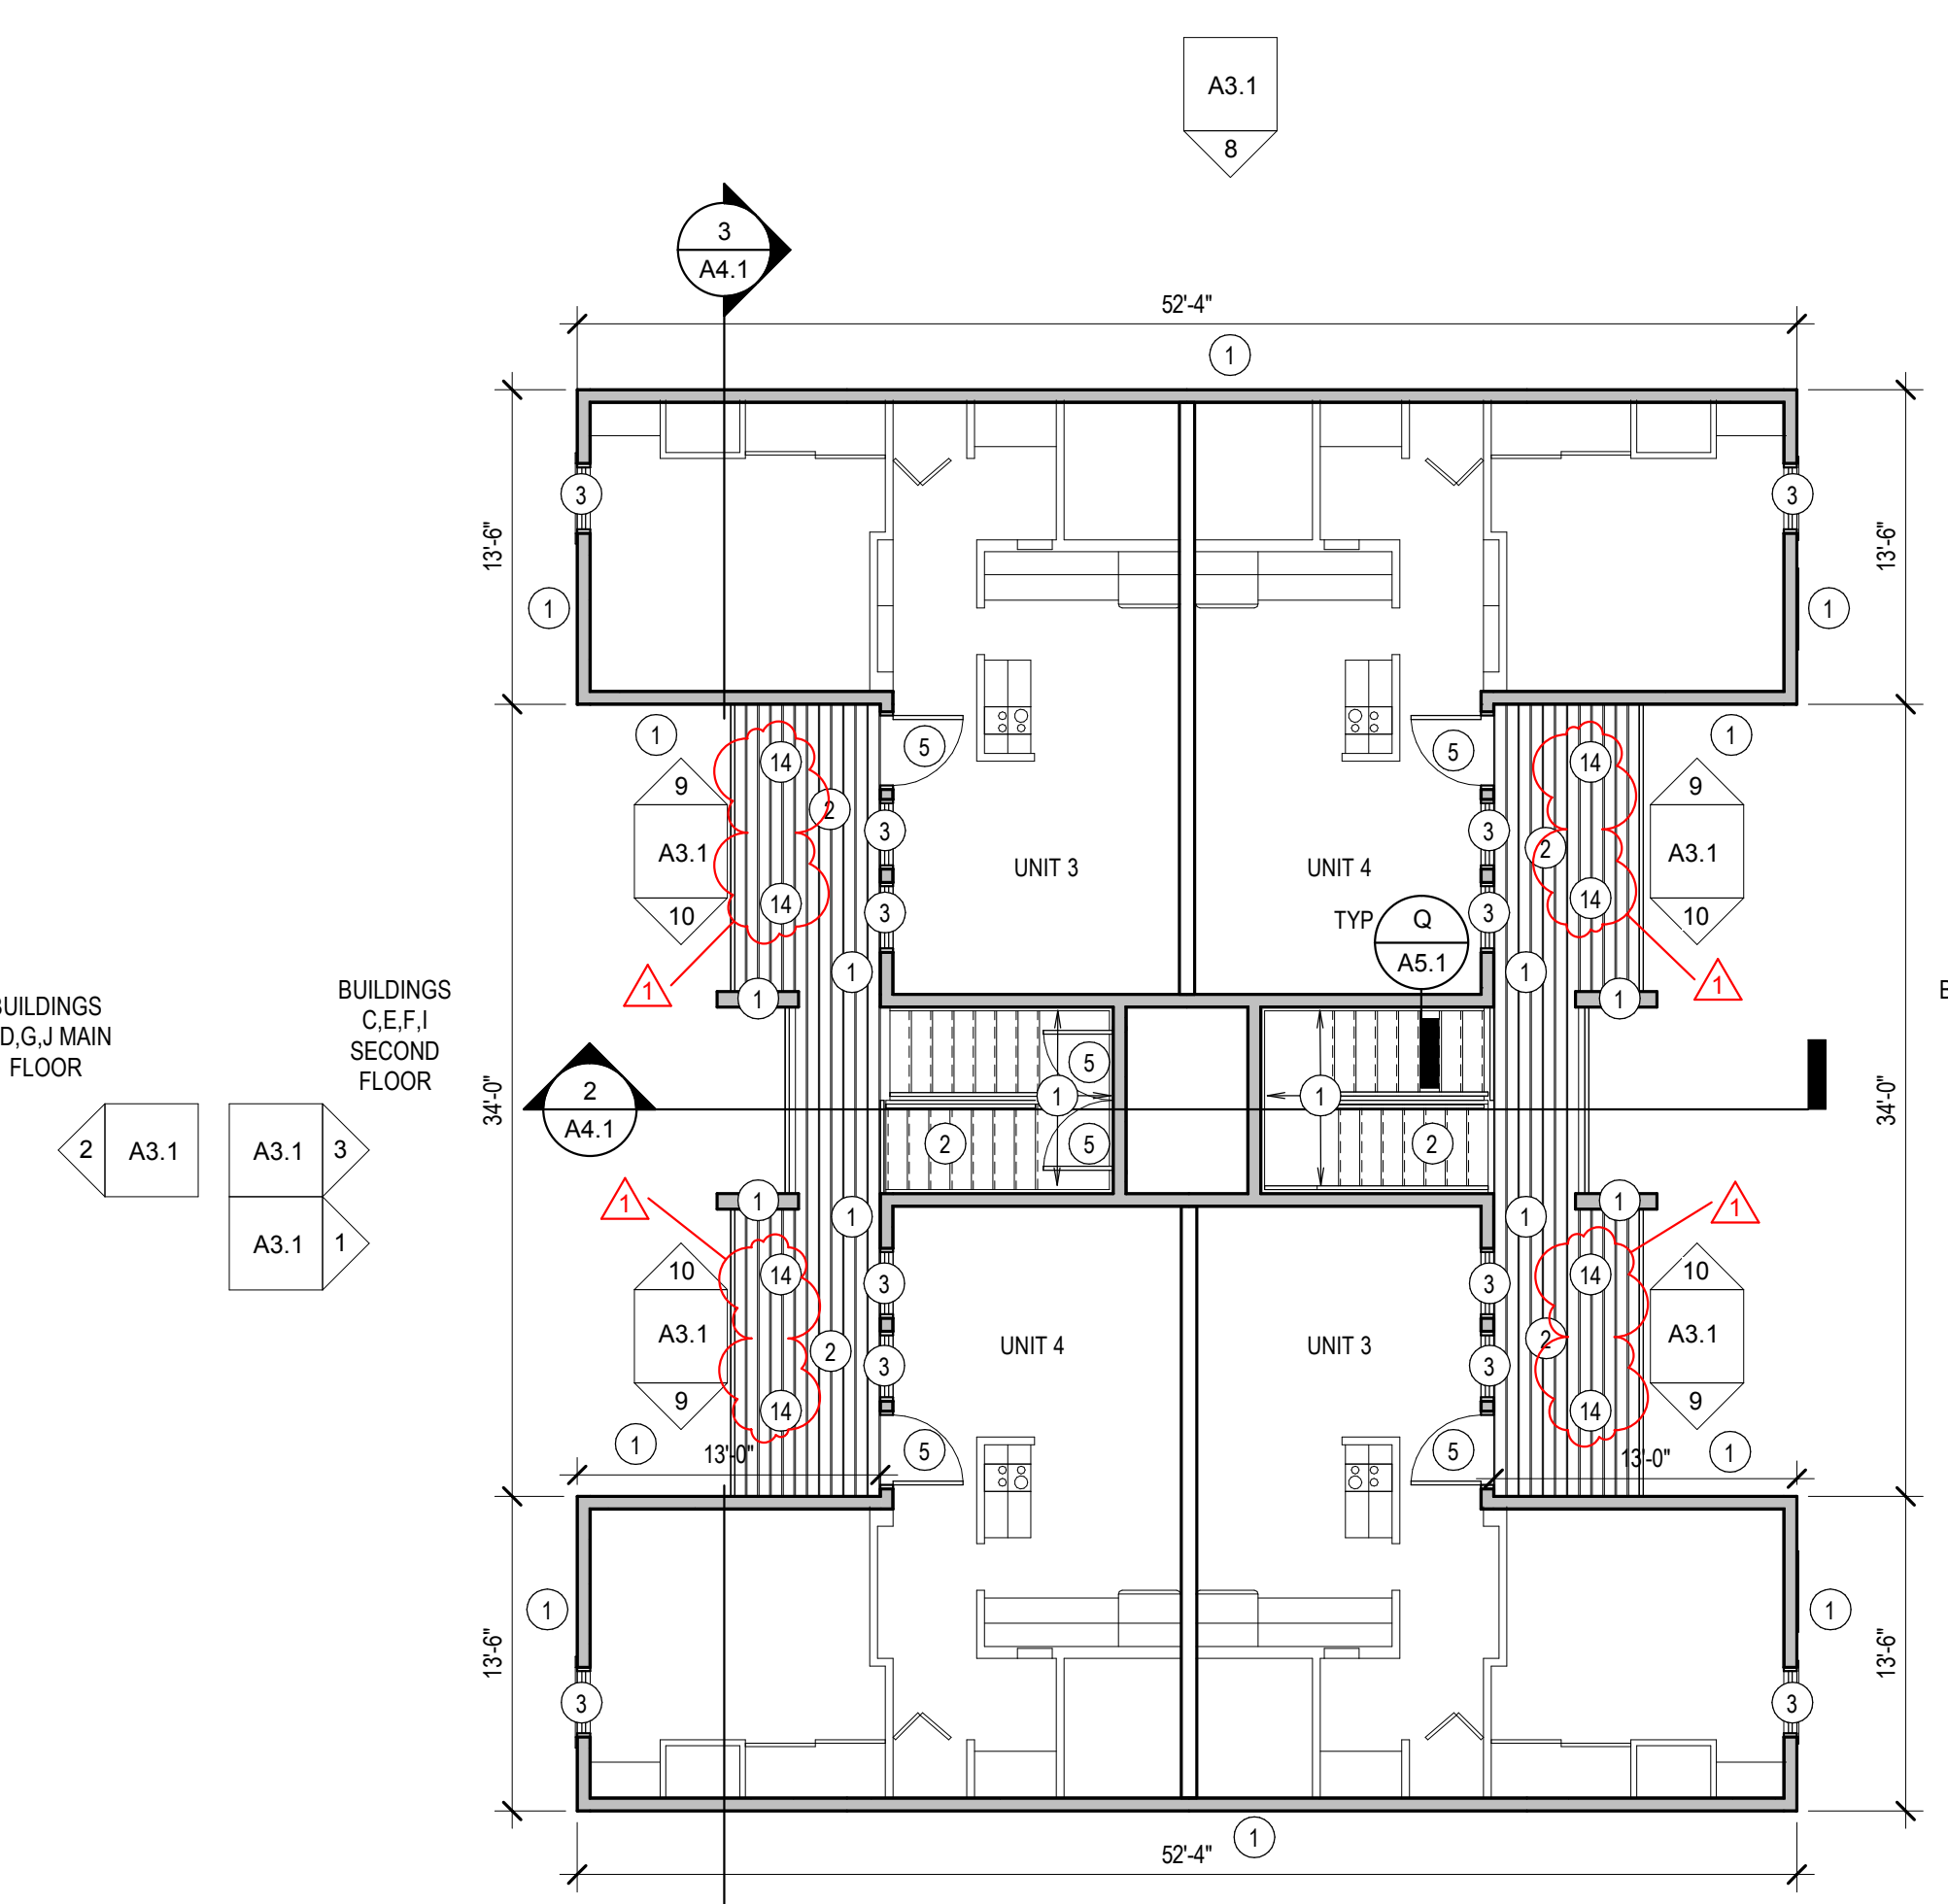

ROOF PLAN
 SCALE: 1/8" = 1'-0"