



IDVS: REMODEL STAFF LOUNGE, VET-P

IDAHO STATE VETERANS HOME

1957 ALVIN RICKEN DRIVE - POCATELLO, IDAHO

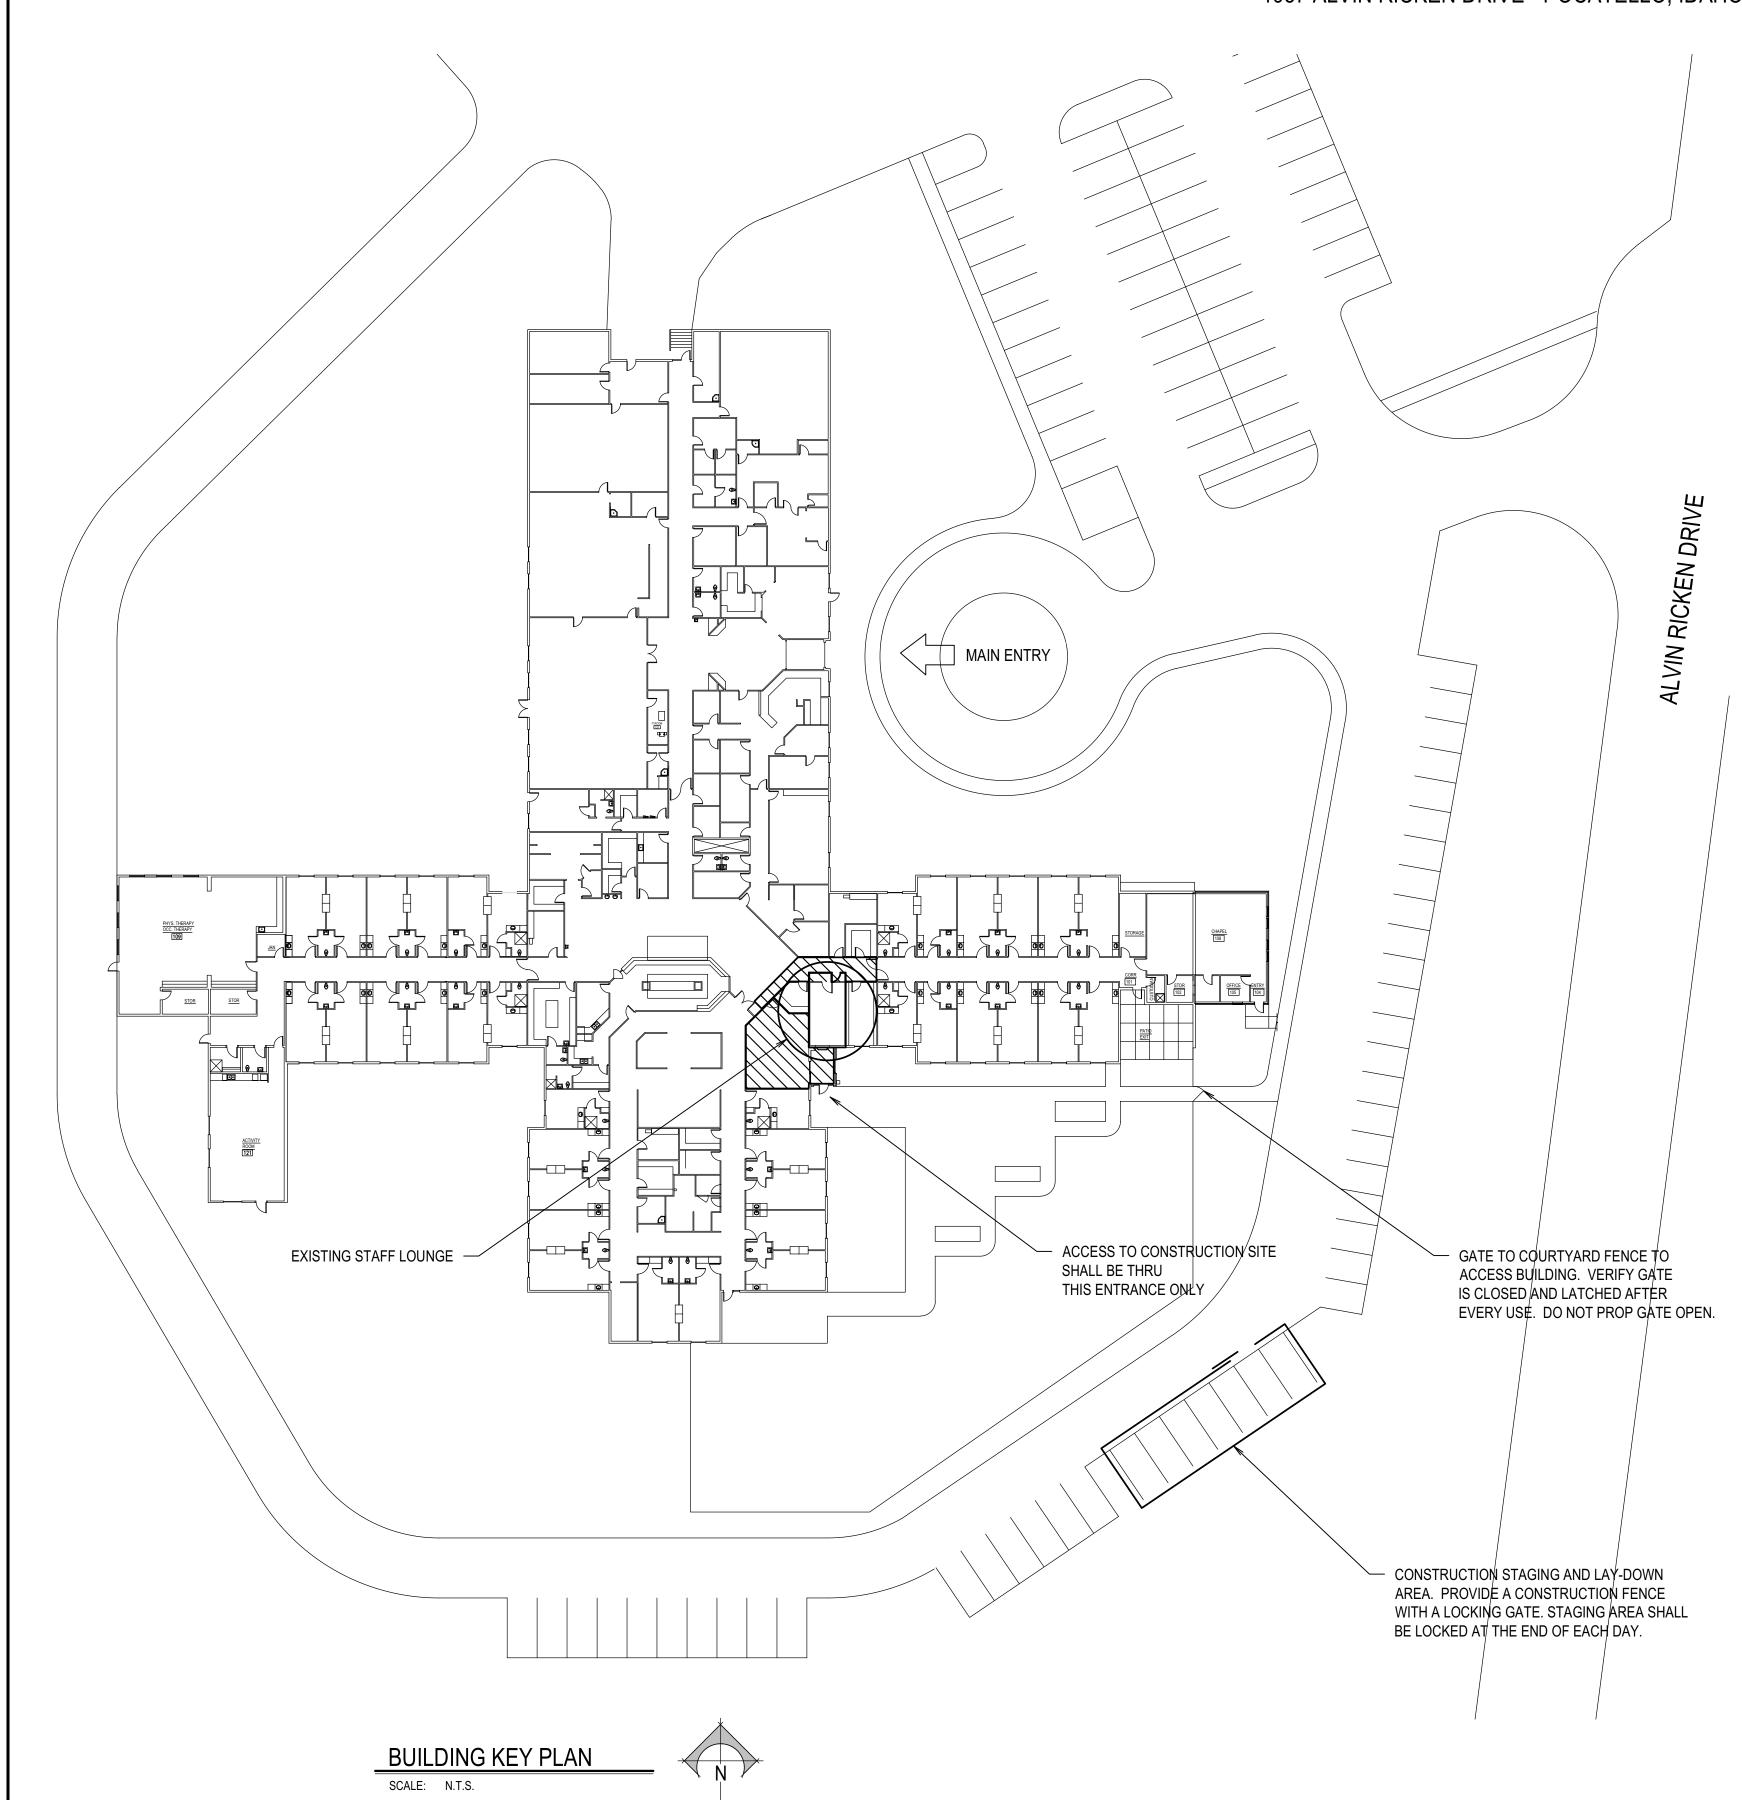

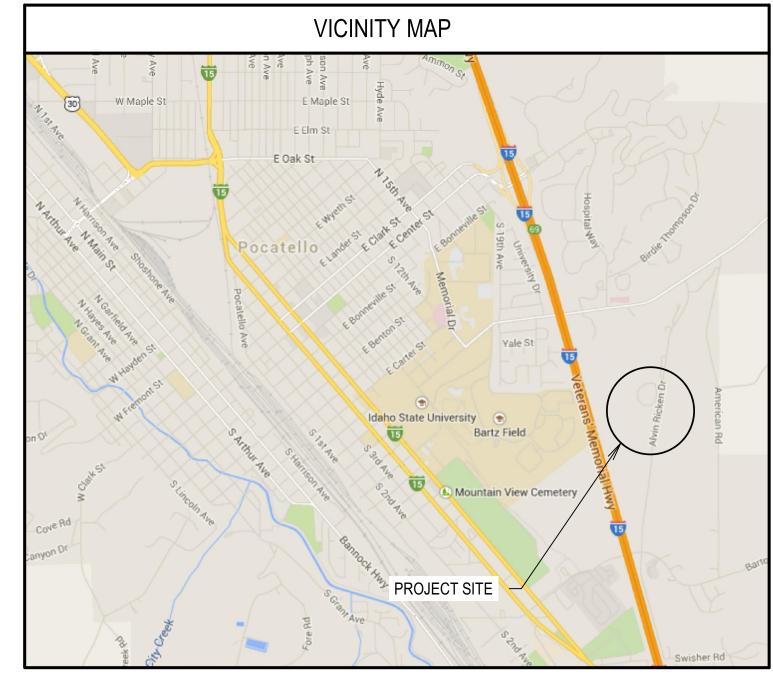

GENERAL NOTES

- PROVIDE PHYSICAL BARRIERS WITH WOOD STUDS, 10 MILL VISQUEEN AND 1/2" PLYWOOD TO SEPARATE THE CONSTRUCTION AREAS FROM THE REST OF THE BUILDING. DOOR TO CONTAINMENT AREA NEEDS TO BE LOCKABLE.

 NEGATIVE AIR PRESSURE SHALL BE MAINTAINED AT ALL TIMES DURING
- CONSTRUCTION ACTIVITIES. COORDINATE DUCTING WITH AGENCY AND DPW.

 PROVIDE SIGNAGE AND PHYSICAL BARRIERS AS REQUIRED TO SEPARATE RESIDENTS AND STAFF FROM CONSTRUCTION ACTIVITIES.

 COORDINATE/SCHEDULED NEW ROOF PENETRATIONS WITH DPW FIELD REPRESENTATIVE. NEW PENETRATIONS SHALL BE WATER TIGHT. SEE DETAIL
- PROTECT FLOOR AREAS FROM CONSTRUCTION ACCESS POINT TO EACH WORK AREA. INSTALL 1/2" PLYWOOD OVER 10 MILL VISQUEEN. TYPICAL AT HATCHED AREA.
- KEEP ALL TOOLS, CONSTRUCTION MATERIALS (NEW AND EXISTING) ETC. OUT OF REACH OF THE RESIDENTS.


CONSULTANTS

MECHANICAL ENGINEERS: ENGINEERED SYSTEMS ASSOCIATES
1355 EAST CENTER
POCATELLO, IDAHO 83201

ELECTRICAL ENGINEERS:

MUSGROVE ENGINEERING, P.A. 645 WEST 25TH STREET IDAHO FALLS, IDAHO 83402 TELEPHONE: (208) 523-2862

TELEPHONE: (208) 233-0501

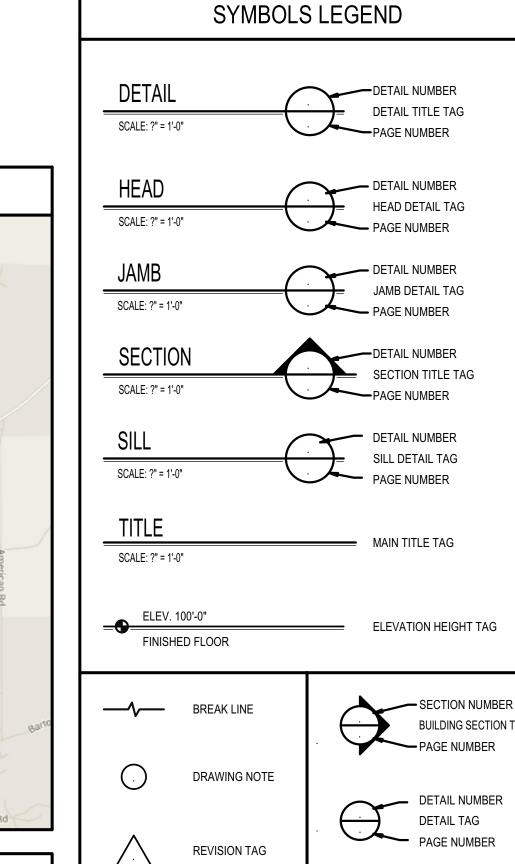


	DRAWING INDEX
	ARCHITECTURAL
A1.1	TITLE SHEET AND INDEX
A2.1	NEW SHOWER ROOM FLOOR PLAN AND DETAILS
A3.1	INTERIOR ELEVATIONS
A4.1	TILE LAY-OUT
	MECHANICAL
MP1.1	MECHANICAL/PLUMBING FLOOR PLANS
	ELECTRICAL
E0.0	ELECTRICAL COVER SHEET
E0.1	LIGHTING COMPLIANCE
DE1.0	DEMOLITION PLANS
E1.0	FIRE ALARM PLAN
E2.0	INSTALLATION PLANS
E3.0	ELECTRICAL DETAILS AND SCHEDULES


WINDOW TAG

WALL TYPE

ROOM NUMBER

- NORTH ARROW

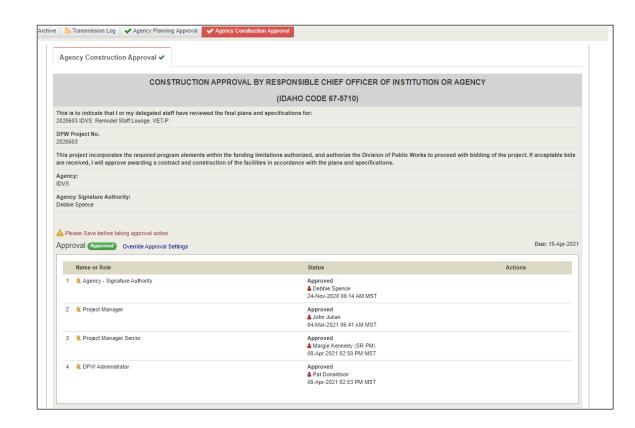

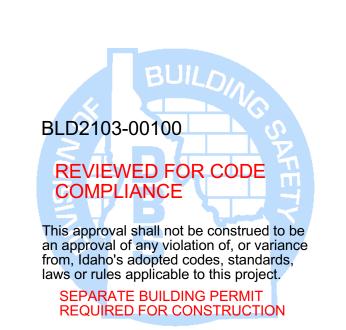

LICENSED ARCHITECT AR-92339

AR-92339

AR-92339

03-03-2021

JAMES WYATT STATE OF IDAHO

THE CTURE PLANNING ALLA. MENNER BODILY, A.I.A. JAMES HWYATT, 1000 INH 9000 MR POR BODILY, A.I.A. JAMES HWYATT, 1000 INH 9000 MR POR 2212 - INDHI FOILS INDHI 83402-2212

TAFF LOUNGE, VE
E VETERANS HOME

DRIVE - POCATELLO, IDAHO

IDAHO STATE VETI 1957 ALVIN RICKEN DRIVE


SHEET TITLE:

REVISIONS

PROJECT NO.:
19027
DATE:
MARCH 2021
DRAWN BY:
KP
CHECKED BY:

DRAWING NO.:

A1.1

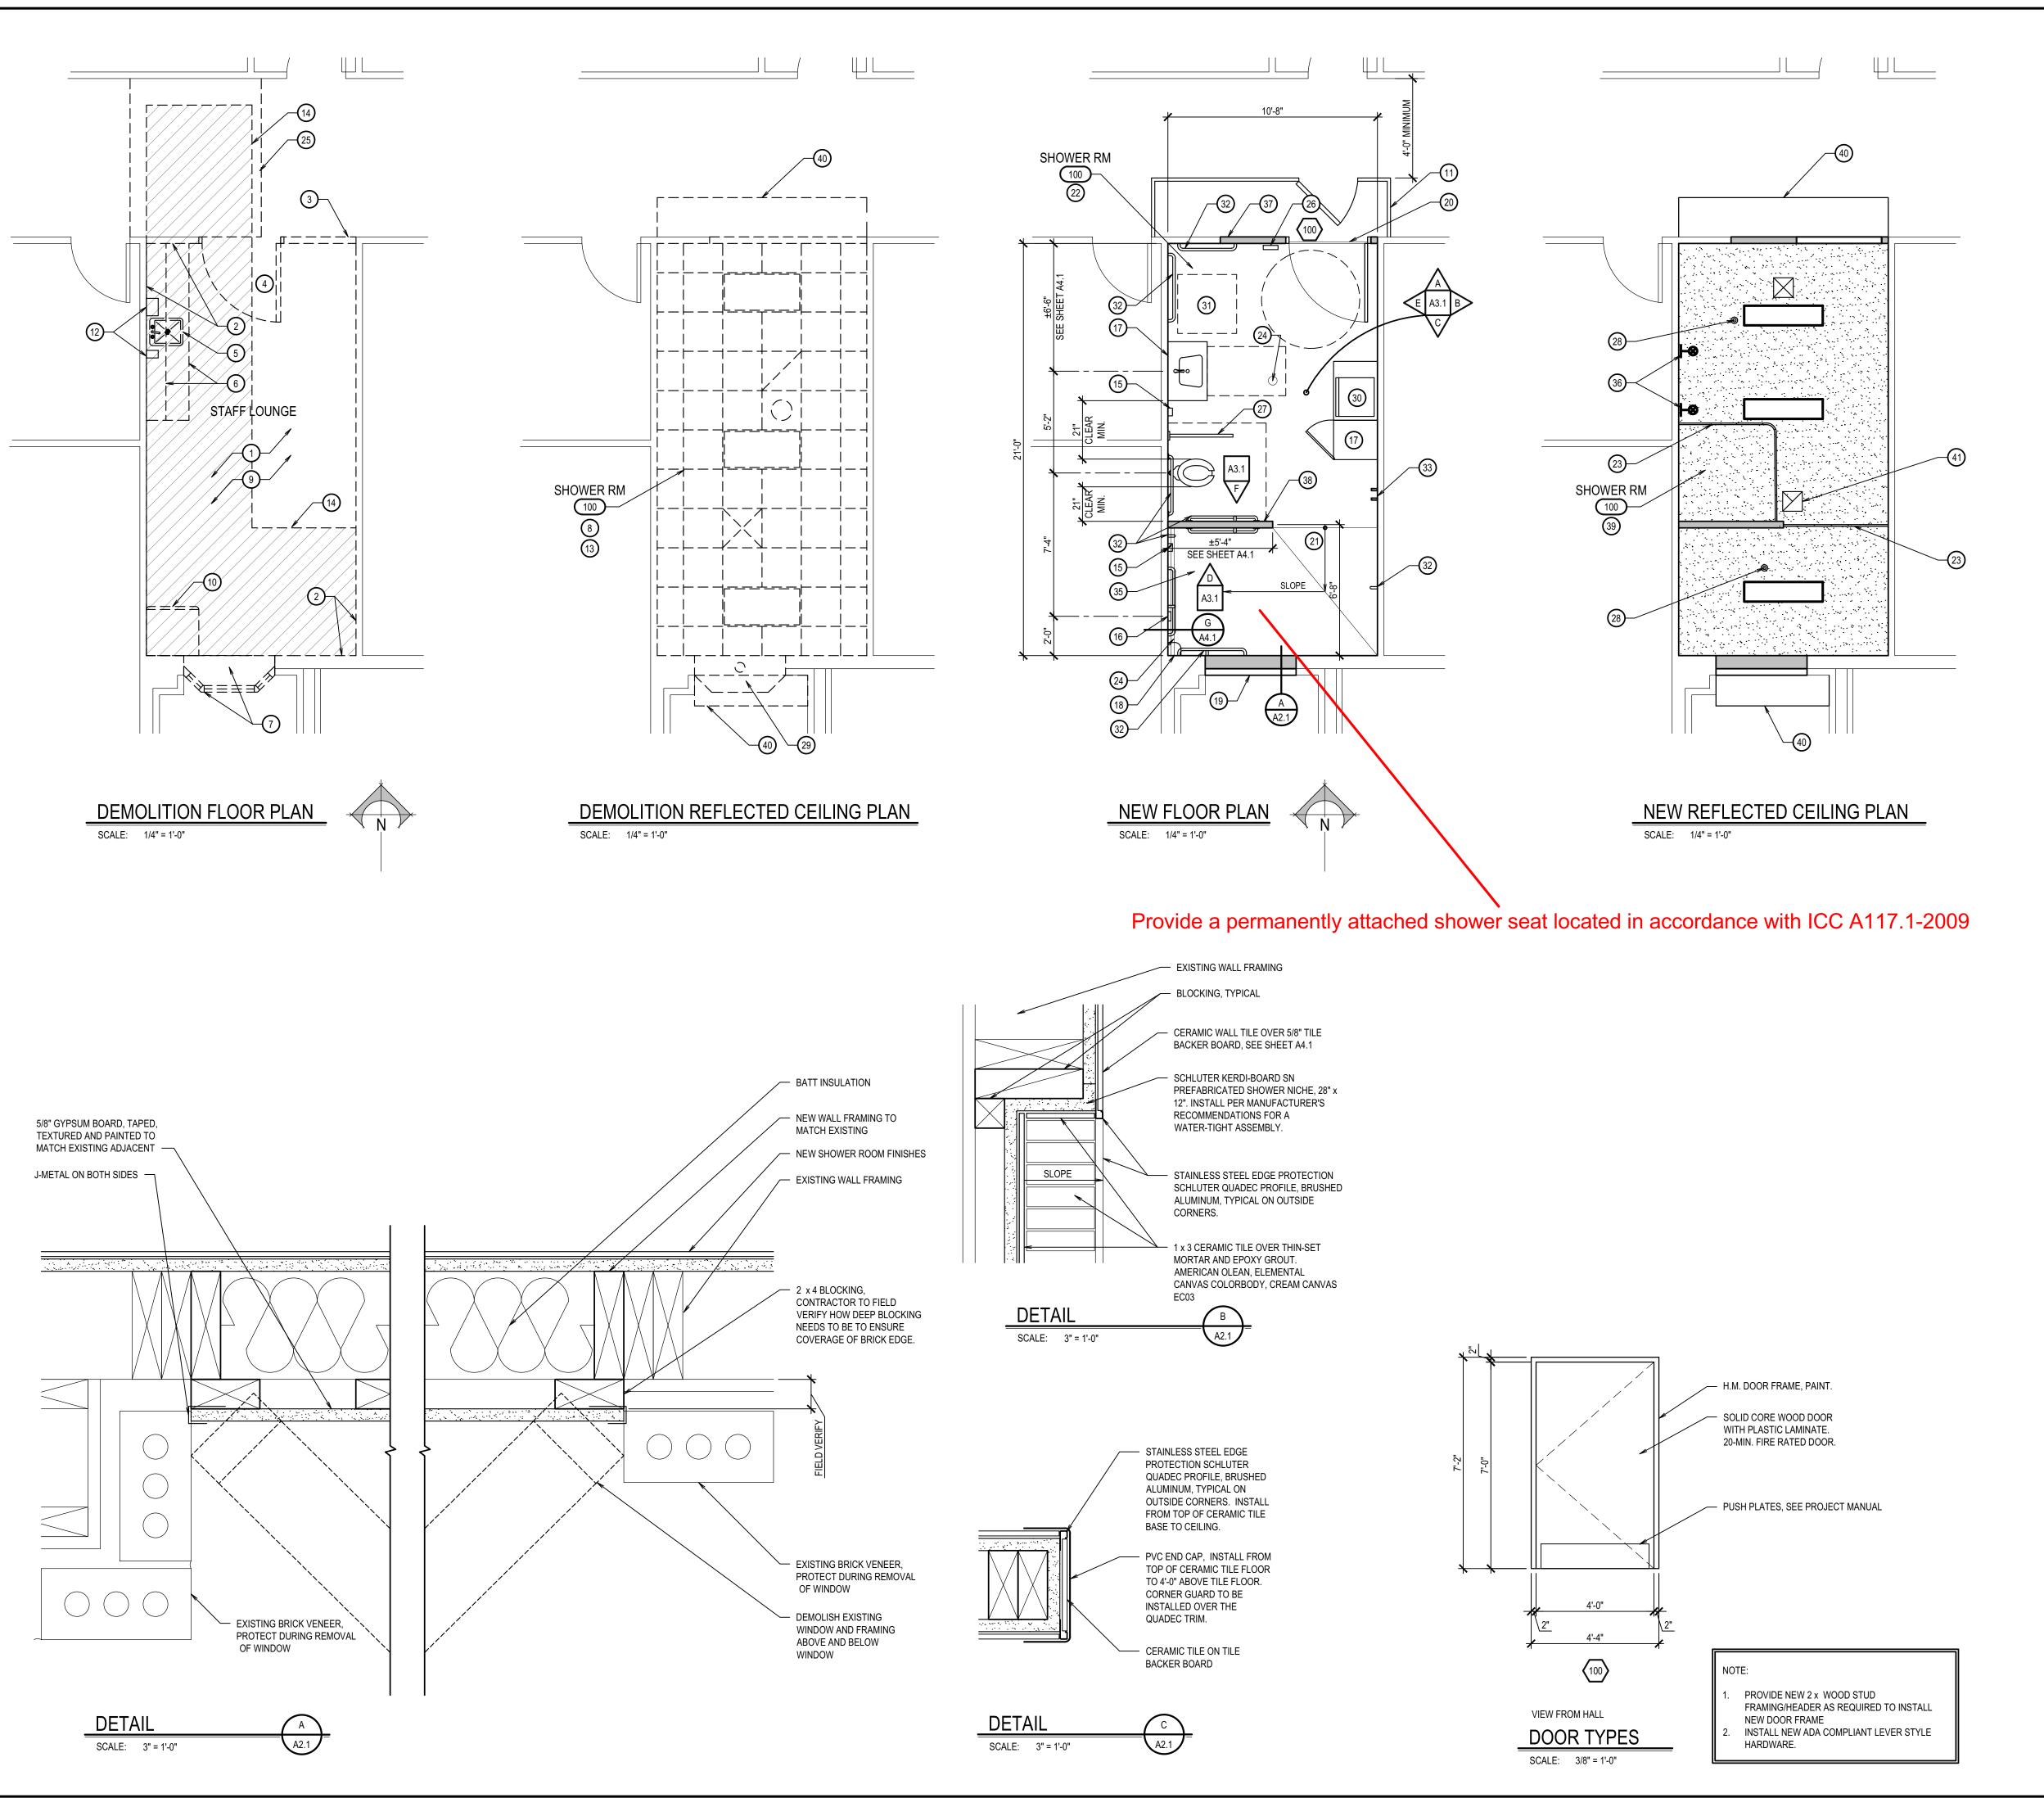

GENERAL NOTES

5/8" TILE BACKER BOARD (SCHLUTER-KERDI BOARD OR APPROVED EQUAL) TO BE INSTALLED FULL HEIGHT ON ALL WALLS. INSTALL PER MANUFACTURER'S RECOMMENDATIONS FOR A WATER-TIGHT ASSEMBLY.

O KEYNOTES

- REMOVE VINYL FLOORING, ADHESIVES, BASE ETC. DOWN TO EXISTING CONCRETE FLOOR. PREPARE FOR NEW TILE.
- REMOVE CHAIR RAIL AND GYPSUM BOARD COMPLETE DOWN TO EXISTING
- REMOVE WALL TO EXTENT SHOWN AS REQUIRED FOR NEW CONSTRUCTION. PROTECT EXISTING TO REMAIN WALL BUMPERS, CHAIR RAIL, LAMINATE WAINSCOT AND RUBBER BASE. SALVAGE WALL BUMPERS, CHAIR RAIL, LAMINATE WAINSCOT AND RUBBER BASE FOR RE-INSTALLATION ON NEW WALL
- REMOVE EXISTING DOOR, DOOR FRAME AND HARDWARE
- REMOVE FAUCET, SINK AND ASSOCIATED PLUMBING.
- REMOVE BASE AND UPPER CASEWORK COMPLETE.
- REMOVE WINDOW, WINDOW SILL AND WALL FRAMING ASSOCIATED WITH THE BAY WINDOW COMPLETE. SALVAGE EXISTING RUBBER BASE AND SAVE FOR
- REMOVE EXISTING LIGHT FIXTURES AND GRILLES
- REMOVE EXISTING ELECTRICAL DEVICES. SEE ELECTRICAL DRAWINGS FOR EXTENT OF WORK.
- REMOVE REFRIGERATOR AND TURN OVER TO AGENCY.
- DUST CONTAINMENT SYSTEM. SEE GENERAL NOTE 2 ON SHEET A1.1.
- REMOVE EXISTING TOWEL AND SOAP DISPENSER AND TURN OVER TO AGENCY. REMOVE EXISTING LAY-IN CEILING PANELS AND GRID SYSTEM COMPLETE.
- SAW-CUT EXISTING CONCRETE FLOOR AS REQUIRED TO INSTALL NEW DRAIN
- SYSTEM. PLACE NEW CONCRETE WHERE EXISTING IS REMOVED. PREPARE CONCRETE TO RECEIVE FLOOR TILE IN SHOWER ROOM AND CARPET IN
- INSTALL NURSE CALL BUTTON S. SHOWER CONTROLS
- NEW CASEWORK
- B. CORNER SHELVES
- INFILL OPENING WITH WOOD STUDS TO MATCH ADJACENT WALL CONSTRUCTION. INSTALL BATT INSULATION. ON VESTIBULE SIDE: INSTALL GYPSUM BOARD ON BLOCKING, TAPE, TEXTURE AND PAINT TO MATCH EXISTING ADJACENT WALLS. SEE DETAIL A/A2.1. RE-USE EXISTING BASE.
- . SLOPE FLOOR TO NEW DRAIN. 1/8"/FT MIN.

INSTALL "SCHLUTER" TRANSITION STRIP.

- 22. FLOOR TILE ON SLAB, SEE SHEET A4.1
- 23. CURTAIN TRACK SYSTEM
- 4. NEW FLOOR DRAIN
- . EXISTING CARPET NEEDS TO BE SALVAGED. CUT EXISTING CARPET AND PULL I BACK. RE-GLUE CARPET BACK DOWN AFTER SAW CUTTING IS COMPLETE.
- . INSTALL NEW AUTOMATIC DOOR OPERATOR. VERIFY OPERATOR FUNCTIONS PROPERLY.
- 7. FLIP-UP GRAB BAR
- B. EXISTING FIRE SPRINKLER HEAD TO REMAIN. ADJUST HEIGHT OF FIRE SPRINKLER HEADS AS REQUIRED FOR NEW CEILING HEIGHT.
- O. REMOVE EXISTING GYPSUM BOARD CEILING AND LIGHT FIXTURE IN BAY
- 0. REACH IN BLANKET WARMER, SUMMIT PTHC65G 4.5 CU FT
- . NEW SCALE BY OWNER
- 32. NEW GRAB BAR, SEE SHEET A3.1
- 33. PROVIDE (2) ROBE HOOKS AND INSTALL AS DIRECTED BY THE AGENCY
- 34. PVC END CAP. ADHERE TO NEW TILE WITH SILICON. SEE DETAIL C/A2.1.
- 5. FLOOR TILE INSTALLED OVER WATERPROOF MEMBRANE AND SETTING BED. SLOPE SETTING BED TO DRAIN AS SHOWN. SEE SHEET A4.1.
- 36. WALL MOUNTED LIGHT FIXTURE
- . INFILL OPENING WITH WOOD STUDS TO MATCH ADJACENT WALL CONSTRUCTION. INSTALL BATT INSULATION. ON CORRIDOR SIDE: INSTALL GYPSUM BOARD, TAPE, TEXTURE AND PAINT TO MATCH EXISTING ADJACENT WALL. RE-INSTALL SALVAGED CHAIR RAIL, BUMPERS, PLASTIC LAMINATE WAINSCOT AND RUBBER BASE TO MATCH EXISTING ADJACENT WALL. MODIFY WALL BUMPERS AS REQUIRED.
- INSTALL 2 x 4 WOOD STUD WALL WITH 5/8" TILE BACKER BOARD AND CERAMIC TILE. EXTEND WALL TO STRUCTURE ABOVE. PROVIDE BLOCKING IF REQUIRED.
- INSTALL NEW SUSPENDED GYPSUM BOARD CEILING. TAPE, TEXTURE AND PAINT
- PARTIALLY REMOVE, PATCH AND REPAIR EXISTING CEILING AS REQUIRED BY NEW CONSTRUCTION. CONTRACTOR TO FIELD VERIFY TYPE OF EXISTING CEILING IN THESE SPACES.
- . SEE DETAIL H/A4.1 FOR NEW EXHAUST FAN ROOF CURB

Final State Fire Marshal approval based upon on-site inspection for adherence to the 2018 International Fire Code and referenced standards.



P.O. BOK 221 (F) 208-522-

FOUNG!


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REVISIONS

PROJECT NO .: 19027 MARCH 2021 DRAWN BY: KP CHECKED BY:

DRAWING NO.:



GENERAL NOTES

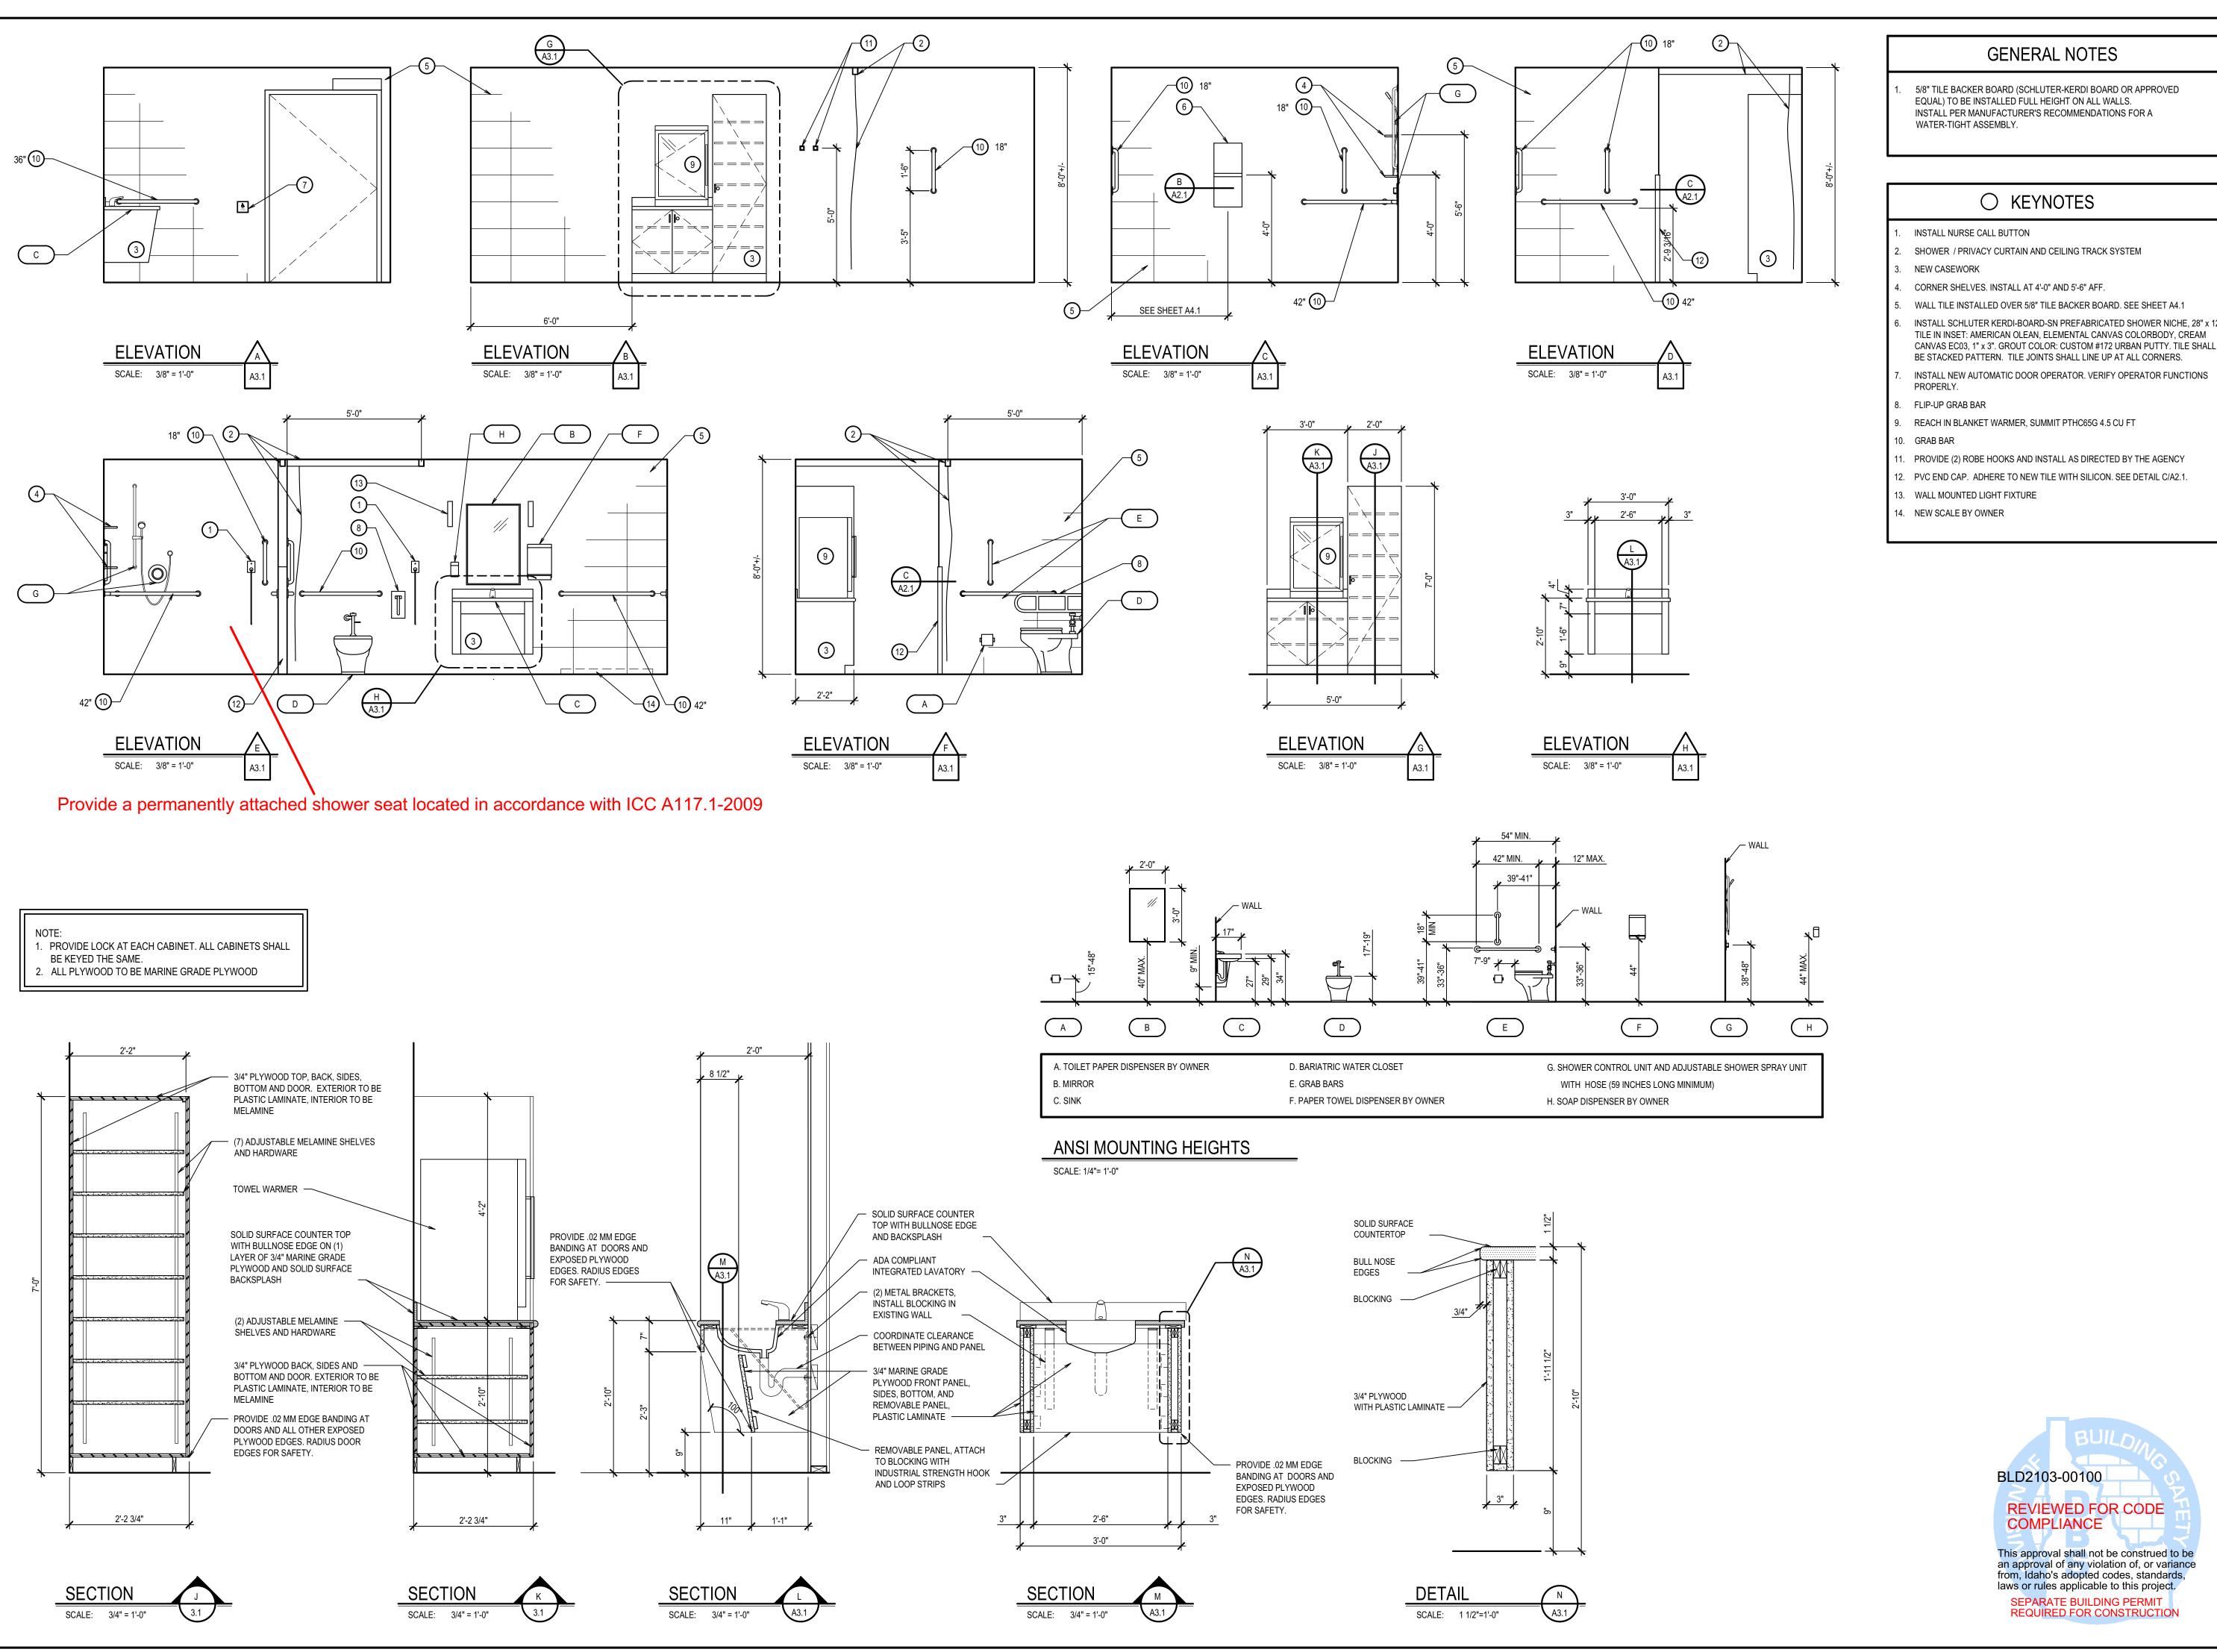5/8" TILE BACKER BOARD (SCHLUTER-KERDI BOARD OR APPROVED EQUAL) TO BE INSTALLED FULL HEIGHT ON ALL WALLS. INSTALL PER MANUFACTURER'S RECOMMENDATIONS FOR A WATER-TIGHT ASSEMBLY.

KEYNOTES

- INSTALL NURSE CALL BUTTON
- SHOWER / PRIVACY CURTAIN AND CEILING TRACK SYSTEM
- CORNER SHELVES. INSTALL AT 4'-0" AND 5'-6" AFF.
- TILE IN INSET: AMERICAN OLEAN, ELEMENTAL CANVAS COLORBODY, CREAM CANVAS EC03, 1" x 3". GROUT COLOR: CUSTOM #172 URBAN PUTTY. TILE SHALL BE STACKED PATTERN. TILE JOINTS SHALL LINE UP AT ALL CORNERS.
- REACH IN BLANKET WARMER, SUMMIT PTHC65G 4.5 CU FT
- PROVIDE (2) ROBE HOOKS AND INSTALL AS DIRECTED BY THE AGENCY
- . PVC END CAP. ADHERE TO NEW TILE WITH SILICON. SEE DETAIL C/A2.1.
- . WALL MOUNTED LIGHT FIXTURE

- Algert

P.O. BOK 2212 - IDA (F) 208-522-8785 (I

- 20-603 **- LOUNGE**, SJECT NO. 2
TAFF

K

DPW P

EMODEL

IDAHO ST

1957 ALVIN RICKE

S

REVISIONS

PROJECT NO.:

19027 DATE: MARCH 2021 DRAWN BY: KP CHECKED BY:


DRAWING NO.:

REVIEWED FOR CODE

This approval shall not be construed to be

SEPARATE BUILDING PERMIT REQUIRED FOR CONSTRUCTION

COMPLIANCE

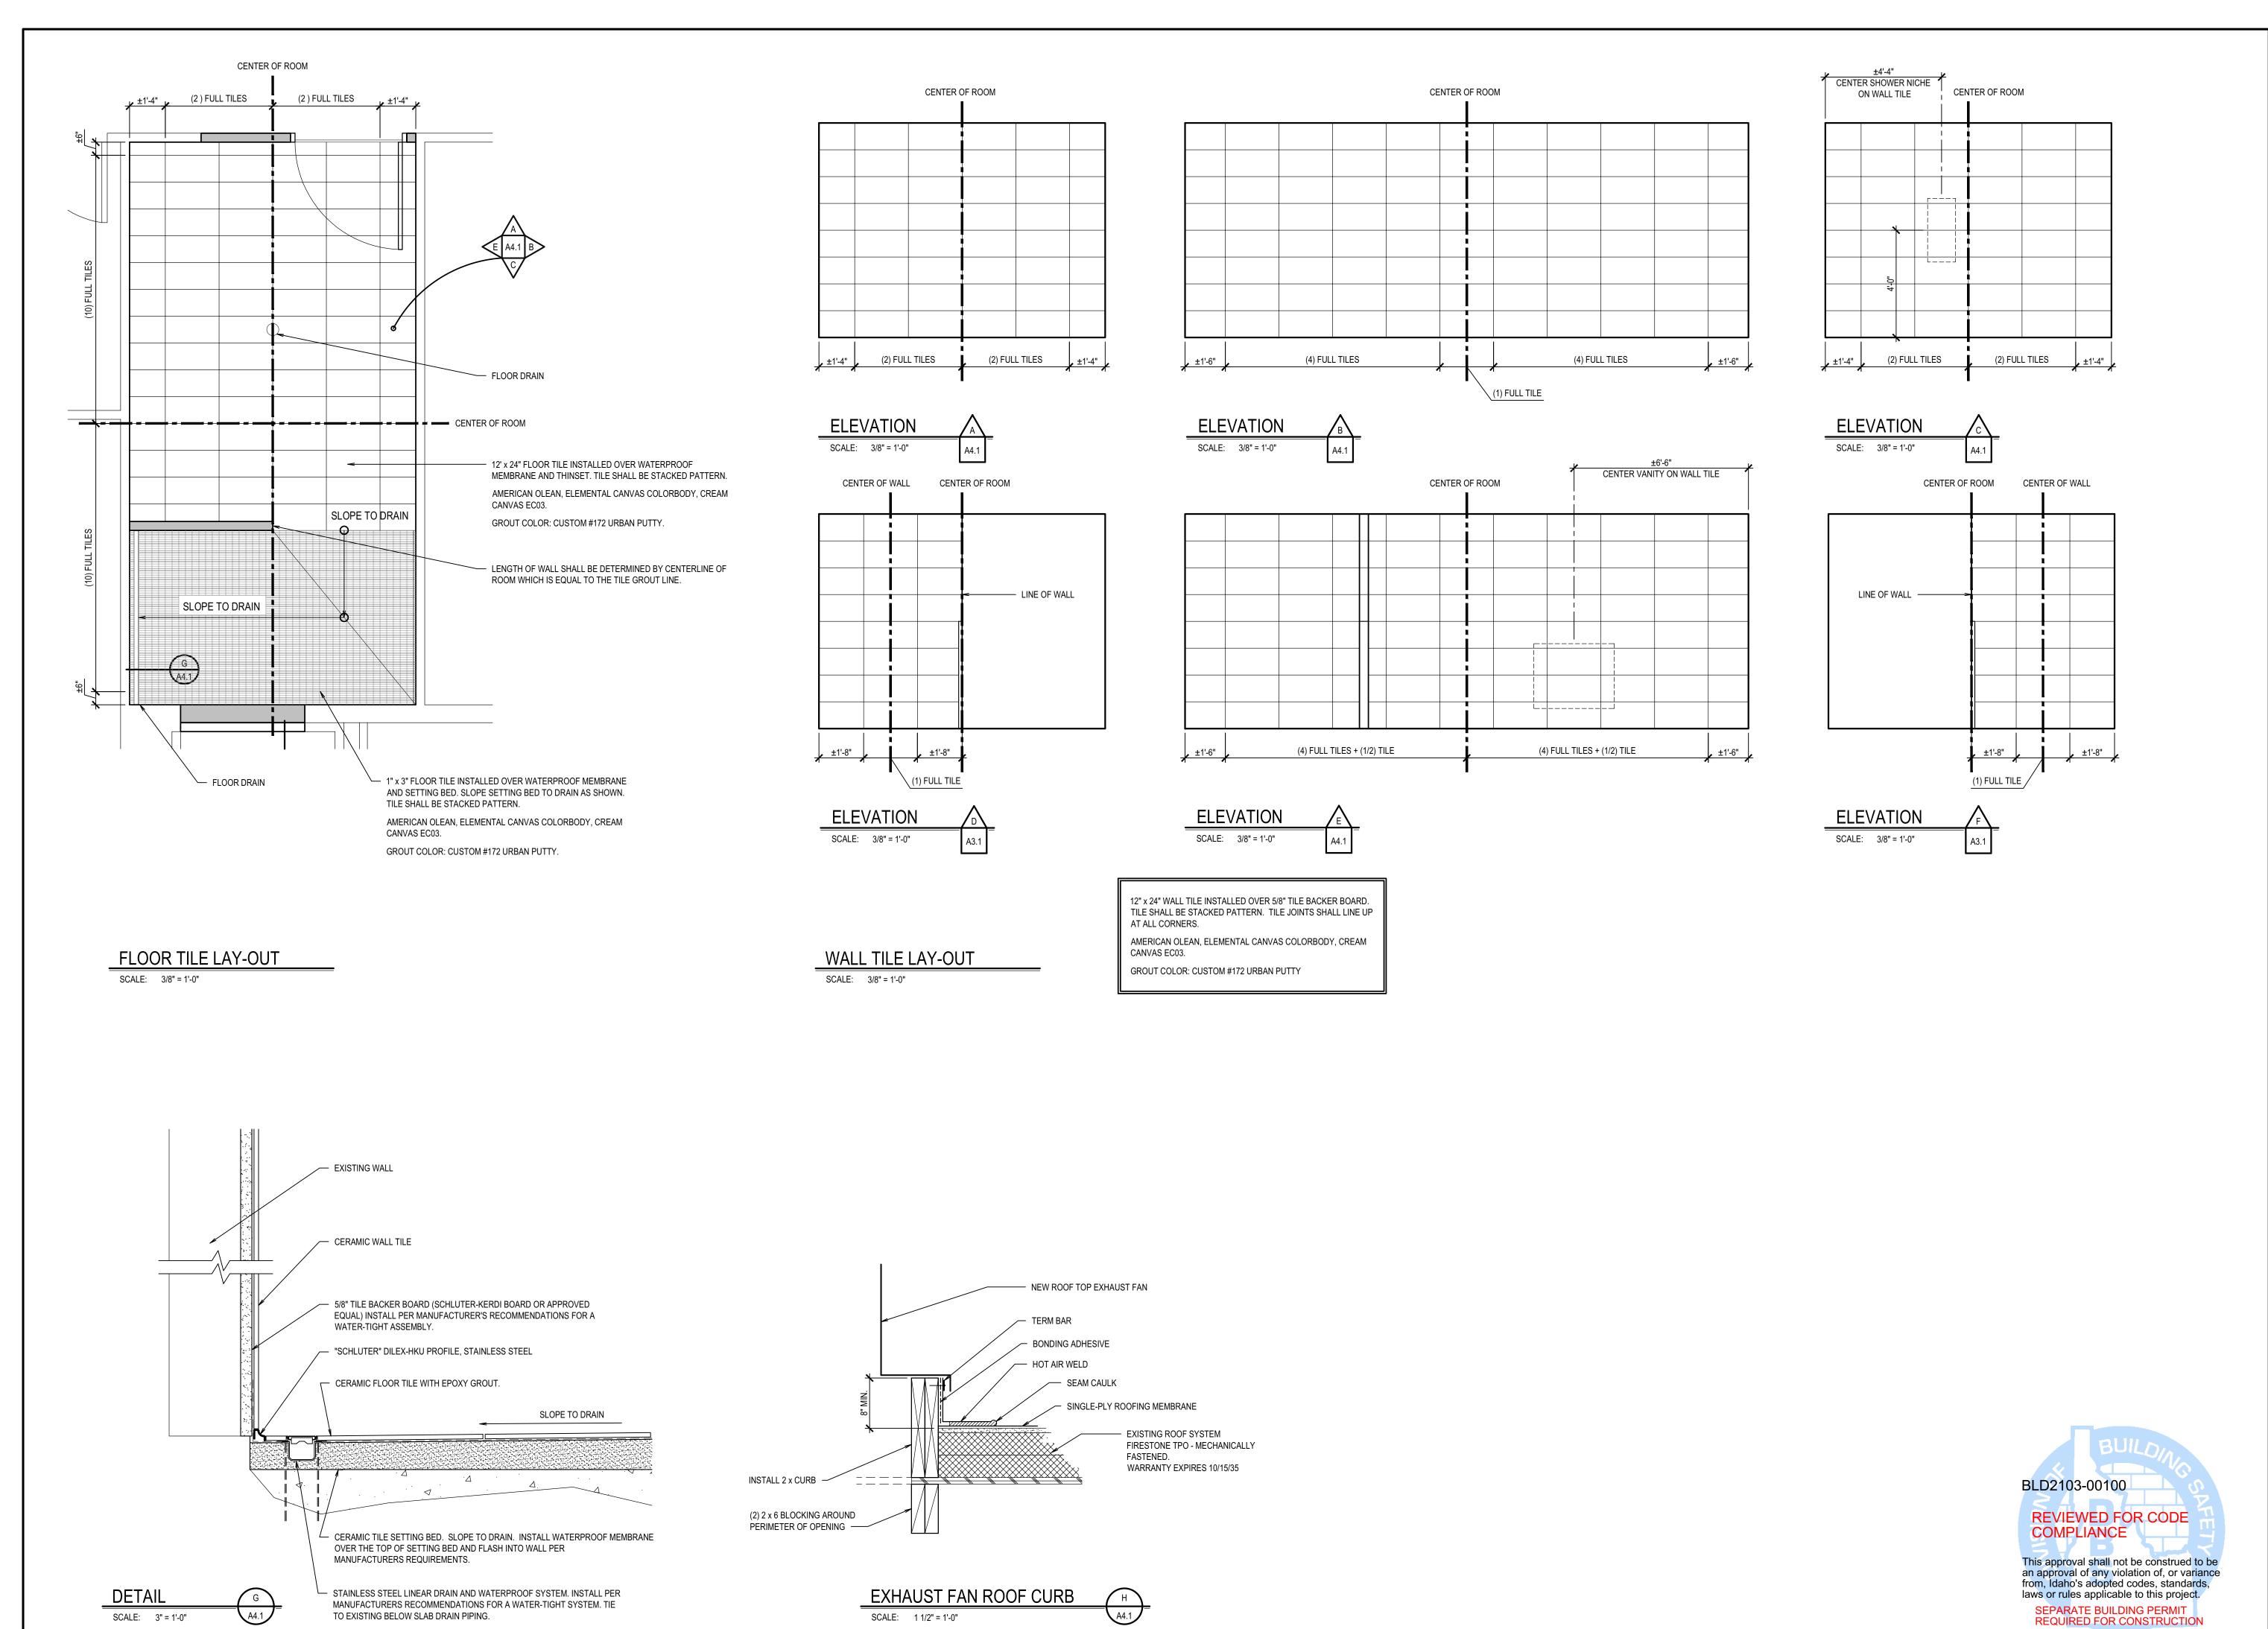

P.O. BOK 221 (F) 208-522-1

LOUNGE,

DPW PROJECT NO. 20
REMODEL STAFF |
IDAHO STATE VETERANS
1957 ALVIN RICKEN DRIVE - POC


REVISIONS

PROJECT NO.: 19027 DATE:


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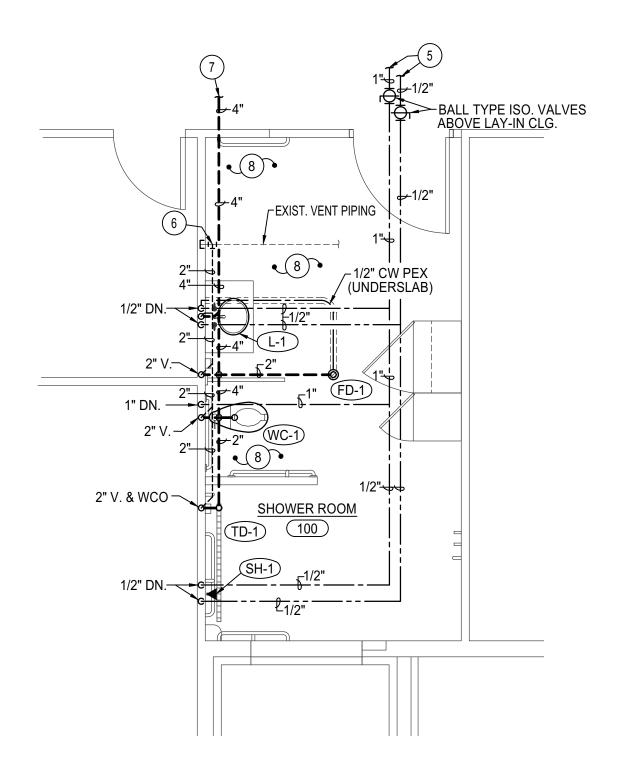
MARCH 2021 DRAWN BY: KP CHECKED BY: JHW

DRAWING NO.:

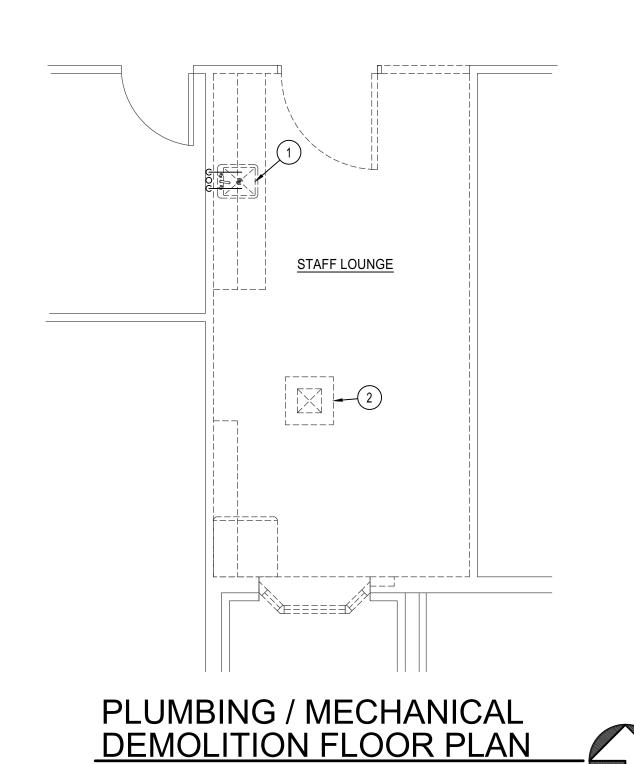

SCALE: 1/4" = 1'-0"



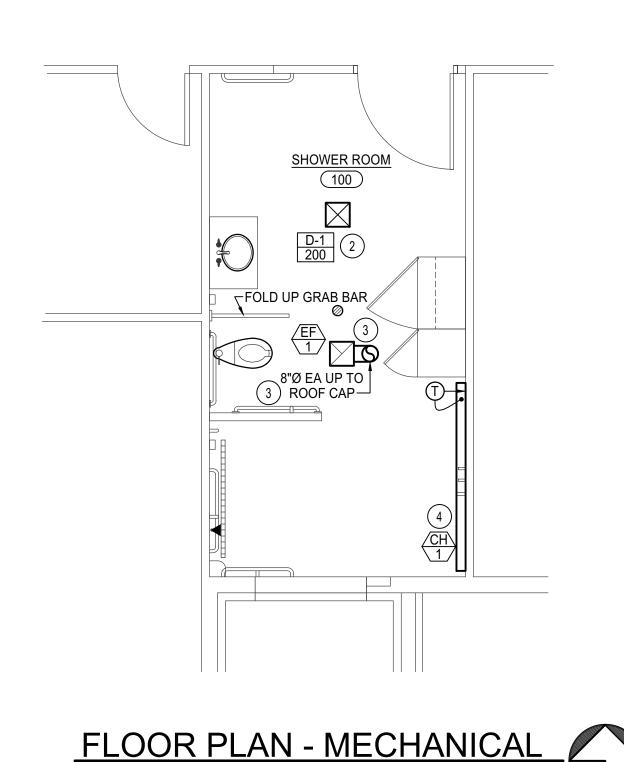




EXHAUST FAN SCHEDULE S.P.E. WATTS TWIN CITY MODEL T250 WITH BACKDRAFT DAMPER. 8"Ø EXHAUST DUCT TO FLAT 250 .25 127 CEILING MOUNTED TIMER ROOF CAP

ELECTRIC HEATER SCHEDULE											
SYM.	TYPE	BTU	KW	AMPS	CHAR	CONTROL	REMARKS				
CH 1	WALL MOUNTED COVE HEATER	4,095	1.2	5.8	208/60/1	WALL T-STAT	QMARK MODEL RCC12008C 94" LONG COVE HEATER WITH MOUNTING BRACKETS AND WALL T-STAT				

SCALE: 1/4" = 1'-0"

Mechanical Plan Review: APPROVED Final approval shall be based upon HVAC inspection for adherence to the 2018 IMC, 2018 IFGC, 2018 IRC Parts V & VI, Idaho Statute Title 54 Chapter 50, stamped approved plans and manufacturers installation instructions.


		GRI	LLE A	ND R	EGIS	TER:	SCHE	DULE	
SYM.	TYPE	SIZE	CFM RANGE	THROW PATTERN	CONSTR.	FINISH	BALANCING DAMPER	FIRE DAMPER	REMARKS
D-1	CEILING DIFFUSER	9x9	100-280	4-WAY	ALUM	COLOR BY ARCH.	NA	NA	PRICE MODEL AMD WITH BEVELED FRAME

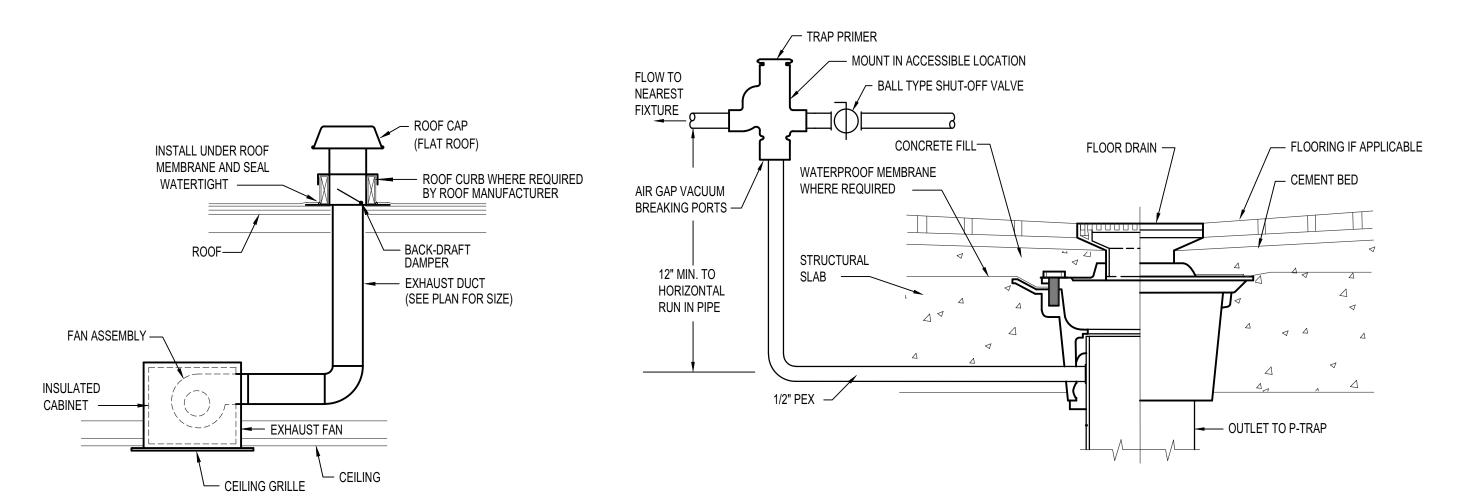


CEILING MOUNTED EXHAUST FAN DETAIL

TRAP PRIMER DETAIL

SYM.	FIXTURE SCHE DESCRIPTION	НОТ	COLD	WASTE	VENT
FD-1	2" FLOOR DRAIN WITH PRIMER - ZURN Z-415B WITH 5"Ø NICKEL-BRONZE STRAINER AND 2" DEEP SEAL P-TRAP WITH ZURN 1022 TRAP PRIMER MOUNTED UNDER NEAREST LAVATORY			2"	2"
(L-1)	ADA COUNTER TOP LAVATORY- CORIAN MODEL MODEL 810P, MOEN CA8302 BATTERY FAUCET WITH MOEN 104451 THERMOSTATIC MIXING VALVE, 1/2" BALL TYPE STOPS VALVES, 1-1/2" TAILPIECE &1-1/2" P-TRAP.	1/2"	1/2"	1-1/2"	1-1/2"
SH-1	ADA PACKAGED SHOWER -AMERICAN STANDARD MODEL 1662.221 COMMERCIAL SHOWER KIT WITH WITH T/P MIXING VALVE, HANDSHOWER, METAL HOSE & STANDARD HANDSHOWER. INSTALL AMERICAN STANDARD MODEL 1662.236 SLIDE / GRAB BAR (36" LONG) WITH PACKAGED SHOWER LISTED ABOVE.	1/2"	1/2"		
TD-1	TRENCH FLOOR DRAIN SYSTEM -SCHLUTER SYSTEMS KERDI-DRAIN WITH 2" NO-HUB END DRAIN OUTLET AND DEEP SEAL P-TRAP. LENGTH AS PER FLOOR PLANS REQUIRE. DRAIN TO BE LOCATED IN THE END OF THE DRAIN SYSTEM AND CONNECTED TO EXISTING 2" OR LARGER WASTE AND VENT PIPING. TILE CONTRACTOR TO PROVIDE DRAIN AND COORDINATE INSTALLATION WITH PLUMBING CONTRACTOR.			2"	2"
WC-1	ADA BARIATRIC FLUSH VALVE WATER CLOSET - AMERICAN STANDARD 3641001.020 FLUSHOMETER TOILET, WITH WHITE OPEN FRONT SEAT, SLOAN BPW 1100 FLUSH VALVE WITH BEDPAN WASHER AND CHINA BOLT CAPS.		1"	4"	2"

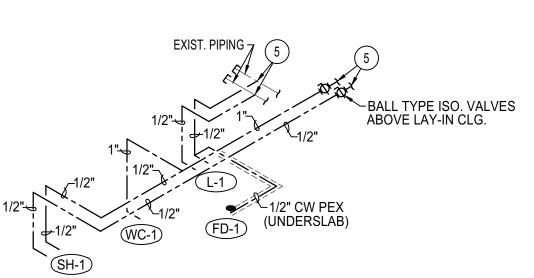

WATER PIPING ISOMETRIC NO SCALE

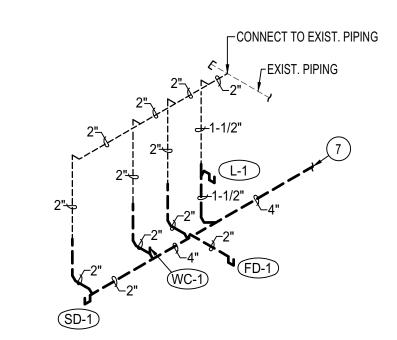

PLUMBING LEGEND

DESCRIPTION

VENT THRU ROOF

WALL CLEANOUT

CLEANOUT TO GRADE

SOIL OR WASTE PIPING

VENT LINE PIPING

BALL TYPE ISOLATION VALVE

DOMESTIC COLD WATER PIPING

DOMESTIC HOT WATER PIPING

HOT WATER RECIRC. PIPING

CLEANOUT

PIPE DROP

PIPE RISE

GAS PIPING

— CD ——— CONDENSATE DRAIN PIPING

CO

WCO

0----

COTG

WASTE & VENT PIPING ISOMETRIC NO SCALE

PLAN NOTES:

AVOID CONFLICTS.

- REMOVE EXISTING SINK AND CAP WASTE, WATER AND VENT PIPING IN WALL AS REQUIRED FOR NEW WALL FINISHES.
-) REMOVE EXISTING LAY-IN CEILING DIFFUSER AND REPLACE WITH NEW DIFFUSER IN NEW HARD CEILING & CONNECT TO EXISTING DUCT. REFER TO GRILLE & REGISTER SCHEDULE ON THIS SHEET FOR NEW DIFFUSER INFORMATION. EXTEND DUCT AS REQ'D.
- EXHAUST DUCT UP TO ROOF CAP ABOVE. SEAL ROOF PENETRATION WEATHERTIGHT. REFER TO DETAIL ON THIS
- 4) MOUNT COVE HEATER ON WALL IN LOCATION SHOWN 6" BELOV CEILING. CAREFULLY COORDINATE WITH OTHER TRADES TO
- 5) CONNECT NEW WATER PIPING TO EXISTING WATER PIPING LOCATED ABOVE CEILING. FIELD VERIFY EXACT LOCATION OF EXISTING PIPING.
- 6) CONNECT NEW 2" VENT PIPING TO EXISTING VENT PIPING ABOVE CEILING. FIELD VERIFY EXACT LOCATION OF EXISTING PIPING.
-) CONNECT NEW 4" WASTE LINE TO EXISTING 4" WASTE LINE LOCATED BELOW CORRIDOR CONCRETE SLAB FLOOR. FIELD VERIFY EXACT LOCATION OF EXISTING PIPING AND DIRECTION
- 8) SAWCUT EXISTING CONCRETE SLAB FLOOR AS REQUIRED TO INSTALL UNDERSLAB WASTE AND WATER PIPING SERVING NEW

PROJECT STA

A- THE CONTRACTOR SHALL CHECK AND VERIFY ALL DIMENSIONS AND CONNECTIONS ON THE JOB SITE. ALL WORK SHALL BE EXECUTED FROM MEASUREMENTS TAKEN AT THE SITE.

GENERAL NOTES:


B- THE MECHANICAL CONTRACTOR SHALL BE RESPONSIBLE TO INSURE PROPER CODE CLEARANCES FOR ELECTRICAL AND MECHANICAL ACCESS WHEN INSTALLING ANY EQUIPMENT SUPPLIED BY THE MECHANICAL CONTRACTOR.

C- IT IS CRITICAL THAT THIS CONTRACTOR COORDINATE EQUIPMENT LOCATIONS WITH PIPING, DUCTWORK, ELECTRICAL CONDUIT AND BUILDING STRUCTURE TO INSURE CODE COMPLIANCE.

D- CEILING DIFFUSERS ARE SHOWN IN APPROXIMATE LOCATIONS. REFER TO LIGHTING PLANS AND REFLECTED CEILING PLAN FOR EXACT LOCATIONS.

 E- DUCT DIMENSIONS CALLED OUT ON DRAWINGS ARE INSIDE FREE AREA DIMENSIONS. ACOUSTICAL DUCT LINER ARE TO BE ADDED TO OVERALL MEASUREMENTS.

- ALL DUCTWORK AND PIPING WHICH PASSES THRU FIRE RATED WALLS TO BE FIRE STOPPED WITH APPROVED FOAM OR SEALANT. REFER TO SPECIFICATIONS FOR APPROVED MANUFACTURES.

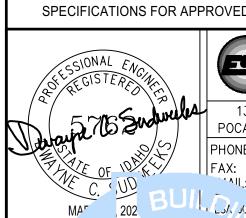

Engineered Systems Associates 1355 EAST CENTER POCATELLO, IDAHO 83201

(208) 233-0501 (208) 233-0529 👊: esa@engsystems.com 1 L3/1/30 MBER: 20005

BLD2103-00100

REVIEWED FOR CODE COMPLIANCE

This approval shall not be construed to be an approval of any violation of, or variance rom, Idaho's adopted codes, standards, laws or rules applicable to this project. SEPARATE BUILDING PERMIT REQUIRED FOR CONSTRUCTION

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MECHANICAL / REMODEL


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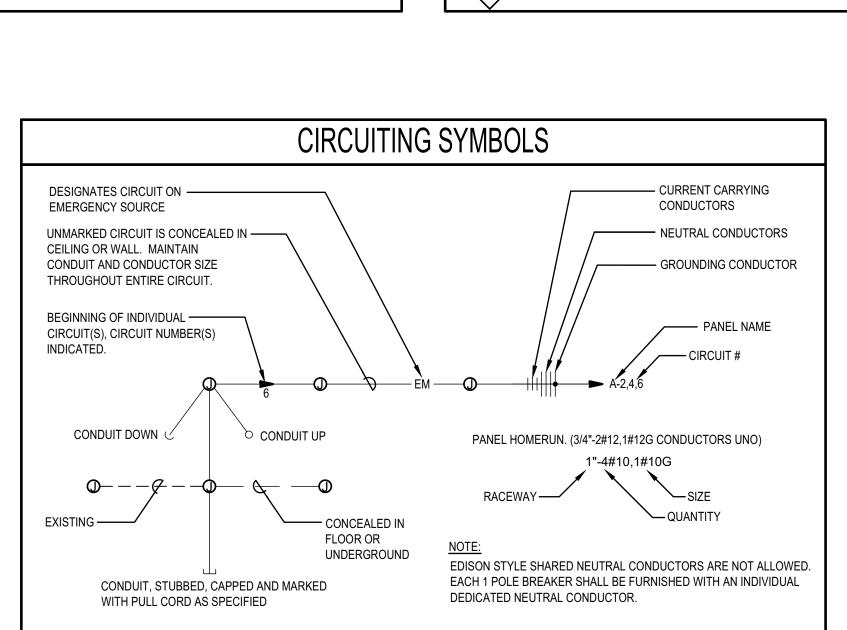
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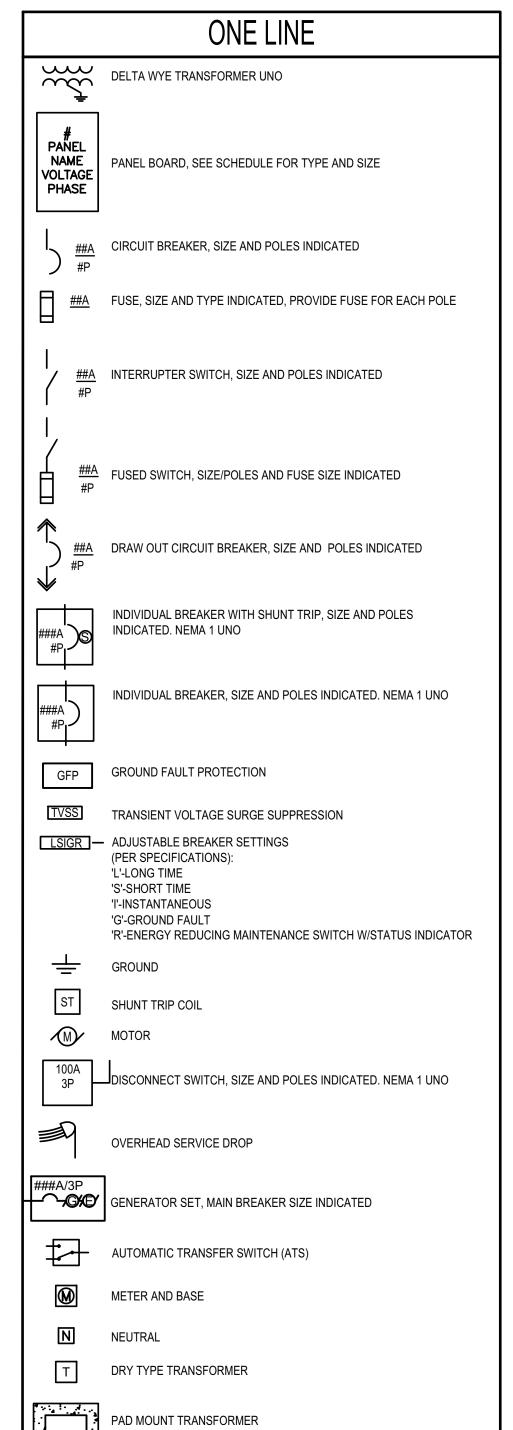
PROJECT NO, 19027 MARCH 2021 DRAWN BY:

CHECKED BY:

DRAWING NO.:





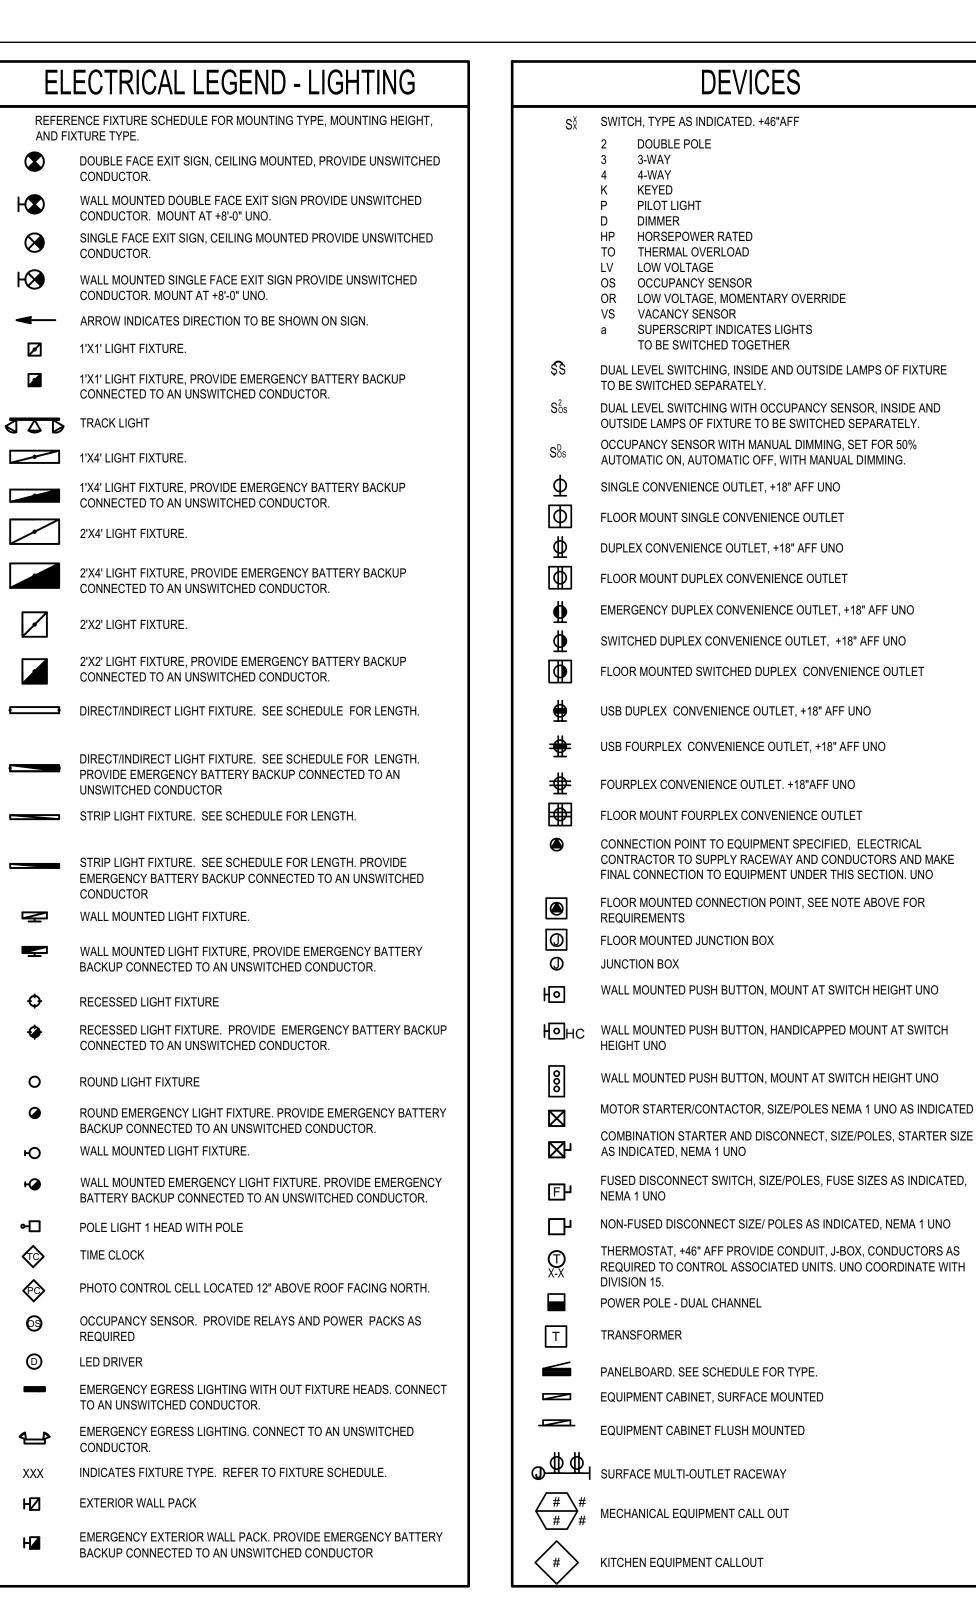

SECURITY CCTV CAMERA POWER SUPPLY CCTV SYSTEM POWER SUPPLY ADJUSTABLE CAMERA (PAN/TILT/ZOOM) FIXED CAMERA CAMERA IN OUTDOOR HOUSING ADJUSTABLE CAMERA (PAN/TILT/ZOOM) IN OUTDOOR HOUSING CCTV OUTLET, +18" UNO CEILING MOUNTED CCTV OUTLET SECURITY SYSTEM KEYPAD CONTROLLER COORDINATE BOX SIZE AND MUDRING WITH VENDOR CR CARD READER M CEILING MOUNTED MOTION SENSOR WALL MOUNTED MOTION SENSOR, MOUNTING HEIGHT INDICATED PANIC BUTTON - MOUNTED UNDER COUNTER THIS IS A STANDARD LIST OF COMMONLY USED ELECTRICAL SYMBOLS. SOME

OF THE SYMBOLS SHOWN MAY NOT HAVE BEEN USED IN THIS DRAWING

PACKAGE.

FIRE ALARM PULL STATION, +44" AFF WITH PRE-ALARM COVER FIRE ALARM HORN, +84" AFF UNO FIRE ALARM STROBE, +84" AFF UNO, STROBE INTENSITY INDICATED. 'C' INDICATES CEILING MOUNTED FIRE ALARM HORN/STROBE +84" AFF, UNO, STROBE INTENSITY INDICATED. 'C' INDICATES CEILING MOUNTED FID FIRE ALARM BELL, +84" AFF UNO. 'C' INDICATES CEILING MOUNTED FH FIRE ALARM CHIME, +84" AFF UNO. 'C' INDICATES CEILING MOUNTED FIRE ALARM CHIME/STROBE, +84" AFF UNO, STROBE INTENSITY INDICATED. 'C' INDICATES CEILING MOUNTED SPEAKER STROBE, +84" AFF UNO. 'C' INDICATES CEILING MOUNTED EOL END OF LINE RESISTOR FLOW SWITCH, PROVIDE MONITOR MODULE AS REQUIRED TAMPER SWITCH, PROVIDE MONITOR MODULE AS REQUIRED PRESSURE SWITCH, PROVIDE MONITOR MODULE AS REQUIRED FIRE SYSTEM ANNUNCIATOR, FLUSH MOUNTED +54"UNO POST INDICATOR VALVE, PROVIDE MONITOR MODULE AS REQUIRED DH ELECTROMAGNETIC DOOR HOLDER RELAY CONTROL MODULE MONITOR MODULE FIRE ALARM KNOX BOX FIRE ALARM CONTROL PANEL NAC EXTENDER PANEL FIRE/SMOKE DAMPER LED INDICATOR LIGHT, CEILING MOUNTED UNO LED INDICATOR LIGHT WITH TEST SWITCH, CEILING MOUNTED UNO DUCT-MOUNTED SMOKE DETECTOR SMOKE DETECTOR, CEILING MOUNTED UNO IONIZATION IN DUCT

COMMUNICATIONS

PHOTOELECTRIC

WG PROVIDE PROTECTIVE WIRE GUARD

R RFLAY

BS,BR BEAM DETECTOR, SENDER & RECEIVER

T	JUNCTION BOX FOR FUTURE TELEPHONE/DATA OUTLET. MOUNT AT 18" A.F.F. UNO. PROVIDE SINGLE-GANG MUD RING WITH BLANK COVER PLATE. PROVIDE 1" CONDUIT TO NEAREST ACCESSIBLE CEILING SPACE.

TELEPHONE/DATA OUTLET. MOUNT AT 18" A.F.F. UNO. PROVIDE 1" CONDUIT TO NEAREST ACCESSIBLE CEILING. INSTALL QUANTITY OF DATA (#D) AND TELEPHONE (#T) CABLES INDICATED TO THE NEAREST DATA RACK. PROVIDE (2) DATA CABLES IF A CABLE QUANTITY IS NOT

FLOOR MOUNTED BOX FOR FUTURE TELEPHONE/DATA OUTLET. JUNCTION BOX WITH SINGLE-GANG MUD RING. PROVIDE 1" CONDUIT TO NEAREST ACCESSIBLE CEILING SPACE. PROVIDE BLANK COVER

FLOOR MOUNTED TELEPHONE/DATA OUTLET. PROVIDE 1" CONDUIT TO NEAREST ACCESSIBLE CEILING. INSTALL QUANTITY OF DATA (#D) AND TELEPHONE (#T) CABLES INDICATED TO THE NEAREST DATA RACK. PROVIDE (2) DATA CABLES IF A CABLE QUANTITY IS NOT INDICATED. INTERCOM SYSTEM CALL BUTTON. +46" UNO.

CEILING MOUNTED SPEAKER WITH BACKBOX

WALL MOUNTED SPEAKER, WITH BACKBOX +80" UNO

VOLUME CONTROL, +46" UNO

TELEVISION OUTLET, +18" AFF UNO. PROVIDE 1-1/4" CONDUIT TO NEAREST ACCESSIBLE CEILING SPACE

CEILING MOUNTED TELEVISION OUTLET

TELEPHONE TERMINAL BOARD

CT-XX CABLE TRAY, 4" DEEP, WIRE BASKET STYLE, 'XX' INDICATES WIDTH PROVIDE ALL FITTINGS AND SUPPORT HARDWARE REQUIRED

NURSE STATION

\mathbb{N}	NURSE CALL CORRIDOR LIGHT WALL MOUNTED +90" UNO
N	NURSE CALL CORRIDOR LIGHT, CEILING MOUNTED
₩	NURSE CALL EMERGENCY STATION
₩, _	NURSE CALL STAFF REGISTRATION STATION

NURSE CALL DUTY STATION NURSE CALL MASTER STATION

NURSE CALL STAFF STATION NURSE CALL CODE BLUE STATION NURSE CALL PATIENT STATION

NURSE CALL DOUBLE BED STATION

COORDINATE BOX SIZE AND MUDRING WITH NURSE CALL VENDOR.

ELECTRICAL ABBREVIATIONS

A AMPERES

AC 6" ABOVE BACKSPLASH ABOVE FINISHED FLOOR

AFG ABOVE FINISHED GRADE

AMPS INTERRUPTING CAPACITY AUTOMATIC TRANSFER SWITCH AMERICAN WIRE GAUGE

BD BOTTOM OF DECK BOTTOM OF STRUCTURE

CEILING MOUNTED CB CIRCUIT BREAKER

CF COMPACT FLUORESCENT CKT CIRCUIT

CO CONDUIT ONLY, PROVIDE PULL-LINE CURRENT TRANSFORMER

DEMOLITION DEMO DEMOLITION

EXISTING ELECTRICAL CONTRACTOR EMERGENCY LIGHT

DETAIL DOUBLE TWIN TUBE

FUTURE FACP FIRE ALARM CONTROL PANEL

GROUND FAULT CIRCUIT INTERRUPTER GROUND FAULT INTERRUPTER

HIGH INTENSITY DISCHARGE HOA HAND-OFF-AUTO

HPS HIGH PRESSURE SODIUM HVAC HEATING, VENTILATION, & AIR CONDITIONING

ISOLATED GROUND IPCO IDAHO POWER COMPANY

J-BOX JUNCTION BOX

KVA KILOVOLT-KW KILOWATT KILO VOLT-AMP KWH KILOWATT HOUR

LCP LIGHTING CONTROL PANEL

MAIN CIRCUIT BREAKER MOTOR CONTROL CENTER MAIN DISTRIBUTION PANEL MAIN LUGS ONLY

MODULAR METERING CENTER METAL HALIDE MAIN SWITCH BOARD

MOUNTING

NFW NC NORMALLY CLOSED NEC NATIONAL ELECTRICAL CODE NOT IN CONTRACT NIGHT LIGHT

NORMALLY OPEN NTS NOT TO SCALE

OH OVERHEAD OS OCCUPANCY SENSOR

PC PHOTO-CONTROL PVC POLYVINYL CHLORIDE PWR POWER

RECEPTACLE RELOCATED

SF SQUARE FEET

TBD TO BE DETERMINED TIME DELAY RELAY TOE KICK TWISTED SHIELDED PAIR

TRIPLE TUBE TELEPHONE TERMINAL BOARD TYPICAL

UC UNDERCABINET UG UNDERGROUND U.N.O. UNLESS NOTED OTHERWISE

VA VOLT-AMPERE

INSTALL

WG WIRE GUARD

WEATHER PROOF/NEMA 3R PROVIDE AND INSTALL / PROVIDED AND INSTALLED BY / PROVIDE AND INSTALL INSTALLED/

> THIS IS A STANDARD LIST OF COMMONLY USED ELECTRICAL ABBREVIATIONS. SOME OF THE ABBREVIATIONS SHOWN ABOVE MAY NOT BE USED IN THIS DRAWING PACKAGE.



ELECTRICAL GENERAL NOTES

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PROJECT |

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IDVS

REVISIONS

234 S. Whisperwood Way Boise, ID 83709 208.384.0585 645 West 25th Street Idaho Falls, ID 83402 208.523.2862

A. THESE ELECTRICAL DRAWINGS ARE DIAGRAMMATIC IN NATURE; THEREFORE, THE ELECTRICAL CONTRACTOR SHALL COORDINATE ALL ELECTRICAL EQUIPMENT AND DEVICE LOCATIONS WITH ARCHITECTURAL, MECHANICAL, AND PLUMBING DIVISIONS PRIOR TO ROUGH-IN. REFER TO AND COORDINATE WITH ARCHITECTURAL, MECHANICAL, AND PLUMBING DRAWINGS FOR ADDITIONAL WORK THAT IS REQUIRED BY THE ELECTRICAL CONTRACTOR.

ALL CONDUIT AND JUNCTION BOXES ARE TO BE CONCEALED UNLESS LOCATED WITHIN DEDICATED ELECTRICAL OR MECHANICAL ROOMS. USE OF SURFACE MOUNTED RACEWAYS IN ALL OTHER SPACES MUST BE APPROVED BY THE ARCHITECT FOR EACH LOCATION. WHERE SURFACE RACEWAYS ARE APPROVED, UTILIZE WIREMOLD, OR APPROVED EQUAL, SURFACE MOUNTED RACEWAYS PAINTED TO MATCH SURROUNDING WALLS.

REFER TO ARCHITECTURAL ELEVATIONS FOR OUTLET HEIGHTS WHERE THE SPECIFIC OUTLET HEIGHT IS NOT INDICATED. REFER TO THE ELECTRICAL LEGEND FOR THE DEFAULT OUTLET HEIGHT WHEN NOT INDICATED ON ELEVATIONS OR ON AT THE DEVICES.

D. PROVIDE PULL-LINE IN ALL EMPTY CONDUITS.

E. TERMINATE ALL LOW-VOLTAGE CONDUITS WITH INSULATED THROAT BUSHING.

MECHANICAL EQUIPMENT INDICATED IS SHOWN IN AN APPROXIMATE LOCATION. COORDINATE EXACT LOCATION WITH MECHANICAL CONTRACTOR PRIOR TO ROUGH-IN.

ALL NON-LOCKING, 120-V, 15 AND 20-AMP RECEPTACLES SHALL BE LISTED TAMPER-RESISTENT RECEPTACLES PER NEC 406.12

FIRE ALARM:

INSTALL PLENUM RATED FIRE ALARM CONDUCTORS FROM ALL FIRE ALARM DEVICES INDICATED TO THE FIRE ALARM CONTROL PANEL OR NAC EXTENDER PANEL(S) AS REQUIRED. STUB 3/4" CONDUIT FROM DEVICE TO VOID ABOVE CEILING. PROVIDE NAC EXTENDER PANELS (QUANTITY AS REQUIRED) IN LOCATIONS INDICATED AND CIRCUITING AS REQUIRED FOR A COMPLETE INSTALLATION. CIRCUIT THE FIRE ALARM NOTIFICATION AND INITIATION DEVICES PER THE ELECTRICAL SPECIFICATIONS. FURNISH AND INSTALL ALL APPURTENANCES AND PROGRAMMING REQUIRED FOR A COMPLETE AND OPERATIONAL SYSTEM. REFER TO ELECTRICAL FIRE ALARM SPECIFICATIONS FOR SYSTEM REQUIREMENTS AND SUBMITTAL PROCEDURES.

SHEET INDEX

E0.0 ELECTRICAL COVER SHEET E0.1 LIGHTING COMPLIANCE ED1.0 DEMOLITION PLANS E1.0 FIRE ALARM PLAN

E2.0 INSTALLATION PLANS E3.0 ELECTRICAL DETAILS AND SCHEDULES

EGEND IS GENERAL IN NATURE. NOT ALL OF THE SYMBOLS SHOWN ARE USED

IN THIS PROJECT.


Electrical Plan Review Note:


The stamped documentation has been Reviewed for Compliance in accordance with the 2017 NEC as adopted by the State of Idaho by an Electrical Plan Review. This shall not be construed as an approval of any violation of, or variance from Idaho's adopted codes, laws, standards, or rules. Final approval will be based upon on-site electrical inspections to field verify compliance.


SEPARATE BUILDING PERMIT

REQUIRED FOR CONSTRUCTION

19027 **MARCH 2021** DRAWN BY: DBH CHECKED BY: BLD2103-00100 MNB REVIEWED FOR CODE DRAWING NO.: COMPLIANCE This approval shall not be construed to be an approval of any violation of, or variance from, Idaho's adopted codes, standards, laws or rules applicable to this project.

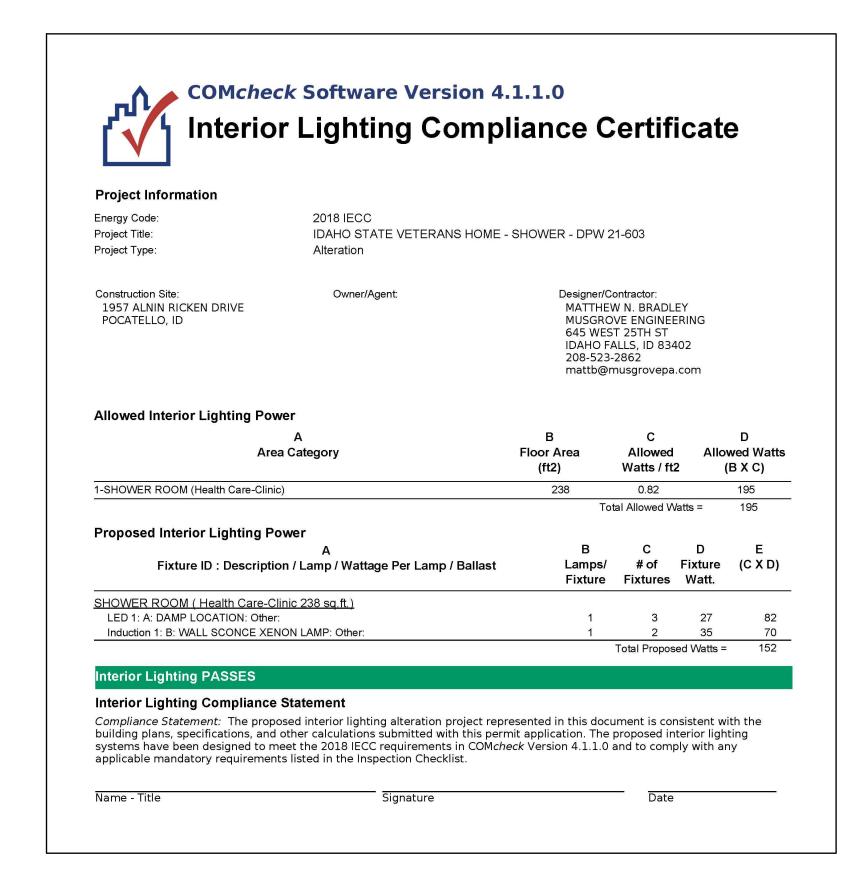

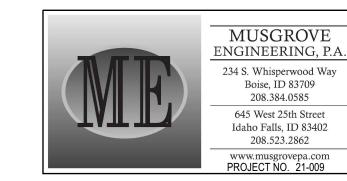

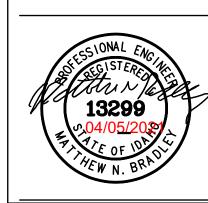

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P.O. (F) 20

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IDAHO STATE VETE ALVIN RICKEN DRIVE -

19027 MARCH 2021

IDVS

REVISIONS

DRAWN BY: DBH CHECKED BY: MNB

DRAWING NO.:

BLD2103-00100

REVIEWED FOR CODE COMPLIANCE

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SEPARATE BUILDING PERMIT REQUIRED FOR CONSTRUCTION

ENERGY CODE COMMISSIONING COMPLIANCE NOTES SECTION 408 SYSTEM COMMISSIONING IT SHALL BE THE ELECTRICAL CONTRACTOR'S RESPONSIBILITY TO PROVIDE ALL BELOW NOTED DOCUMENTS WITHIN 90 DAYS OF CERTIFICATE OF AS-BUILT DRAWINGS - DRAWINGS SHALL INCLUDE THE LOCATION AND PERFORMANCE DATA OF ALL PIECES OF MECHANICAL EQUIPMENT. OPERATING AND MAINTENANCE MANUALS - MANUALS SHALL INCLUDE THE FOLLOWING: SUBMITTAL DATA ON ALL PIECES OF EQUIPMENT REQUIRING MAINTENANCE. MANUFACTURER'S OPERATIONS AND MAINTENANCE DATA ON ALL PIECES OF EQUIPMENT. ROUTINE MAINTENANCE ACTIONS SHALL BE NAME AND ADDRESS AND PHONE NUMBER OF OF AT LEAST ONE (1) SERVICE PROVIDED. LIGHTING CONTROL SYSTEMS MAINTENANCE AND CALIBRATION INFORMATION INCLUDING WIRING DIAGRAMS, EQUIPMENT AND SYSTEM SCHEMATICS, AND CONTROL SEQUENCES OF OPERATIONS. DESIRED OR FIELD DETERMINED SETPOINTS SHALL BE PERMANENTLY RECORDED ON CONTROL DRAWINGS AT ALL CONTROL DEVICES, OR FOR DIGITAL CONTROL SYSTEMS, IN THE SYSTEM PROGRAMMING 5. A NARRATIVE ON HOW EACH LIGHTING SYSTEM IN INTENDED TO OPERATE, INCLUDING RECOMMENDED SETPOINTS. LIGHTING SYSTEM FUNCTIONAL TESTING REQUIREMENTS FUNCTIONAL TESTING - ALL AUTOMATIC LIGHTING CONTROL SYSTEM SHALL BE FULLY TESTED TO ENSURE THE CONTROL HARDWARE AND SOFTWARE ARE CALIBRATED, ADJUSTED, P[ROGRAMMED, AND IN PROPER WORKING CONDITION IN ACCORDANCE WITH THE CONSTRUCTION DOCUMENTS AND MANUFACTURER'S INSTALLATION INSTRUCTIONS. WHERE OCCUPANT SENSORS, TIME SWITCHES, PROGRAMMABLE CONTROLS, PHOTOSENSORS OR DAYLIGHTING CONTROLS ARE INSTALLED, THE FOLLOWING PROCEDURES SHALL BE PREFORMED: CONFIRM THAT THE PLACEMENT, SENSITIVITY AND TIME-OUT ADJUSTMENTS FOR OCCUPANT SENSORS YIELD ACCEPTABLE PERFORMANCE. CONFIRM THAT THE TIME SWITCHES AND PROGRAMMABLE SCHEDULE CONTROLS ARE PROGRAMMED TO TURN THE LIGHTS OFF. 3. CONFIRM THAT THE PLACEMENT AND SENSITIVITY ADJUSTMENTS FOR PHOTOSENSOR CONTROLS REDUCE ELECTRIC LIGHT BASED ON THE AMOUNT OF USABLE DAYLIGHT IN THE SPACE AS SPECIFIED. FINAL LIGHTING SYSTEM FUNCTIONAL REPORT - A REPORT OF TEST PROCEDURES AND RESULTS IDENTIFIED AS THE "FINAL LIGHTING CONTROL REPORT" SHALL BE DELIVERED TO THE BUILDING OWNER. THE REPORT SHALL INCLUDE THE FOLLOWING: LIST OF FUNCTIONAL TESTS USED DURING THE COMMISSIONING PROCESS ON EACH PIECE OF EQUIPMENT.


LIST OF DEFICIENCIES FOUND AND CORRESPONDING CORRECTIVE MEASURES EITHER IMPLEMENTED OR PROPOSED ON EACH PIECE OF

4. LIST OF EQUIPMENT NOT ABLE TO BE FUNCTIONALLY TESTED DUE TO CURRENT CLIMATE CONDITIONS. THESE PIECES OF EQUIPMENT WILL


RESULTS OF ALL FUNCTIONAL TESTS ON ALL PIECES OF EQUIPMENT.


FUNCTIONALLY TESTED ONCE CLIMATE CHANGES ALLOW.

OCCUPANCY:

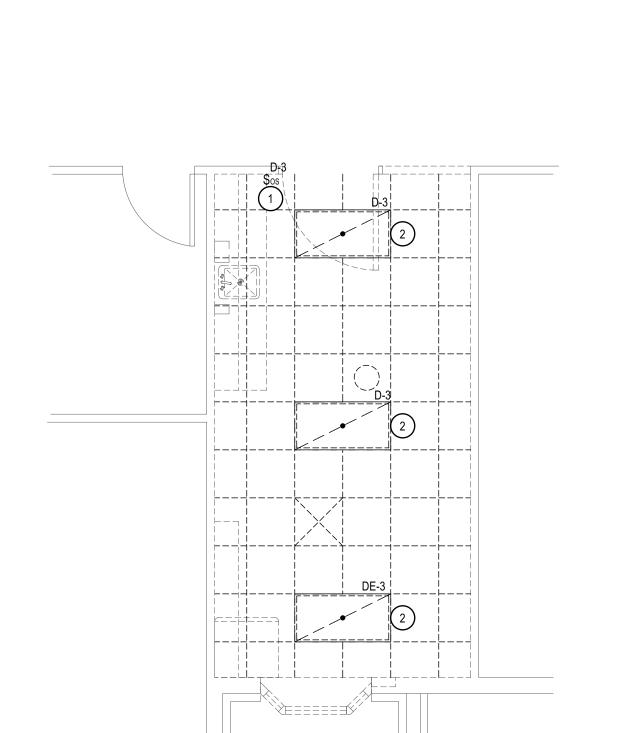


SCALE: 1/4" = 1'-0"

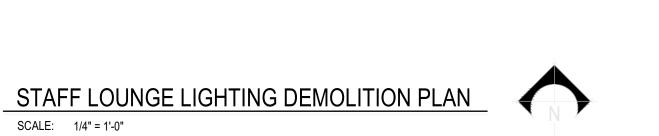

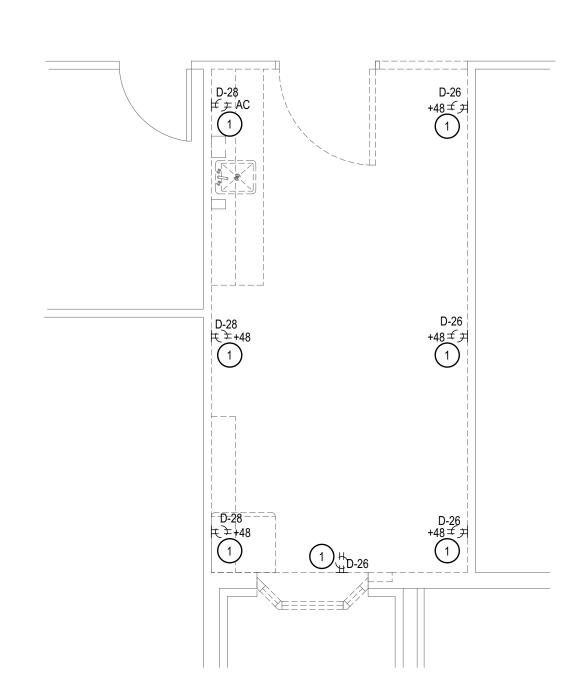




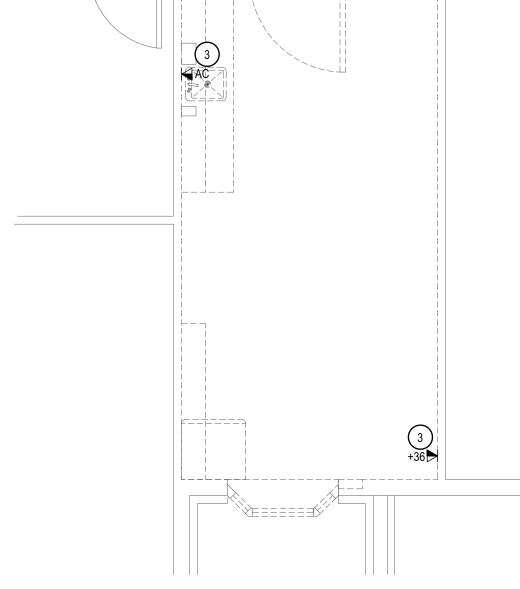

SCALE: 1/4" = 1'-0"



MUSGROVE ENGINEERING, P.A. 234 S. Whisperwood Way Boise, ID 83709 208.384.0585 645 West 25th Street Idaho Falls, ID 83402 208.523.2862 www.musgrovepa.com PROJECT NO. 21-009

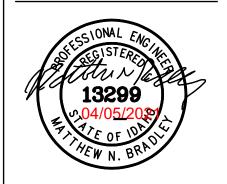

GENERAL NOTES:

- A. THIS DEMOLITION DRAWING IS INTENDED TO ASSIST THE ELECTRICAL CONTRACTOR IN ESTABLISHING AREAS REQUIRING DISCONNECTION, REMOVAL, OR RELOCATION OF ELECTRICAL EQUIPMENT, OUTLETS, WIRING, DEVICES, FIXTURES, ETC. AND MAY NOT INDICATE ALL OUTLETS, EXACT QUANTITIES OR EXTENT OF DEMOLITION AND RECONNECTION WHICH MAY BE REQUIRED. THE ELECTRICAL CONTRACTOR SHALL VISIT THE JOB SITE AND THOROUGHLY EXAMINE ALL REQUIRED DEMOLITION WORK AND INCLUDE ALL LABOR AND INCIDENTALS WHICH MAY BE NECESSARY TO PERFORM DEMOLITION RECONNECTION AND TEMPORARY POWER CONNECTIONS IN THE BID.
- B. ALL EXISTING WALLS AND DEVICES TO REMAIN U.N.O.

KEYED NOTES:

- 1. EXISTING DEVICES TO BE REMOVED. REMOVE ALL CONDUIT, CONDUCTORS, AND
- 3. EXISTING NETWORK CABLES TO BE PULLED OUT OF WALL AND LEFT ABOVE CEILING.

SYMBOL USED FOR NOTE CALLOUT.

- JUNCTION BOXES BACK TO SOURCE OR NEAREST UPSTREAM DEVICE THAT IS TO REMAIN. MAINTAIN CONTINUITY TO ALL DOWNSTREAM DEVICES THAT ARE TO REMAIN.
- EXISTING LIGHT FIXTURE TO BE REMOVED. REMOVE ALL CONDUIT, CONDUCTORS, AND JUNCTION BOXES BACK TO SOURCE OR NEAREST UPSTREAM DEVICE THAT IS TO REMAIN. MAINTAIN CONTINUITY TO ALL DOWNSTREAM DEVICES THAT ARE TO REMAIN.

VET.

PPW PROJECT NO. 20-603

REMODEL STAFF LOUNGE
IDAHO STATE VETERANS HOME
1957 ALVIN RICKEN DRIVE - POCATELLO, IDAHO


REVISIONS


PROJECT NO.: 19027 MARCH 2021 DRAWN BY: DBH

IDVS:

CHECKED BY: MNB DRAWING NO.:

BLD2103-00100 REVIEWED FOR CODE COMPLIANCE This approval shall not be construed to be an approval of any violation of, or variance from, Idaho's adopted codes, standards, laws or rules applicable to this project. SEPARATE BUILDING PERMIT REQUIRED FOR CONSTRUCTION

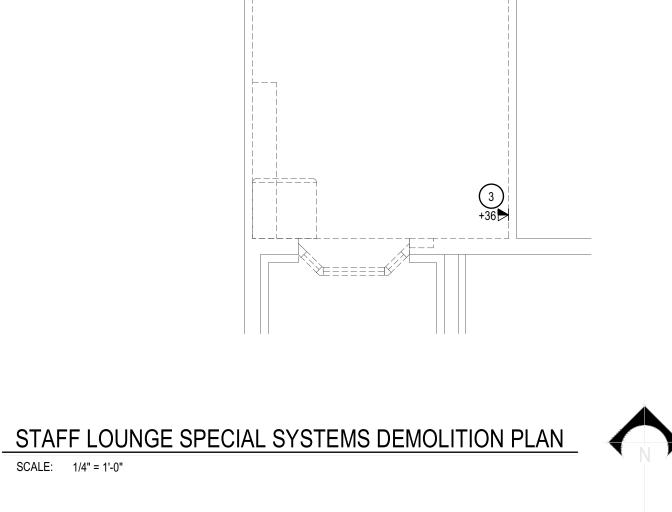

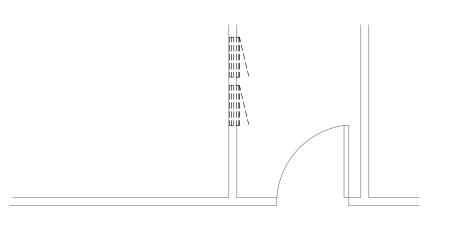





P.O. BOX 2212 - IDAHO I (F) 208-522-8785 (W) r


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REMODEL STAFF LOUNGE
IDAHO STATE VETERANS HOME
1957 ALVIN RICKEN DRIVE - POCATELLO, IDAHO


KEYED NOTES:

SYMBOL USED FOR NOTE CALLOUT.

INSTALL NEW FIRE ALARM STROBE. EXISTING FIRE ALARM SYSTEM MONITORED AND MAINTAINED BY FSI 800-866-3640.

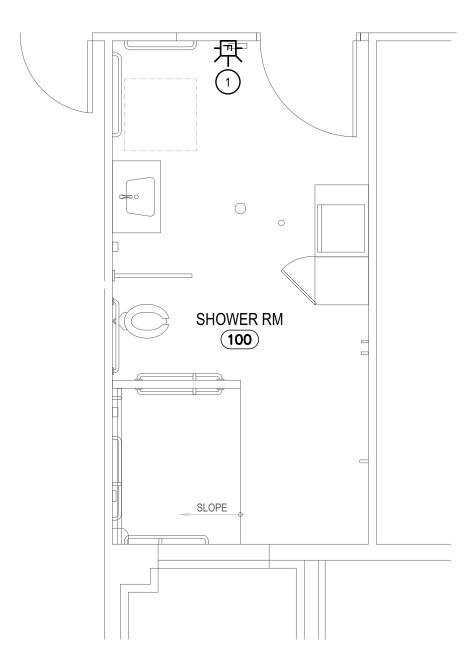

SHOWER ROOM FIRE ALARM INSTALLATION PLAN SCALE: 1/4" = 1'-0"

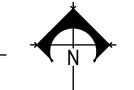



DATE: DBH


REVISIONS PROJECT NO.: 19027 MARCH 2021 DRAWN BY: CHECKED BY: MNB DRAWING NO.:


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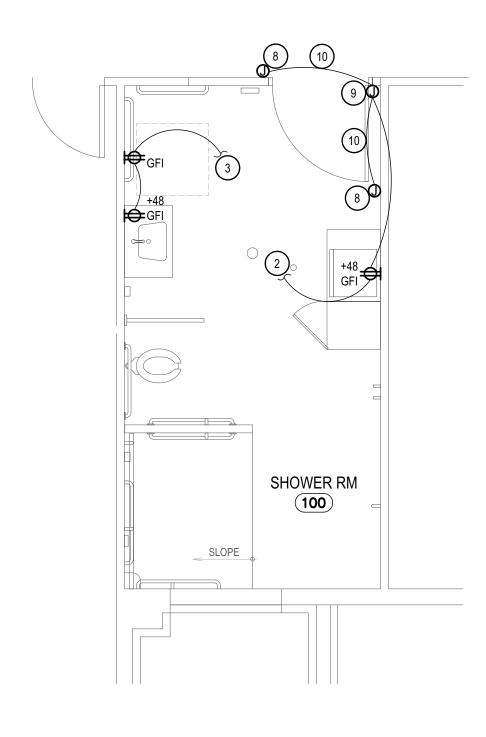
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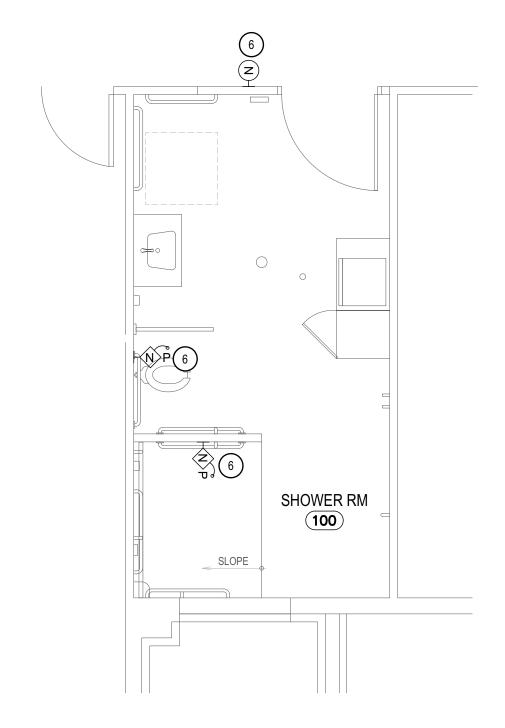




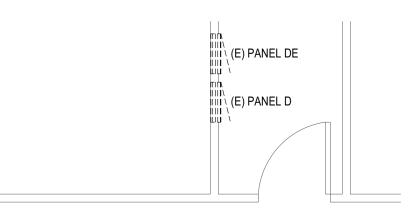

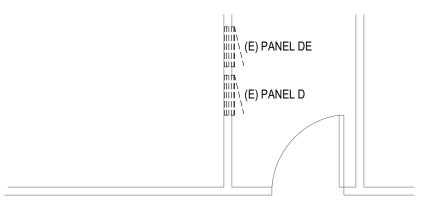


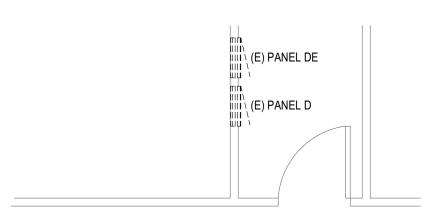

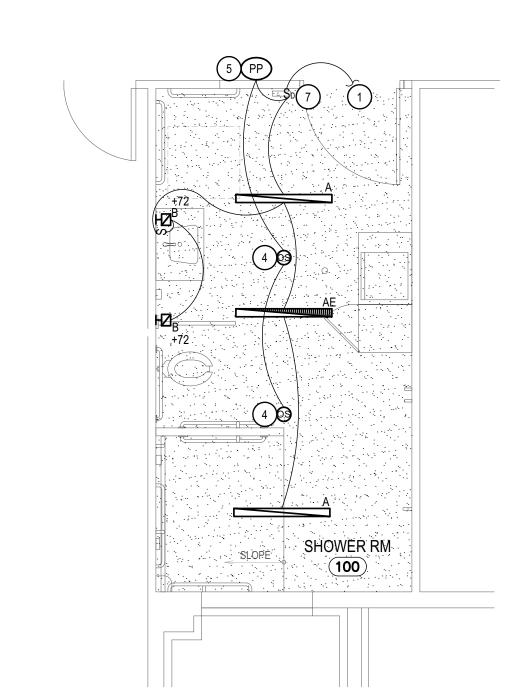





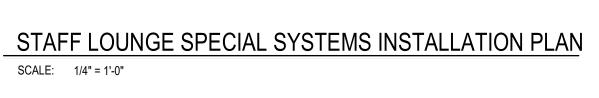





KEYED NOTES:

- 1. TO EXISTING LIGHT CIRCUIT DE-3 THIS AREA.
- 2. TO EXISTING POWER CIRCUIT D-26 THIS AREA.
- 3. TO EXISTING POWER CIRCUIT D-28 THIS AREA.
- 4. INSTALL OCCUPANCY SENSOR CEILING MOUNT, DUAL TECHNOLOGY, LOW VOLTAGE, SMALL MOUNT SENSOR SWITCH CM-PDT-9 OR EQUAL.
- INSTALL LOW VOLTAGE OCCUPANCY SENSOR POWER PACK SENSOR SWITCH PP16 OR EQUAL.
- MARSHAL INDUSTRIES. ELECTRICAL CONTRACTOR SHALL INCLUDES MARSHAL INDUSTRIES AS SUBCONTRACTOR FOR INSTALLATION OF THIS EQUIPMENT. CONTACT KARA JONES 1208-812-2252 FOR QUOTE.
- CONTROLLED BY THIS SWITCH.
- OF PUSHBUTTON. VERIFY INSTALLATION WITH OPERATOR INSTALLATION
- 9. INSTALL BRANCH CIRCUIT TO ADA DOOR OPERATOR, VERIFY INSTALLATION WITH OPERATOR INSTALLATION MANUAL.

BLD2103-00100

REVIEWED FOR CODE COMPLIANCE

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SEPARATE BUILDING PERMIT REQUIRED FOR CONSTRUCTION

SYMBOL USED FOR NOTE CALLOUT.

- 6. EXISTING RAULUND RCARE NURSE CALL SYSTEM IS MAINTAINED BY
- 7. INSTALL 0-10V DIMMER WITH 0-10 V CONDUCTORS TO ALL LIGHTS
- 8. INSTALL JUNCTION BOX FOR ADA OPERATOR PUSHBUTTON AT 48" TO TOP
- 10. 1/2"C BETWEEN DOOR OPERATOR AND PUSHBUTTONS WITH LOW VOLTAGE CABLE.

IDVS: REVISIONS PROJECT NO.: 19027 DRAWN BY: DBH CHECKED BY: MNB DRAWING NO.:

. 20-603 F LOUNGE


DPW PROJECT NO. 20
REMODEL STAFF L

IDAHO STATE VETERANS
1957 ALVIN RICKEN DRIVE - POCA

MARCH 2021

		3	PH	4	WIRE		AMPERE R	ATING:	225A	WI	ГН		MLO		MOUNTING: FLUSH	
скт	S OF DESIGN PANEL TYPE:	PANEL	BOARD				NEM A ENC	LOSURE TYP	'E:	1				PANE	L AIC RATING: 22000	
	NOTES:						REM ARKS:									
I. EX	STING CIRCUIT BREAKER															
		CKT	LOAD	LOAD	AMPS	ľ		LOAD (VA)		AMPS	3/	LOAD	LOAD	CKT	T	
CKT	DESCRIPTION	NOTE	VA		POLES		Α	В	С	POLE		AMPS	VA	NOTE	DESCRIPTION	СК
1	CORRIDOR LTS	1	1200	10.0	20	1	2300			20	Ĭ ₁	9.2	1100	1	CRAFTS/LIB LTS	2
3	MULTI-PURPOSE ROOM LTS	1	1170	9.8	20	1		2720		20	1	12.9	1550	1	BEDROOM LTS	4
5	BED ROOM LTS	1	1750	14.6	20	1			3500	20	1	14.6	1750	1	BEDROOMLTS	6
7	BED ROOM LTS	1	1750	14.6	20	1	3500] '	L-COMPANIE -	20	1	14.6	1750	1	BEDROOMLTS	8
9	BED ROOM LTS	1	1750	14.6	20	1		1750		20	1	0.0		1	SPARE	10
11	SPARE	1		0.0	20	1			0	20	1	0.0		1	SPARE	12
13	BED ROOM LTS	1	1000	8.3	20	1	2000] '		20	1	8.3	1000	1	BEDROOM OUTLETS	14
15	BED ROOM LTS	1	1000	8.3	20	1		2000		20	1	8.3	1000	1	BEDROOM OUTLETS	16
17	BED ROOM LTS	1	1000	8.3	20	1			2000	20	1	8.3	1000	1	BEDROOM OUTLETS	18
19	BED ROOM LTS	1	1000	8.3	20	1	2000			20	1	8.3	1000	1	BEDROOM OUTLETS	20
21	BED ROOM LTS	1	1000	8.3	20	1		2000		20	1	8.3	1000	1	BEDROOM OUTLETS	22
23	BED ROOM LTS	1	1000	8.3	20	1		_	2000	20	1	8.3	1000	1	BEDROOM OUTLETS	24
25	CORRIDOR OUTLETS	1	1000	8.3	20	1	2000			20	1	8.3	1000	1	CRAFTS ROOM	26
27	CORRIDOR OUTLETS	1	1000	8.3	20	1		2000		20	1	8.3	1000	1	CRAFTS ROOM	28
29	CHAPEL/MULTI-PURPOSE	1	1000	8.3	20	1			2000	20	1	8.3	1000	1	ISOLATION ROOM	30
31	WORK ROOM OUTLETS	1	1000	8.3	20	1	1000			20	1	0.0		1	SPARE	32
33	WORK ROOM OUTLETS	1	1000	8.3	20	1		1000		20	1	0.0		1	SPARE	34
35	SPARE	1		0.0	20	1			0	20	1	0.0		1	SPARE	36
37	SPARE	1		0.0	20	1	0		r	20	1	0.0		1	SPARE	38
39	SPARE	1		0.0	20	1		0		20	1	0.0		1	SPARE	40
	SPARE	1		0.0	20	1			0	20	1	0.0		1	SPARE	42


TYPE	DESCRIPTION	MTG.	LAMPS	WATTS	MFG. & CATALOG NUMBER	OR EQUAL BY	NOTE
	MVOLT, 5000 LUMENS, 4000K, 80 CRI				LITHONIA FMLWL-8-35K-MVOLT	EATON	
Α	DAMP LOCATION RATED, HIGH OUTPUT LED	SURFACE	LED	27.4		HE WILLIAMS	1
						LIGHTOLIER	
	CHROME WALL SCONCE		INCLUDED		HUDSON VALLEY LIGHTING		
В	300 LUMENS, 3200K	SCONCE	XENON	35	3901-AGB		1
			35W T4 G9				
SHTING FIX	TURE SCHEDULE NOTES:						
	1 SUBSTITUTIONS WILL BE ALLOWED IF SUBMITTE	D PRIOR TO BID	DATE BY THE	GREATER	OF: 7 BUSINESS DAYS OR THE TIME PER	RIOD SPECIFIED BY	
	DIVISION 1 SPECIFICATIONS, AND IF DEEMED EC	OUAL BY THE EN	GINEER THE	CONTRAC	TOR IS RESPONSIBLE FOR ENSURING SU	IBSTITUTED FIXTURES	
	MEET OR EXCEED THE SPECIFICATIONS OF THE						

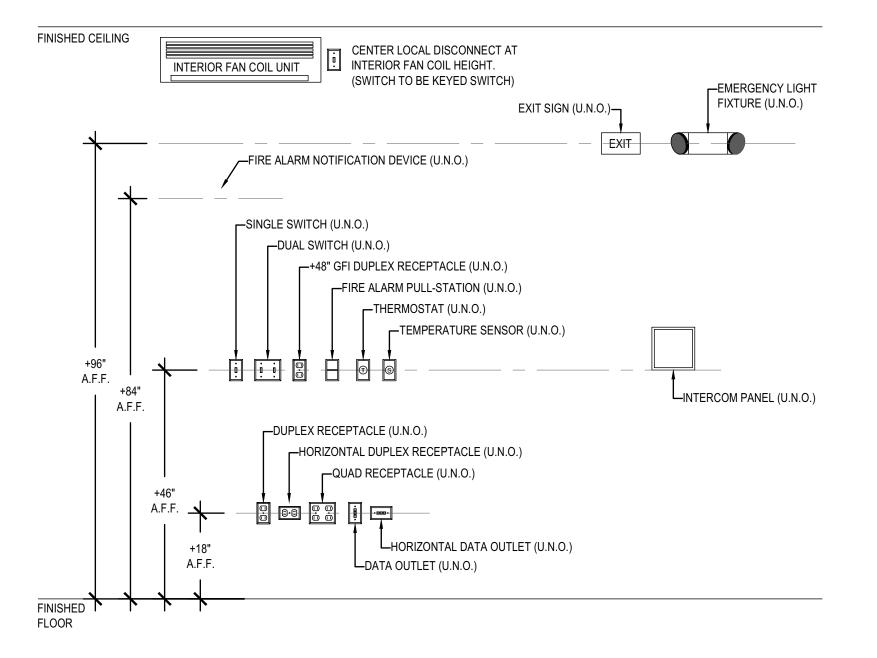

DETAIL GENERAL NOTES:

PROVIDE FRAMING AS REQUIRED.

STANDARD MOUNTING HEIGHTS

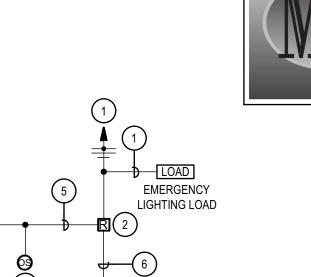

DETAIL KEYED NOTES:

SYMBOL USED FOR NOTE CALLOUT.

- 1. UNSWITCHED LINE VOLTAGE POWER FEED FROM LOCAL PANEL.
- POWER/RELAY PACK RATED FOR UP TO 3 SENSORS AND 15A LINE VOLTAGE SWITCHING. PROVIDE QUANTITY AS REQUIRED FOR A COMPLETE INSTALLATION.
- LOW VOLTAGE OCCUPANCY SENSOR, UP TO 3 PER POWER PACK. PROVIDE WITH ISOLATED NO/NC AUXILIARY CONTACTS FOR HVAC INTERLOCK. QUANTITY AS INDICATED ON PLANS. LOCATION PER THE MANUFACTURERS RECOMMENDATIONS.
- 4. WALL MOUNTED LINE VOLTAGE SNAP SWITCH(ES). QUANTITY AND LOCATION AS INDICATED ON PLANS.
- 5. LOW VOLTAGE POWER AND CONTROL CONDUCTORS AS REQUIRED FOR A COMPLETE INSTALLATION.
- 6. LINE VOLTAGE SWITCHED LEG FROM RELAY PACK TO LOCAL WALL SWITCHES.
- 7. LINE VOLTAGE SWITCHED LEG FROM SWITCHES TO LIGHTING LOAD.
- 8. SECOND SWITCH FOR DUAL LEVEL LIGHTING WHERE INDICATED ON PLANS.

OCCUPANCY SENSORS DETAIL



MUSGROVE ENGINEERING, P.A. 234 S. Whisperwood Way Boise, ID 83709 208.384.0585

> 645 West 25th Street Idaho Falls, ID 83402 208.523.2862

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4ND

DPW PROJECT NO. 20
REMODEL STAFF |

IDAHO STATE VETERANS

1957 ALVIN RICKEN DRIVE - POCA

REVISIONS

PROJECT NO.: 19027 MARCH 2021 DRAWN BY: DBH CHECKED BY: MNB

IDVS:

DRAWING NO.:

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